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COMMERCIAL + MULTIFAMILY RESIDENTIAL  
 ARCHITECTURAL DESIGN & INTERIOR DESIGN  
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**FAIRFIELD INN & SUITES**  
 BY  
 MARRIOTT  
 290 POWER DRIVE,  
 BATESVILLE, MS 38606

SEAL  
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 BATESVILLE, MS 38606

CONTRACTOR'S REVIEW  
 BYRON B. CARSON, JR., ARCHITECT - 5/14/14  
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CONSULTANTS

100% NOT FOR SET CONSTRUCTION

NO.	DATE	DESCRIPTION
1	06/23/2015	30% REVIEW SET
2	11/22/2015	50% REVIEW SET
3	1/22/2016	100% REVIEW SET

PROJECT NUMBER:	15180
DRAWING NAME:	
SHEET NAME:	
RATED WALL ASSEMBLIES	
DRAWN BY/CHK:	BBC
CHECKED BY:	BBC
DATE:	12-22-15
SCALE:	AS NOTED
DRAWING NUMBER:	G100

7. Wall and Partition Fittings and Accessories\* — (Optional, Not shown) —Nominal 1/2 in. thick, 4 ft wide panels, for optional use as an additional layer on one or both sides of the assembly. Panels attached in accordance with manufacturer's recommendations. When the QR-510 panel is installed between the steel framing and the UL Classified gypsum board, the required UL Classified gypsum board layer(s) is/are to be installed as indicated as to fastener type and spacing, except that the required fastener length shall be increased by a minimum of 1/2 in. Not evaluated or intended as a substitute for the required layer(s) of UL Classified Gypsum Board.

a. Furring Channels — Formed of No. 25 MSG galv steel, 2-3/8 in. wide by 7/8 in. deep, spaced 24 in. OC perpendicular to studs. Channels secured to studs as described in Item b. Ends of adjoining channels are overlapped 6 in. and tied together with double strand of No. 18 SWG galv steel wire near each end of overlap. As an alternate, ends of adjoining channels may be overlapped 6 in. and secured together with two self-tapping #6 framing screws, min. 7/16 in. long at the midpoint of the overlap, with one screw on each flange of the channel.

b. Steel Framing Members\* — Used to attach furring channels (Item a) to studs (Item 1). Clips spaced 48 in. OC, and secured to studs with 1-5/8 in. wide by 1-1/4 in. deep, fabricated from No. 20 MSG galv steel. Attached to floor and ceiling with fasteners, 24 in. OC, max.

c. Resilient Channel — 25 MSG galv steel resilient channels spaced vertically max 24 in. OC, flange portion attached to each intersecting stud with 1/2 in. long Type S-12 pan head steel screws.

4A. Gypsum Board\* — (As alternate to Item 4) — Nom 5/8 in. thick gypsum panels with beveled, square or tapered edges, applied vertically or horizontally. Vertical joints centered over studs and staggered one stud cavity on opposite sides of studs. Horizontal edge joints and horizontal butt joints on opposite sides of studs need not be staggered or backed. Panels attached to steel studs and floor runner with 1 in. long Type S steel screws spaced 8 in. OC when applied horizontally, or 8 in. OC along vertical and bottom edges and 12 in. OC in the field when panels are applied vertically. When used in widths other than 48 in., gypsum panels to be installed horizontally.

CANADIAN GYPSUM COMPANY—Types AR, C, IP-AR, IP-X1, IP-X2, IP-C-AR, SCX, SHX, WRC or WRX.  
 CERTAINTIED GYPSUM INC—ProRoc Type X.  
 CERTAINTIED GYPSUM CANADA INC—ProRoc Type X.  
 G-P GYPSUM CORP, SUB OF GEORGIA-PACIFIC CORP—Types DAP, DGG, IP-X2, IP-C-AR, SCX, SHX, WRC or WRX.  
 UNITED STATES GYPSUM CO—Type AR, C, IP-AR, IP-X1, IP-X2, IP-C-AR, SCX, SHX, WRC or WRX.  
 USG MEXICO S A DE C V—Type AR, C, IP-AR, IP-X1, IP-X2, IP-C-AR, SCX, SHX, WRC or WRX.

**4A**  
 NTS  
**UL # U465 1-HR MTL. STUD NON-BEARING**

4. Gypsum Board\* — 5/8 in. thick, 4 ft wide, attached to steel studs and floor and ceiling track with 1 in. long, Type S steel screws spaced 8 in. OC, along edge of board and 12 in. OC in the field of the board. Joints oriented vertically and staggered on opposite sides of the assembly. When attached to Item 6 (resilient channels) or 6A (furring channels), wallboard is screw attached to furring channels with 1 in. long, Type S steel screws spaced 12 in. OC.

AMERICAN GYPSUM CO—Types AG-C, AGX-1  
 BEIJING NEW BUILDING MATERIALS PUBLIC LTD CO—Type DBX-1.  
 CANADIAN GYPSUM COMPANY—Types AR, C, IP-AR, IP-X1, IP-X2, IP-C-AR, SCX, SHX, WRC or WRX.  
 CERTAINTIED GYPSUM INC—Types 1, EGRG, ProRoc Type X, ProRoc Type C.  
 CERTAINTIED GYPSUM CANADA INC—ProRoc Type C, ProRoc Type X or ProRoc Type Abuse-Resistant.  
 FEDERAL GYPSUM CO—PlasterRock  
 G-P GYPSUM CORP, SUB OF GEORGIA-PACIFIC CORP—Types 5, 9, C, DAP, DD, DA, DGG, DS, GPFS6.  
 LAFARGE NORTH AMERICA INC—Types LGFC2, LGFC2A, LGFC6, LGFC6A, LGFC-C, LGFC-C/A.  
 NATIONAL GYPSUM CO—Types FSK, FSK-C, FSK-G, FSK-Q, FSK-W, G, FSW, FSW-3, FSW-5, FSW-6.  
 PABCO BUILDING PRODUCTS L L C, DBA PABCO GYPSUM—Type PG-C, PG-11 or PG-9.  
 PANEL REY S A—Type PRX.  
 SIAM GYPSUM INDUSTRY (SARABURI) CO LTD—Type EX-1  
 TEMPLE-INLAND FOREST PRODUCTS CORP—Type X, Veneer Plaster Base — Type X, Water Rated — Type X, Sheathing — Type X, Soffit — Type X, TG-C.  
 UNITED STATES GYPSUM CO—Type AR, C, FRX-G, IP-AR, IP-X1, IP-X2, IP-C-AR, SCX, SHX, WRC or WRX.  
 USG MEXICO S A DE C V—Type AR, C, IP-AR, IP-X1, IP-X2, IP-C-AR, SCX, SHX, WRC or WRX.

**2C**  
 NTS  
**UL # U451 1-HR MTL. STUD NON-BEARING**

7. Caulking and Sealants\* — (Optional, not shown) —A bead of acoustical sealant applied around the partition perimeter for sound control.

UNITED STATES GYPSUM CO—Type AS.

8. Wall and Partition Fittings and Accessories\* — (Optional, Not shown) —Nominal 1/2 in. thick, 4 ft wide panels, for optional use as an additional layer on one or both sides of the assembly. Panels attached in accordance with manufacturer's recommendations. When the QR-510 panel is installed between the steel framing and the UL Classified gypsum board, the required UL Classified gypsum board layer(s) is/are to be installed as indicated as to fastener type and spacing, except that the required fastener length shall be increased by a minimum of 1/2 in. Not evaluated or intended as a substitute for the required layer(s) of UL Classified Gypsum Board.

QUIET SOLUTION INC—Type QuietRock QR-510.

\*Bearing the UL Classification Mark

Design No. U465  
 April 02, 2008  
 Nonbearing Wall Rating —1 HR.

1. Floor and Ceiling Runners — (not shown) —Channel shaped runners, 3-5/8 in. wide (min), 1-1/4 in. legs, formed from min No. 25 MSG galv steel, attached to floor and ceiling with fasteners spaced 24 in. OC max.

2. Steel Studs — Channel shaped, 3-5/8 in. wide (min), 1-1/4 in. legs, 3/8 in. folded back returns, formed from min No. 25 MSG galv steel spaced 24 in. OC max.

3. Bolts and Blankets\* — (Optional) —Mineral wool or glass fiber bolts partially or completely filling stud cavity.  
 See Bolts and Blankets (BZJ2) category for names of Classified companies.

3A. Fiber, Sprayed\* — As an alternate to Bolts and Blankets (Item 3) —Spray applied cellulose material. The fiber is applied with water to completely fill the enclosed cavity in accordance with the application instructions supplied with the product. Nominal dry density of 3.0 lb/ft3. Alternate application method: The fiber is applied with U.S. Greenfiber LLC Type AD100 hot melt adhesive at a nominal ratio of one part adhesive to 6.6 parts fiber to completely fill the enclosed cavity in accordance with the application instructions supplied with the product. Nominal dry density of 2.5 lb/ft3.

U S GREENFIBER L L C—Cocon2 Stabilized or Cocon-FRM (Fire Rated Material)

3B. Fiber, Sprayed\* — As an alternate to Bolts and Blankets (Item 3) and Item 3A — Spray applied cellulose insulation material. The fiber is applied with water to interior surfaces in accordance with the application instructions supplied with the product. Applied to completely fill the enclosed cavity. Minimum dry density of 4.3 pounds per cubic ft.

5A. Gypsum Board\* — (As an alternate to Item 5) —Nom 3/4 in. thick, 4 ft wide, installed as described in Item 5 with screw length increased to 1-1/4 in.

CANADIAN GYPSUM COMPANY—Types AR, IP-AR.  
 UNITED STATES GYPSUM CO—Types AR, IP-AR.  
 USG MEXICO S A DE C V—Types AR, IP-AR.

6. Joint Tape and Compound — Vinyl, dry or premixed joint compound, applied to joints and screw heads; paper tape, 2 in. wide, embedded in first layer of compound over all joints. As an alternate, nominal 3/32 in. thick gypsum veneer plaster may be applied to the entire surface of Classified veneer baseboard. Joints reinforced. Paper tape and joint compound may be omitted when gypsum boards are supplied with square edges.

6A. Steel Framing Members (Not Shown)\* — As an alternate to Item 3, furring channels and resilient sound isolation clip as described below:

Design No. U451  
 May 23, 2007  
 Nonbearing Wall Rating —1 HR.

1. Studs — Channel-shaped, 2-1/2 in. wide by 1-1/4 in. deep with 5/16 in. folded back return flange legs. Fabricated from No. 25 MSG galv steel. Max stud spacing 24 in. OC. Studs to be cut 1 in. less than assembly height.

2. Floor and Ceiling Runners (Not Shown) — Channel-shaped runners, 2-1/2 in. wide by 1-1/4 in. deep, fabricated from No. 20 MSG galv steel. Attached to floor and ceiling with fasteners, 24 in. OC, max.

3. Resilient Channel — 25 MSG galv steel resilient channels spaced vertically max 24 in. OC, flange portion attached to each intersecting stud with 1/2 in. long Type S-12 pan head steel screws.

3A. Steel Framing Members (Not Shown)\* — As an alternate to Item 3, furring channels and Steel Framing Members as described below:  
 a. Furring Channels — Formed of No. 25 MSG galv steel, 2-3/8 in. wide by 7/8 in. deep, spaced 24 in. OC perpendicular to studs. Channels secured to studs as described in Item b. Ends of adjoining channels are overlapped 6 in. and tied together with double strand of No. 18 SWG galv steel wire near each end of overlap. As an alternate, ends of adjoining channels may be overlapped 6 in. and secured together with two self-tapping #6 framing screws, min. 7/16 in. long at the midpoint of the overlap, with one screw on each flange of the channel.

b. Steel Framing Members\* — used to attach furring channels (Item a) to studs (Item 1). Clips spaced 48 in. OC, and secured to studs with 1-5/8 in. wide by 1-1/4 in. deep, fabricated from No. 20 MSG galv steel. Attached to floor and ceiling with fasteners, 24 in. OC, max.

PAC INTERNATIONAL INC—Type RSiC-1.

4. Bolts and Blankets — Placed in stud cavity, 1-1/2 in. min thickness.

THERMAFIBER INC—Type SAFB.

5. Gypsum Board — 1/2 or 5/8 in. thick, 4 ft wide. Screw attached one side to resilient or furring channels with 1 in. long, Type S steel screws spaced 12 in. OC. Wallboard on direct attached side secured to studs with 1 in. long Type S-12 steel screws spaced 12 in. Wallboard joints oriented vertically, located over studs and offset between layers.

AMERICAN GYPSUM CO—Type AG-C.  
 CERTAINTIED GYPSUM INC—1/2 in. or 5/8 in. ProRoc Type C.  
 CERTAINTIED GYPSUM CANADA INC—1/2 in. or 5/8 in. ProRoc Type C.  
 CANADIAN GYPSUM COMPANY—1/2 in. Type C, IP-X2, IP-C-AR or WRC, 5/8 in. Type AR, IP-AR, IP-X1 or SCX.  
 G-P GYPSUM CORP, SUB OF GEORGIA-PACIFIC CORP—Types 5, C, . DAP, DA, LAFARGE NORTH AMERICA INC—Type LGFC-C, LGFC-C/A.  
 NATIONAL GYPSUM CO—Types FSK-C, FSW-C, FSWR-C.  
 PABCO BUILDING PRODUCTS L L C, DBA PABCO GYPSUM—Type C or PG-C.  
 TEMPLE-INLAND FOREST PRODUCTS CORP—Type TG-C.  
 UNITED STATES GYPSUM CO—1/2 in. Type C, IP-X2, IP-C-AR or WRC, 5/8 in. Type AR, IP-AR, IP-X1 or SCX.  
 USG MEXICO S A DE C V—1/2 in. Type C, IP-X2, IP-C-AR or WRC; 5/8 in. Type AR, IP-AR, IP-X1 or SCX.

A

6. Joint Tape and Compound — Vinyl, dry or premixed joint compound, applied to joints and screw heads; paper tape, 2 in. wide, embedded in first layer of compound over all joints. As an alternate, nominal 3/32 in. thick gypsum veneer plaster may be applied to the entire surface of Classified veneer baseboard. Joints reinforced.

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COMMERCIAL + MULTIFAMILY + RESIDENTIAL  
ARCHITECTURAL DESIGN & INTERIOR DESIGN

A MEMBER FIRM OF THE

AMERICAN INSTITUTE OF ARCHITECTS SINCE 1985

**FAIRFIELD INN &****SUITES**

BY

MARRIOTT

290 POWER DRIVE,  
BATESVILLE, MS 38606

SEAL

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CONSULTANTS

NO.	DATE	DESCRIPTION
1	09/22/05	30% REVIEW SET
2	11/22/05	50% REVIEW SET
3	12/22/05	100% REVIEW SET

ISSUES &amp; REVISIONS

100% REVIEW SET  
CONSTRUCTION

PROJECT NAME:

RATED WALL ASSEMBLIES

DRAWN BY/INK: BBC  
CHECKED BY: BBC  
DATE: 12-22-15  
SCALE: AS NOTEDDRAWING NUMBER  
**G101**

D

Design No. U469  
March 25, 2008  
Assembly Rating — 1 HR  
Nonbearing Wall

1. Floor and Ceiling Runners — "J" — shopped, 2-1/2 in. wide with unequal legs of 1 in. and 2 in., fabricated from 24 MSG galv steel (min 20 MSG steel required when Item 4A is used). Runners attached to structural supports with steel fasteners located not greater than 2 in. from ends and not greater than 24 in. OC.

2. Steel Studs — "C-H" shopped studs, 2-1/2 in. wide by 1-1/2 in. deep, fabricated from min 25 MSG galv steel (min 20 MSG steel required when Item 4A is used), spaced 24 in. or 600 mm OC. Vertically restrained walls require studs to be cut 3/8 in. less than floor to ceiling height.

3. Gypsum Board\* — 1 in. thick gypsum wallboard liner panels, supplied in nominal 24 in. or 600 mm widths. Vertical edges inserted in "H" shaped section of "C-H" studs. Free edge of end panels attached to long leg of "J" runners with 1-5/8 in. long Type S head steel screws spaced not greater than 12 in. OC.

CANADIAN GYPSUM COMPANY — Type SLX.  
UNITED STATES GYPSUM CO — Type SLX  
USG MEXICO S A DE C V — Type SLX.

4. Gypsum Board\* — 5/8 in. thick, 4 ft or 1200 mm wide, applied vertically and attached to studs with 1 in. long Type S steel screws spaced 12 in. OC along the edges and in the field of the boards.

AMERICAN GYPSUM CO — Types AGX-1, AG-C.

CERTAINTED GYPSUM CANADA INC — ProRoC Type C.

CANADIAN GYPSUM COMPANY — Types C, IP-X1, IP-X2, IPC-AR, SCX or WRC.

G-P GYPSUM CORP. SUB OF

GEORGIA—PACIFIC CORP — Type 5.

LAFARGE NORTH AMERICA INC — Types LGFC-C, LGFC-C/A, LGFC6A

PARCO BUILDING PRODUCTS L L C, DBA

PARCO GYPSUM — Type C, PG-11 or PG-C.

TEMPLE-INLAND FOREST PRODUCTS CORP — Type X, Veneer Plaster

Base — Type X, Water Rated — Type X, Sheathing — Type X, Softfill — Type X, TG-C.

UNITED STATES GYPSUM CO — Types C, FRX-G, IP-X1, IP-X2.

IPC-AR, SCX or WRC.

USG MEXICO S A DE C V — Types C, IP-X1, IP-X2, IPC-AR, SCX or WRC.

B

4A. Gypsum Board\* — Not Shown — As an Alternate to Item 4, Nom 5/8 in. thick lead backed gypsum panels with beveled, square or tapered edges, applied vertically. Vertical joints centered over studs and staggered min 1 stud cavity on opposite sides of studs. Wallboard secured to studs with 1-1/4 in. long Type S-12 steel screws spaced 8 in. OC at perimeter and 12 in. OC in the field. Lead batten strips (Item 6) required behind vertical joints

RAY-BAR ENGINEERING CORP — Type RB-LBG

5. Batts and Blankets\* — (Optional) — Mineral wool batts partially or completely filling stud cavity.

THERMAFIBER INC — Type SAFB.

5A. Fiber, Sprayed\* — As an alternate to Batts and Blankets (Item 5) — Spray applied cellulose material. The fiber is applied with water to completely fill the enclosed cavity in accordance with the application instructions supplied with the product. Nominal dry density of 3.0 lb/ft<sup>3</sup>. Alternate application method: The fiber is applied with U.S. Greeniber LLC Type AD100 hot melt adhesive at a nominal ratio of one part adhesive to 6.6 parts fiber to completely fill the enclosed cavity in accordance with the application instructions supplied with the product. Nominal dry density of 2.5 lb/ft<sup>3</sup>.

A

U S GREENFIBER L L C — Cocoon2 Stabilized or Cocoon-FRM (Fire Rated Material)

5B. Fiber, Sprayed\* — As an alternate to Batts and Blankets (Item 5) and Item 5A — Spray applied cellulose insulation material. The fiber is applied with water to interior surfaces in accordance with the application instructions supplied with the product. Applied to completely fill the enclosed cavity. Minimum dry density of 4.3 pounds per cubic ft.

NU-WOOL CO INC — Cellulose Insulation

6. Lead Batten Strips — For Use with Item 4A — (Not Shown) — Lead batten strips required behind vertical joints of lead backed gypsum wallboard (Item 4A) and optional at remaining stud locations. Strips, min 1-1/2 in. wide, max 10 ft long with a max thickness of 0.125 in. Strips placed on the interior face of studs and attached from the exterior face of the stud with two 1 in. long Type S-12 pan head steel screws, one at the top of the strip and one at the bottom of the strip. Lead batten strips to have a purity of 99.9% meeting the Federal specification QQ-L-201f, Grade "C".

6A. Lead Discs or Tabs — (Not Shown) — Used in lieu of or in addition to the lead batten strips (Item 6) or optional at other locations — Max 3/4 in. diam by max 0.125 in. thick lead discs compression fitted or adhered over steel screw heads or max 1/2 in. by 1-1/4 in. by max 0.125 in. thick lead tabs placed on gypsum boards (Item 5) underneath screw locations prior to the installation of the screws. Lead discs or tabs to have a purity of 99.9% meeting the Federal specification QQ-L-201f, Grade "C".

\*Bearing the UL Classification Mark

**2B** **UL # U469 1-HR MTL STUD NON-BEARING**  
NLS

Design No. U904

March 17, 2004

Bearing Wall Rating — 3 HR.

Nonbearing Wall Rating — 3 HR.

Load Restricted for Canadian Applications — See Guide

1. Concrete Blocks\* — Various designs. Classification C-3 (3 hr).  
See Concrete Blocks category for list of eligible manufacturers.

2. Mortar — Blocks laid in full bed of mortar, nom. 3/8 in. thick, of not less than 2-1/4 and not more than 3-1/2 parts of clean sharp sand to 1 part Portland cement (proportioned by volume) and not more than 50 percent hydrated lime (by cement volume). Vertical joints staggered.

3. Portland Cement Stucco or Gypsum Plaster — Add 1/2 hr to Classification if used. Attached to concrete blocks (Item 1).

4. Loose Masonry Fill — If all core spaces are filled with loose dry expanded silt, expanded clay or shale (Rotary Klin Process), water repellent vermiculite masonry fill insulation, or silicone treated perlite loose fill insulation add 1 hr to Classification.

5. Foamed Plastic\* — (Optional—Not Shown) — 1-1/2 in. thick max. 4 ft wide sheathing attached to concrete blocks (Item 1).

THE DOW CHEMICAL CO — Type Thermax

\*Bearing the UL Classification Mark

**3D** **UL # U904 3-HR CMU**  
NLS

Design No. U905  
March 17, 2004  
Bearing Wall Rating — 2 HR.  
Nonbearing Wall Rating — 2 HR  
Load Restricted for Canadian Applications — See Guide

1. Concrete Blocks\* — Various designs. Classification D-2 (2 hr).  
See Concrete Blocks category for list of eligible manufacturers.

2. Mortar — Blocks laid in full bed of mortar, nom. 3/8 in. thick, of not less than 2-1/4 and not more than 3-1/2 parts of clean sharp sand to 1 part Portland cement (proportioned by volume) and not more than 50 percent hydrated lime (by cement volume). Vertical joints staggered.

3. Portland Cement Stucco or Gypsum Plaster — Add 1/2 hr to classification if used. Where combustible members are framed in wall, plaster or stucco must be applied on the face opposite framing to achieve a max. Classification of 1-1/2 hr. Attached to concrete blocks (Item 1).

4. Loose Masonry Fill — If all core spaces are filled with loose dry expanded silt, expanded clay or shale (Rotary Klin Process), water repellent vermiculite masonry fill insulation, or silicone treated perlite loose fill insulation add 2 hr to classification.

5. Foamed Plastic\* — (Optional—Not Shown) — 1-1/2 in. thick max. 4 ft wide sheathing attached to concrete blocks (Item 1).

THE DOW CHEMICAL CO — Type Thermax

\*Bearing the UL Classification Mark

**3B** **UL # U905 2-HR CMU**  
NLS

Design No. U906  
March 17, 2004  
Bearing Wall Rating — 2 HR.  
Nonbearing Wall Rating — 2 HR.  
Load Restricted for Canadian Applications — See Guide

1. Concrete Blocks\* — Nominal 6 by 8 by 16 in. hollow or solid. Classification D-2 (2 hr).

ANCHOR CONCRETE PRODUCTS INC  
GAGNE & SON CONCRETE BLOCK INC  
Allowable compressive stress of 57% of max allowable compressive stress in accordance with the empirical design method.  
OLDCASTLE APG NE DBA ARTHUR WHITCOMB  
WESTBROOK CONCRETE BLOCK CO INC  
Allowable compressive stress of 75.6% of max allowable compressive stress in accordance with the empirical design method.

2. Mortar — Blocks laid in full bed of mortar, nom. 3/8 in. thick, of not less than 2-1/4 and not more than 3-1/2 parts of clean sharp sand to 1 part Portland cement (proportioned by volume) and not more than 50 percent hydrated lime (by cement volume). Vertical joints staggered.

3. Portland Cement Stucco or Gypsum Plaster — Add 1/2 hr to Classification if used. Attached to concrete blocks (Item 1).

4. Foamed Plastic\* — (Optional—Not Shown) — 1-1/2 in. thick max. 4 ft wide sheathing attached to concrete blocks (Item 1).

THE DOW CHEMICAL CO — Type Thermax

\*Bearing the UL Classification Mark

**4B** **UL # U906 2-HR CMU**  
NLS

PROJECT NUMBER: 15180

DRAWING NAME:

SHEET NAME

RATED WALL ASSEMBLIES

DRAWN BY/INK: BBC

CHECKED BY: BBC

DATE: 12-22-15

SCALE: AS NOTED

DRAWING NUMBER  
**G101**

2. Normal Weight or Lightweight Concrete — Normal weight concrete, concrete or siliceous aggregate, 3500 psi compressive strength, vibrated. Lightweight concrete, expanded shale or slate aggregate by rotary-klm method or expanded clay aggregate by rotary-klm or sintered-grate method, 3000 psi compressive strength, vibrated, 4 to 7 per cent entrained air.

3A. Negative Reinforcement — (Not Shown) — For floor spans with concrete cast continuous over the supporting beams. Deformed bars designed to resist the support moments of the concrete slab in accordance with the latest ACI Building Code Specifications.

4. Steel Floor and Form Units\* — Composite 1-1/2, 1-5/8, 2 or 3 in. deep golv units or 4-1/2 in. deep non-composite golv units. Fluted units may be phos/pitd. Min gougues are 22 MSG for fluted and 20/20 for cellular and partial cellular units. The following combinations of units may be used:

- (1) All 24, 26, 28 or 36 in. wide cellular or partial cellular.
- (2) All fluted.
- (3) One or two 3 in. deep, 12 in. wide, 18/18 MSG min cellular alternating with 3 in. deep fluted or other cellular.
- (4) Any blend of fluted and 24, 26, 28 or 36 in. wide cellular or partial cellular.
- (5) Corrugated, nom 1-5/16 or 2 in. deep, 30 in. wide, 24 MSG min golv units with shear wires factory welded to deck corrugations. Welded to supports 12 in. OC through welding washers. For shear wire spacing of 8 in. or less the steel deck stress shall not exceed 20 KSI. For shear wire spacing greater than 8 in. OC but less than or equal to 12 in. OC steel deck stress shall not exceed 12 KSI.

#### ASC STEEL DECK, DIV OF ASC PROFILES

ASC STEEL DECK, DIV OF ASC PROFILES  
INC—24 in. wide Types 2W24, 2WF24, 3W24, 3WF24, B, BF—24, BR, BMD, BRMD, N, NF: 30 in. wide Type B—30, BF—30, BR: 36 in. wide Types 2W36, 2WF36, 3W36, 3WF36, B—36, BF—36, BR: 30 in. wide Types ASC2, ASC3.  
CANAM STEEL CORP — 24 in. wide Type P—2432 composite or 36 in. wide Type P—3623, P—3606, P—3615 and 24 in. wide Type P—2432 composite. Type P—3606, P—3615 non-composite  
CHIA TEH CONSTRUCTION MATERIAL CO LTD—24 or 36 in. wide Mac-Lok 3, 24 in. wide CFD-3.

CMC JOIST & DECK — MANUFACTURERS OF UNITED STEEL DECK PRODUCTS—12 or 24 in. wide, Types 1-1/2, 2, or 3 in. LOK—Floor and LOK—Floor Cell; 24, 30 or 36 in. wide, Type 1-1/2 in. B—LOK and B—LOK Cell; 24 in. wide, Types N—LOK and N—LOK Cell

CONSOLIDATED SYSTEMS INC — 24 in. wide Types CFD—2, CFD—3, 24, 30 or 36 in. wide Type CFD—1S; 24 or 36 in. wide Types Mac—Lok 2, Mac—Lok 3; 24 in. wide Types B2C, B2FC, NC, NFC; 30 in. wide, Type B3C; 12 in. wide Mac—Way Cellular, 45 MDW, 2—633 MTWA, 3—633 MTWA+; 30 in. wide, Mac—Cor Types 1 and 2  
DECK WEST INC — 36 in. wide Type B—DW, Inverted B—DW, BA—DW, Inverted BA—DW, 2—DW or 3—DW, Side joints of Type 2—DW and 3—DW may be fastened together with min 1 in. long No. 12 x 14 self-drilling, self-tapping steel screws 36 in. OC.  
ERIC METALS CORP — 24 in. wide Types EC150, EC150 inverted, EC300, EC366, ECP150, ECP300, ECP366, Epicore A, 2.0 ECA, 30 in. wide Types ECB150, ECBR150; 36 in. wide Types EC156, EC266, ECP266.

FLYNN CANADA LTD — 24 in. wide, Types T—150, —150F.  
GENS METALS INC — 12 or 24 in. wide Types LF2, LF3.  
H H ROBERTSON — OL Types, 24 in. wide, 3 or 3 inverted, UKX, 21 or 21 inverted, 2 in. 99, 121, AKX, NKX, TKX; 24 or 30 in. wide GXX, GKXH, GKX-A, 36 in. wide 2 in. 99, AKX, WKX; 12 in. wide NK, TK, TKX; 12 in. wide non-composite Sec 12. Side joints of 99, 121, TK, TKX, WKX may be welded together 60 in. OC. Side joints of 99, AKX, WKX, GKX, GKX-A, TKX may be fastened together with min 1 in. long No. 12x14 self-drilling, self-tapping steel screws 36 in. OC.

1D. Steel Joists — (Not shown) — As an alternate to Item 1 — May be either uncoated or provided with a shop coat of paint. Composite or noncomposite. Welded or bolted to end supports. Designed per S.U.I. specifications for a max design stress of 30 ksi. The top chords shall consist of two angles measuring 1-1/4 by 1-1/4 by 0.127 in. thick. Bottom chords shall consist of two round bars measuring 0.566 in. in diam. or two angles measuring 1 by 1 by 0.125 in. thick. Bearing plates shall conform to S.U.I. specifications. Web members shall consist of 0.565 in. diam bars. The min depth and weight shall be 8 in. and 4.9 lb/ft respectively.

MARLYN STEEL DECKS INC — Type 1.5 CF, 2.0 CF or 3.0 CF.  
MORIN CORP — 24, 30 or 36 in. wide Types LXR-B, LXR—B inverted; 24 or 36 in. wide Type LXR—3W; 36 in. wide Type LXR—2W.  
NEW MILLENNIUM BUILDING SYSTEMS L L C — Type 1.5CD, 2.0CD, or 3.0CD  
ROOF DECK INC — 36 in. wide Types LOK—1-1/2, LOK—1-1/2R; 24 in. wide Types LOK—2, LOK—3.

VERCO DECKING INC — A NUCCOR CO — 24, 30 or 36 in. wide Types PLB, PLBCD, B, BCD, BR; 24 or 36 in. wide Types PLW2, PLW2CD, W2, W2CD, PLW3, PLW3CD, W3, W3CD; 24 in. wide Types PLN, PLNCD, N, NCD; 12 in. wide PLW2, W2, PLW3 or W3 units may be blended with 24 or 36 in. wide PLW2, W2, PLW3 or W3 units, respectively. Fluted units may be phos/pitd.

VALLEY JOIST — 24 or 36 in. wide Types WVC 1-1/2 or WVC 2, VULCRAFT, DIV OF NUCCOR CORP — 24, 30 or 36 in. wide, Type 1.5 VL, 1.5VL, 1.5WLP; 24 or 36 in. wide, Types 2VL, 3VL, 2VLP, 3VLP.  
THE WIREMOLD COMPANY — 24 in. wide, Types 2 or 3 in. WDR.  
WHEELING-PITTSBURGH STEEL CORP, DIV OF WHEELING CORRUGATING CO — 30 in. wide Types SB—B16LF, —150, —150N, —150NR; 24 in. wide Type SB—200, —300, SB—B16LF, —N35LF, —P21LF, —P31LF or —P35LF; 12 in. wide Type SB—P21LF or SB—P31LF; 36 in. wide Types SB—B16LF, —P21LF, —P31LF; Lock Form Type, 24, 30 or 36 in. wide Types B16LF, B16LFNV; 24 in. wide Types P34LF, P34LFNV; 12, 24 or 36 in. wide Types C20LF, C30LF, C31LF, P20LF, P30LF, P31LF; 36 in. wide Types 1.5 SB, 1.5 SBR; 24 or 36 in. wide Types 2.0 SB, 3.0 SB, 36 in. wide Type High Strength 1.5 SBI, 36 in. wide Type High Strength 1.5 SBN; Units may be phos/pitd. 30 in. wide Types 1-1/2 in. V-Grip, 1-1/2 in. RY-Grip; 24 or 36 in. wide Types 212Y-Grip, 312Y-Grip; 36 in. wide Types 212W3-Wireway, 312W3-Wireway.

Components for field-assembled cellular metal raceway units: Raceway bottom — 24 or 36 in. wide Types 212YS, 312YS. Raceway cover plate — Types CP—12, CP—16. Raceway divider — Types DC—20, DC—25. Raceway isolation trough — Types T—20, T—25, T—30. Spacing of welds attaching units to supports shall be 12 in. OC for 12, 24, 36 in. wide units, four welds per sheet for 30 in. wide units, 6 in. OC for 18 in. wide and Sec. 12 units. Unless specified otherwise for specific units types, adjacent units butt-jointed or welded together 36 in. OC along side joints. For 3 Hr Rating, units with overlapping type side joints welded together 24 in. OC max. When a superimposed load of 250 PSF is desired the spacing of welds or butt-joints shall not exceed 24 in. OC along side joints.

+12 in. wide, 1-1/2 in. deep Mac—Way units may be blended with 24 in. wide B2C or 30 in. wide B3C units in a blend of one cell to one or more fluted units. 12 in. wide, 2 in. deep Mac—Way units may be blended with 24 or 36 in. wide Mac—Lok units in a blend of one cell to one or more fluted units. 12 in. wide, 3 in. deep Mac—Way units may be blended with 24 or 36 in. wide Mac—Lok 3 units in a blend of one cell to one or more fluted units. The side edge of the fluted units is placed on the top of the side edge of the Mac—Way unit and the two are welded together with welding washers spaced a max. of 32 in. OC for Mac—Lok 2 or 3 units and a max. of 24 in. OC for the B2C or B3C units.

Alternate Construction — Noncomposite units of the same type listed above may be used provided allowable loading is calculated on the basis of noncomposite design.  
The Unrestricted Assembly Rating is equal to the Unrestricted Beam Rating. (See Item 6) for a max 3 Hr and is limited to the following units and limitations:  
(a) 1-1/2, 2 and 3 in. deep, 24 in. wide, 22 MSG or thicker fluted with clear spans not more than 7 ft, 8 in.  
(b) 1-1/2, 2 and 3 in. deep, 24 in. wide, 20 MSG or thicker fluted with clear spans not more than 8 ft, 8 in.  
(c) 1-1/2 and 2 in. deep, 24 in. wide, 16 MSG or thicker fluted and 18/18 MSG or thicker cellular with clear spans not more than 9 ft, 11 in.  
(d) 3 in. deep, 36 in. wide, 18 MSG or thicker fluted and 24 in. wide, 20/18 MSG or thicker cellular with clear spans not more than 13 ft, 2 in.

For assemblies utilizing 3-1/4 in. lightweight concrete topping with a max Restrained Assembly Rating of 2 Hr, the Unrestricted Assembly Rating is equal to the Unrestricted Beam Rating. (See Item 6) and is limited to the following floor units and spans:  
(a) 1-1/2, 2 and 3 in. deep, 24 or 36 in. wide, 22 MSG fluted and 20/20 MSG cellular with clear spans not more than 9 ft, 6 in.  
(b) 2 and 3 in. deep, 24 or 36 in. wide, 20 MSG fluted and 20/20 MSG cellular with clear spans not more than 10 ft, 0 in.  
(c) 3 in. deep, 24 in. wide, 20 MSG fluted and 20/20 MSG cellular with clear spans not more than 13 ft, 2 in.

5. Joint Cover — (Use with fluted units optional — Not Shown) — 2 in. wide cloth adhesive tape applied following the contour of the units.  
6. Spray—Applied Fire Resistive Materials\* — Applied by spraying with water, in one coat, to a final thickness as shown above and in table below to steel beam surface which is free of dirt, oil or scale. When

fluted steel deck is used and the fire protection thickness selected is based on all fluted deck, the area between the steel deck and the top flange of the steel beam shall be filled. When fluted steel deck is used and the steel beam is sprayed with the thicknesses applicable to cellular or blended units, the area between the steel deck and the top flange of the steel beam shall be plugged. Use of adhesive is optional. Min avg untamped density is 13 pcf with min ind untamped density of 11 pcf for Types II or DC/F. Min avg and min ind untamped densities of 22 and 19 pcf, respectively, for Type HP. Tamping is optional. For method of density determination, refer to Design Information Section. The thickness of the Spray—Applied Fire Resistive Materials on the Structural Members (Item 1, 1A, or 1B) shall be as follows:

\*May be reduced to 3/4 in. for the 1-1/2 hr Unrestricted Beam Rating when the material is sprayed 2 in. beyond the beam's top flange and no reduction in thickness is made of the tips of the bottom flange.  
\*\*This thickness applies when optional Item 12 or 13 are used over 3-1/4 in. lightweight concrete topping.  
+Thickness of Spray—Applied Fire Resistive Materials may be reduced to one half of this thickness on the lower flange tips of the steel beam.  
++ — When bottom chords consist of 1 by 1 by 0.125 in. thick steel angles, the thickness of spray-applied fire resistive material shall be increased by 1/4 in. on the bottom chord only.  
CIL GROUP LTD ? Type D-C/F or Type II, Type EBS or Type X  
ISOLATEK INTERNATIONAL ? Type D-C/F, HP, Type II, Type EBS or Type X adhesive which may also be used as a surface sealer.  
6A. Spray—Applied Fire Resistive Materials\* ? Alternate to Item 6. See table below for appropriate thicknesses. When fluted steel deck is used and the fire protection thickness selected is based on all fluted deck, the area between the steel deck and the top flange of the steel beam shall be filled. When fluted steel deck is used and the steel beam is sprayed with the thicknesses applicable to cellular or blended units, the area between the steel deck and the top flange of the steel beam shall be plugged. Prepared by mixing with water and spray—applied in one or more coats to beam surfaces which must be clean and free of dirt, loose scale and oil. Min average density of 17.5 pcf with min individual value of 17.0 pcf. For method of density determination, see Design Information Section. Sprayed Material.

4A. UL # D902 1-3 HR. FLOOR ASSEMBLY  
NITS

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COMMERCIAL + MULTIFAMILY + RESIDENTIAL  
ARCHITECTURAL DESIGN & INTERIOR DESIGN  
A MEMBER FIRM OF THE  
AMERICAN INSTITUTE OF ARCHITECTS SINCE 1985

**FAIRFIELD INN & SUITES**  
BY  
MARRIOTT  
290 POWER DRIVE,  
BATESVILLE, MS 38606

SEAL

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BYRON B. CARSON, JR., ARCHITECT - 2014  
DRAWING SPECIFICATIONS, AND DESIGN BE  
BASED ON REPRODUCED IN WHOLE OR IN PART  
FORM WITHOUT THE WRITTEN CONSENT OF  
BYRON B. CARSON, JR., ARCHITECT. ALL DIMENSIONS  
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DIMENSIONS ONLY. IF NOT SHOWN, VERIFY  
CONTRACTOR SHALL VERIFY ALL DIMENSIONS  
PRIOR TO INSTALLATION OF THE WORK  
RESUBMIT THESE

CONSULTANTS

100% REVIEW SET  
CONSTRUCTION

NO.	DATE	DESCRIPTION
1	08/20/15	30% REVIEW SET
2	11/22/2015	50% REVIEW SET
3	1/22/2016	100% REVIEW SET

ISSUES & REVISIONS

NO.	DATE	DESCRIPTION
1	08/20/15	30% REVIEW SET
2	11/22/2015	50% REVIEW SET
3	1/22/2016	100% REVIEW SET

PROJECT NUMBER: 15180

DRAWING NAME:  
**FLOOR & CEILING ASSEMBLIES**

SHEET NAME

DRAWN BY: **BBC**  
CHECKED BY: **BBC**  
DATE: **12-22-15**  
SCALE: **AS NOTED**

DRAWING NUMBER  
**G102**

Design No. D902  
March 03, 2008  
Restrained Assembly Ratings — 1, 1-1/2, 2 and 3 Hr.  
Unrestricted Assembly Ratings — 0, 1, 1-1/2, 2 or 3 Hr. (See Items 4 & 6)  
Unrestricted Beam Ratings — 1, 1-1/2, 2 and 3 Hr.  
Load Restricted for Canadian Applications — See Guide

1. Beam — W12X14, W8X28, W8X24 or W6X12, min size, see Items 6A through 6E.  
1A. Steel joists — (Not shown) — As an alternate to Item 1 — May be either uncoated or provided with a shop coat of paint. Composite or noncomposite. Welded or bolted to end supports. Designed per S.U.I. specifications for a max design stress of 30 ksi. The top chords shall consist of two angles measuring 1-1/4 by 1-1/4 by 0.127 in. thick. Bottom chords shall consist of two round bars measuring 0.566 in. in diam. or two angles measuring 1 by 1 by 0.125 in. thick. Bearing plates shall consist of two angles measuring 1-1/2 by 2 by 0.188 in. thick and 5-1/16 in. long. Web members shall consist of 0.565 in. diam bars. The min depth and weight shall be 8 in. and 4.9 lb/ft, respectively.

1B. Steel joists — (Not shown) — As an alternate to Item 1 — Composite or noncomposite and welded or bolted to end supports. May be uncoated or provided with a shop coat of paint. Designed per S.U.I. specifications for a max design stress of 30,000 psi. Top chords shall consist of two angles measuring 1-1/2 by 1-1/2 by 0.156 in. thick. Bottom chords shall consist of two round bars measuring 0.675 in. in diam. or two angles measuring 1 by 1 by 0.125 in. thick. Bearing plates shall consist of two angles measuring 2 by 2 by 0.192 in. thick and shall be min 4-15/16 in. long. The second web member at each end shall consist of 0.654 in. diam round bar. All remaining web members, including the end web members, shall consist of 0.774 in. diam round bars. Bridging per S.U.I. specifications is required when noncomposite joists are used.

1C. Steel joists — (Not shown) — As an alternate to Item 1 — Composite or noncomposite, welded or bolted to end supports. May be uncoated or provided with a shop coat of paint. Designed per S.U.I. specifications for a max design stress of 30,000 psi. Top chords shall consist of two angles measuring 1-1/2 by 1-1/2 by 0.156 in. thick. Bottom chord shall consist of two round bars measuring 0.675 in. in diam. or two angles measuring 1 by 1 by 0.125 in. thick. The second web member at each end shall consist of 0.654 in. diam round bar. All remaining web members, including the end web members, shall consist of 0.774 in. diam round bars. Bridging per S.U.I. specifications is required when noncomposite joists are used.

1D. Steel Joists — (Not shown) — As an alternate to Item 1 — May be either uncoated or provided with a shop coat of paint. Composite or noncomposite. Welded or bolted to end supports. Designed per S.U.I. specifications for a max design stress of 30 ksi. The top chords shall consist of two angles measuring 1-1/4 by 1-1/4 by 0.127 in. thick. Bottom chords shall consist of two round bars measuring 0.566 in. in diam. or two angles measuring 1 by 1 by 0.125 in. thick. Bearing plates shall conform to S.U.I. specifications. Web members shall consist of 0.565 in. diam bars. The min depth and weight shall be 8 in. and 4.9 lb/ft respectively.

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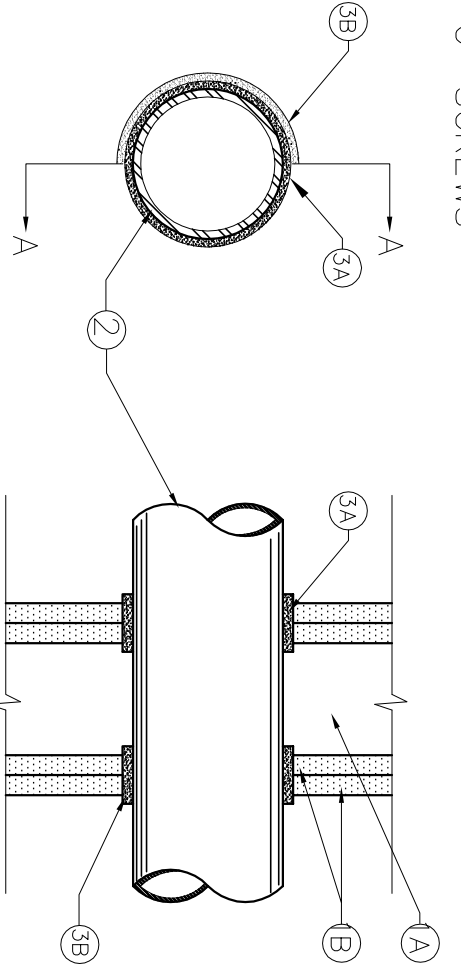
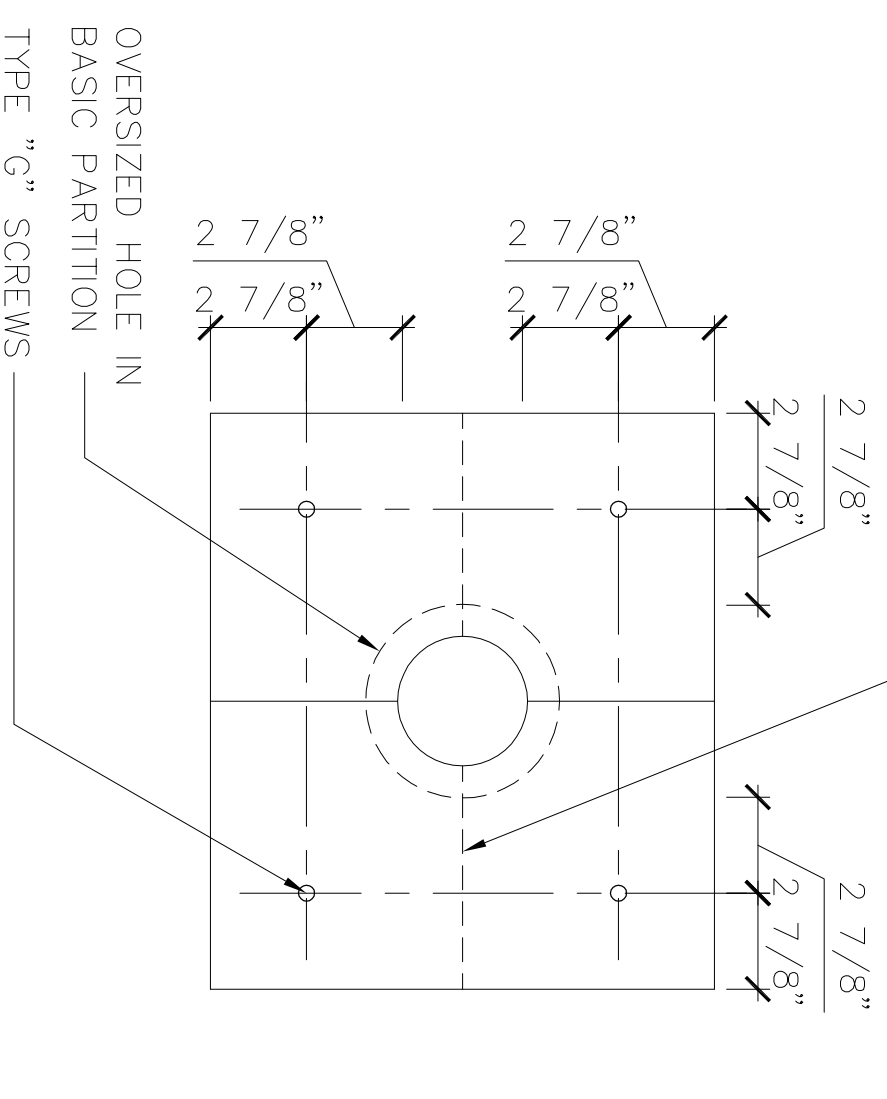
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JOINT AT SECOND LAYER WHERE TWO LAYER PATCH IS REQUIRED



System No. WL2003

- F Ratings — 1 and 2 Hr. (see items 3)
- T Ratings — 1 and 2 Hr. (see items 3)
- L Ratings at Ambient — 7 CFM/sq. ft. (see item 3)
- L Rating at 400 F — less than 1 CFM/sq. ft. (see item 3)



1. WALL ASSEMBLY — The 1 or 2 hr fire-rated gypsum wallboard/stud wall assembly shall be constructed of the materials and in the manner 1. described in the individual U300 or U400 series wall or partition designs in the UL Fire Resistance Directory and shall include the following construction features:

- A. STUDS — Wall framing may consist of either wood studs or steel channel studs. Wood studs to consist of nom 2x4 in. lumber spaced 16 in. OC with nom 2x4 in. lumber end plates and cross braces. Steel studs to be min. 3-5/8 in. wide by 1-3/8 in. deep channels spaced max. 24 in. OC.
- B. WALLBOARD, GYPSUM\* — Nom 1/2 or 5/8 in. thick, 4 ft wide with square or tapered edges. The gypsum wallboard type, thickness, number of layers or fastener type and sheet orientation shall be as specified in the individual U300 or U400 Series Design in the UL Fire Resistance Directory. Max dia. of opening is 3-1/8 in.
- 2. NONMETALLIC PIPE — Nom. 2 in. diam (or smaller) Schedule 40 solid core polyvinyl chloride (PVC) pipe, for use in closed (process or supply) or vented (drain, waste or vent) piping systems. One pipe to be centered in freestop system. The annular space between the pipe and the circular cutout in the gypsum wallboard layers on each side of the wall shall be min. 1/4 in. to max. 3/8 in. pipe to be rigidly supported on both sides of the wall assembly.

- 3. FIRESTOP SYSTEM — Installed symmetrically on both sides of wall assembly. The hourly F and T ratings for the firestop system are equal to the hourly fire rating of the wall assembly in which it is installed. The details of the firestop system are as follows:
- A. FILL, VOID OR CAVITY MATERIALS — WRAP STRIP — Nom 1/4 in. thick intumescent elastomeric material faced on one side with aluminum foil supplied in 2 in. wide strips. Nom 2 in. wide strip tightly wrapped around nonmetallic pipe (foil side out) with seamed butted. Wrap strip layer securely bound with steel wire or aluminum foil tape and slid into annular space approx. 1-1/4 in. such that approx. 3/4 in. of the wrap strip protrudes from the wall surface.
- B. FILL, VOID OR CAVITY MATERIALS — CAULK OR PUTTY — FS-195+\*, Minnesota Mining & Mfg. Co. — continuous bead applied to leading edge of wrap strip layer (item A) prior to insertion of wrap strip layer into annular space. After insertion of wrap strip layer in annular space, a nom 1/4 in. diam. continuous bead is to be applied to the wrap strip/wall interface and to the exposed edge of the wrap strip layers approx. 3/4 in. from the wall surface. — CP 25WB+ CAULK or MPS-2+ Putty.

Minnesota Mining & Mfg. Co. (note: L Ratings apply only when type CP 25WB+ CAULK or MPS-2+ Putty is used) is used in the UL Classification Marking

**1A BLOWOUT PATCH NON METALLIC PIPE**

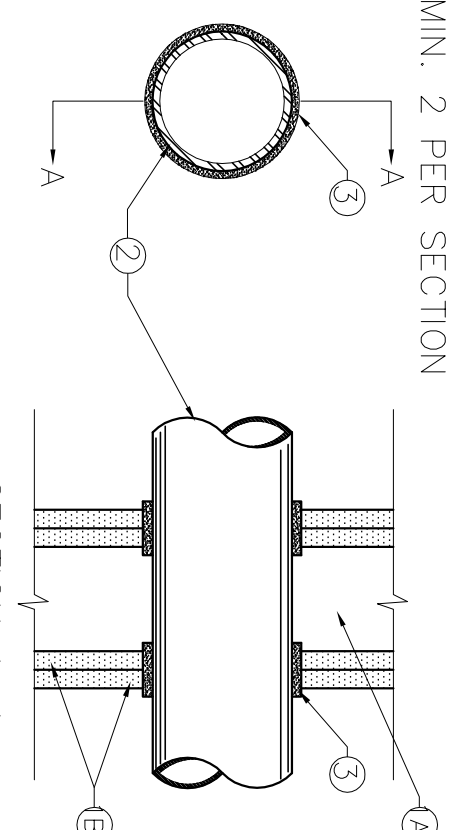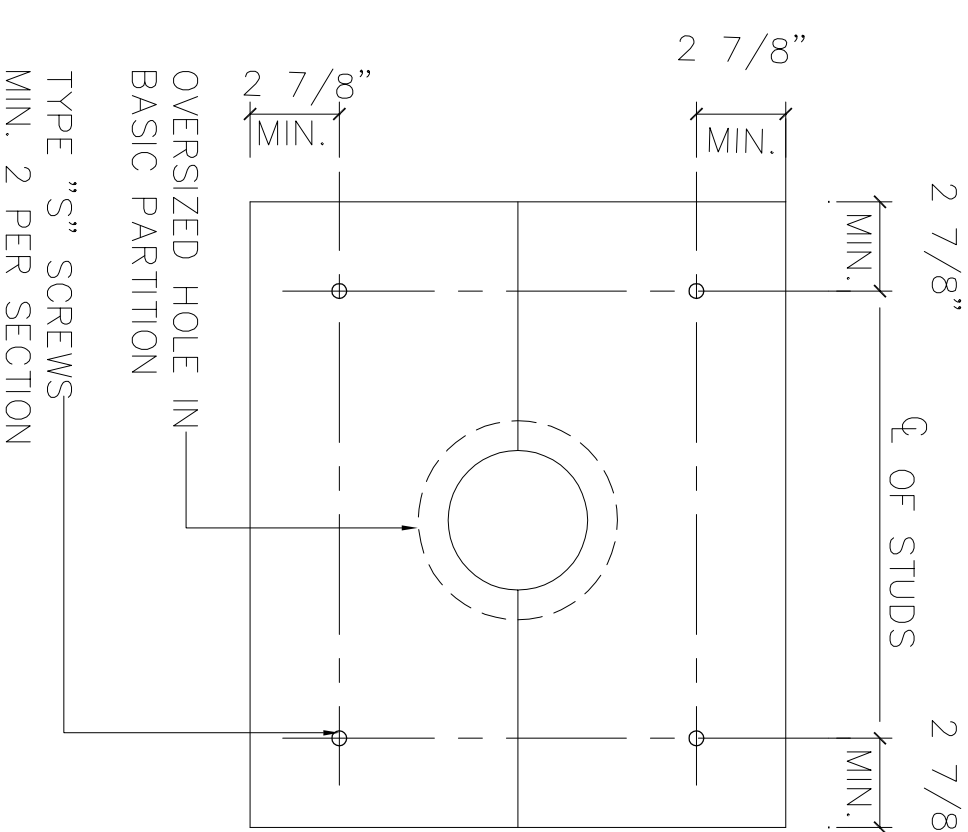

System No. WL1001

- F Ratings — 0, 1, 2, 3 and 4 Hr. (see items 2 & 3)
- T Ratings at Ambient — 1 or 2 Hr. (see items 2 & 3)
- L Rating at 400 F — less than 1 CFM/sq. ft.

1. WALL ASSEMBLY — The 1, 2, 3 or 4 hr fire-rated gypsum wallboard/stud wall assembly shall be constructed of the materials and in the manner described in the individual U300 or U400 series wall or partition designs in the UL Fire Resistance Directory and shall include the following construction features:


- A. STUDS — Wall framing may consist of either wood studs (max. 2 hr fire rated assembly) or steel channel studs. Wood studs to consist of nom 2x4 in. lumber spaced 16 in. OC with nom 2x4 in. lumber end plates and cross braces. Steel studs to be min. 3-5/8 in. wide by 1-3/8 in. deep channels spaced max. 24 in. OC.
- B. WALLBOARD, GYPSUM\* — Nom 1/2 or 5/8 in. thick, 4 ft wide with square or tapered edges. The gypsum wallboard type, thickness, number of layers or fastener type and sheet orientation shall be as specified in the individual U300 or U400 Series Design in the UL Fire Resistance Directory. Max. diam of opening is 13-1/2 in.
- 2. PIPE OR CONDUIT — Nom. 12 in. diam (or smaller) Schedule 10 (or heavier) steel pipe, nom 12 in. diam (or smaller) service weight (or heavier) cast iron soil pipe, nom 12 in. diam (or smaller) Class 50 (or heavier) ductile iron pressure pipe, nom 6 in. diam (or smaller) steel conduit, nom 4 in. diam (or smaller) steel electrical metallic tubing, nom 6 in. diam (or smaller) type L or (or) heavier copper tubing or nom 1 in. diam or smaller flexible steel conduit, WHEN COPPER PIPE IS USED, MAX. RATING OF PIPE SYSTEM (ITEM 3) IS 2 Hr. Steel pipes or conduits larger than 12 in. diam shall be supported by one pipe or conduit in the freestop system. Pipe or conduit to be installed near center of stud cavity width and to be rigidly supported on both sides of wall assembly.

3. FILL, VOID OR CAVITY MATERIAL\* — CAULK — Caulk fill material installed to completely fill annular space between pipe or conduit, and gypsum wallboard and with a min. 1/4 in. diam bead of caulk applied to perimeter of pipe or conduit at its egress from the wall. Caulk installed symmetrically on both sides of wall assembly, the hourly F Rating of the firestop system is dependent upon the hourly fire rating of the wall assembly in which it is installed, as shown in the following table, the hourly T rating of the firestop system is dependent upon the type or size of the pipe or conduit, and the hourly fire rating of the wall assembly in which it is installed, as tabulated below.


Max. Pipe or conduit diam, in	Annular Space in	F Rating hr	T Rating hr
1	0 to 3/16	1 or 2	0+, 1 or 2
1	1/4 to 1/2	1 or 2	3 or 4
4	0 to 1/4	1 or 2	0
4	0 to 1-1/2#	1 or 2	0
6	1/4 to 1/2	3 or 4	0
12	3/16 to 3/8	1 or 2	0

+ When copper pipe is used, T Rating is 0 hr.  
# 0 to 1-1/2 in. annular space applies only when type CP-25 WB+ caulk is used and only when the min. thickness of the gypsum wallboard is 5/8 in. for 1 hr. rated walls and 1-1/4 in. for 2 hr. rated walls.  
Minnesota Mining & Mfg. Co CP 25WB+\*  
\*Bearing the UL Classification Marking

**2A BLOWOUT PATCH METALLIC PIPE**

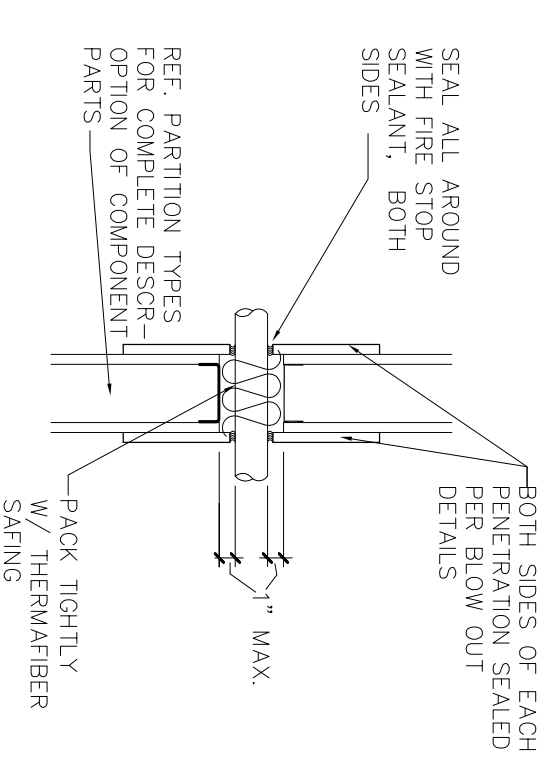


SECTION — MULT. PENETRATIONS  
1/2" = 1'-0"

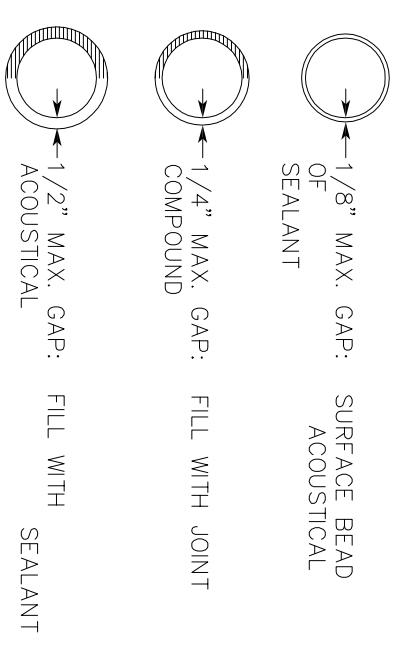

NOTE: GAPS IN EXCESS OF 1/2" MUST BE REPAIRED WITH A BLOWOUT PATCH  
REF: CEG 1-25-85

4C PENETRATIONS IN RATED PARTITIONS  
1/2" = 1'-0"

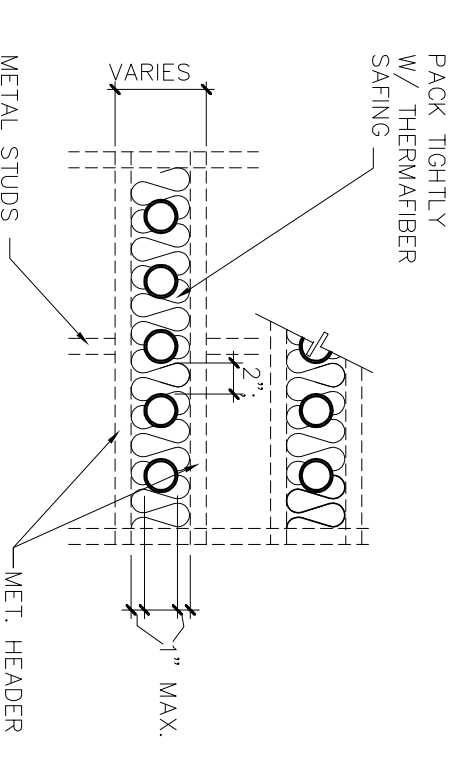

ELEV. — MULT. PENETRATIONS  
1/2" = 1'-0"

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**FAIRFIELD INN & SUITES**  
BY MARRIOTT  
290 POWER DRIVE,  
BATESVILLE, MS 38606

100% REVIEW SET  
CONSTRUCTION

ISSUES & REVISIONS

NO.	DATE	DESCRIPTION
1	09/22/05	30% REVIEW SET
2	11/22/05	50% REVIEW SET
3	12/22/05	100% REVIEW SET

PROJECT NAME: \_\_\_\_\_  
SHEET NAME: \_\_\_\_\_  
PENETRATION DETAILS

DRAWN BY: BKC  
CHECKED BY: BKC  
DATE: 12-22-15  
SCALE: AS NOTED

DRAWING NUMBER: **G104**

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**FAIRFIELD INN & SUITES**  
BY MARRIOTT  
290 POWER DRIVE,  
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100% REVIEW SET  
CONSTRUCTION


ISSUES & REVISIONS

NO.	DATE	DESCRIPTION
1	09/22/05	30% REVIEW SET
2	11/22/05	50% REVIEW SET
3	12/22/05	100% REVIEW SET


PROJECT NAME: \_\_\_\_\_  
SHEET NAME: \_\_\_\_\_  
PENETRATION DETAILS

DRAWN BY: BKC  
CHECKED BY: BKC  
DATE: 12-22-15  
SCALE: AS NOTED


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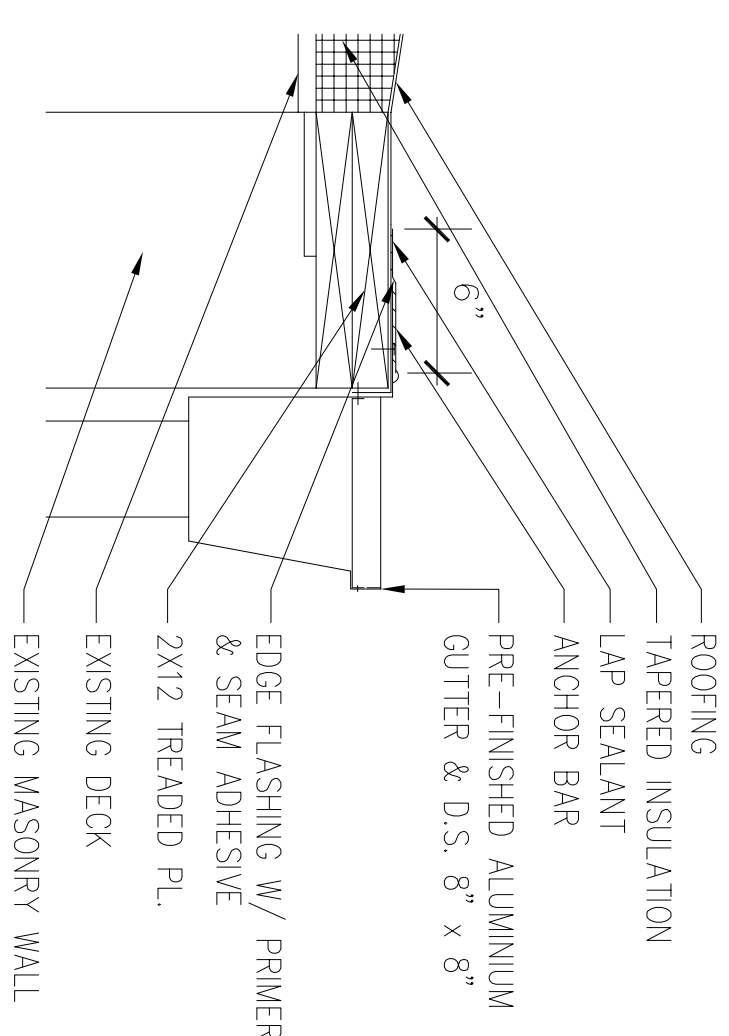
1D TYP. NEW ROOF SECTION  
1/2"=1'-0"

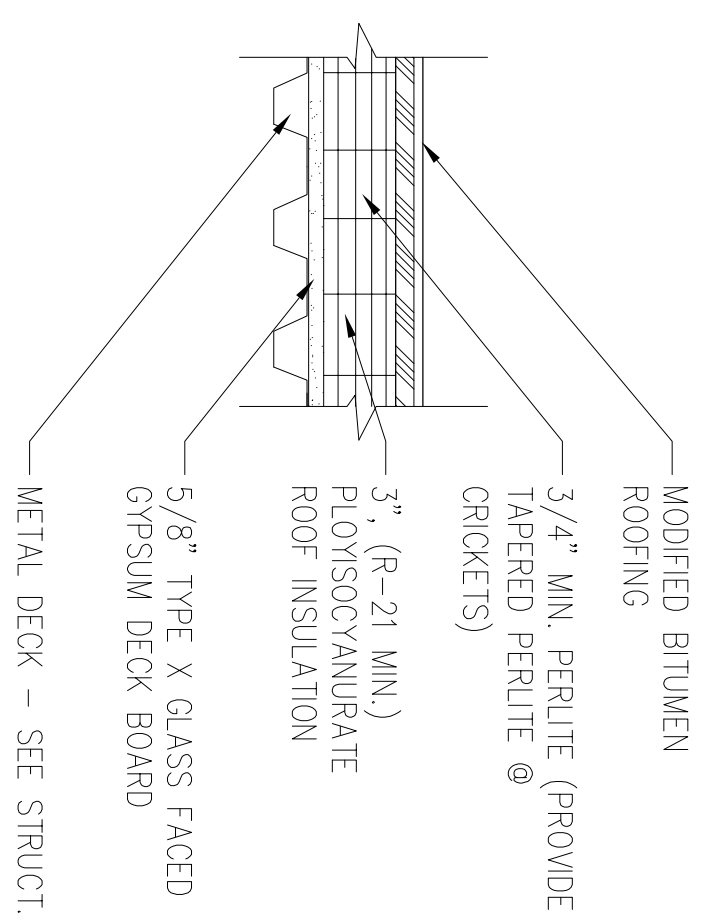


2D TYP. NEW ROOF SECTION  
1/2"=1'-0"

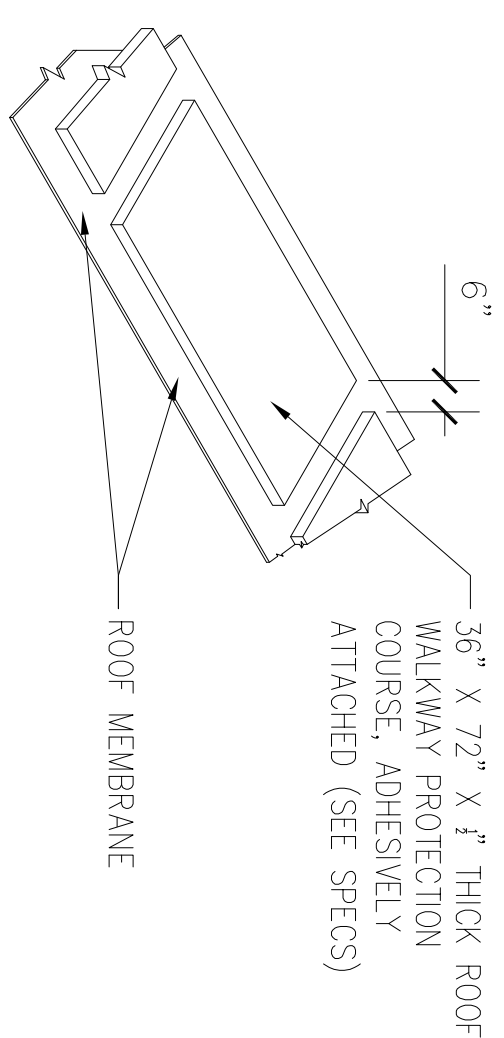


3D PIPE SUPPORT TYPE 2  
1/2"=1'-0"

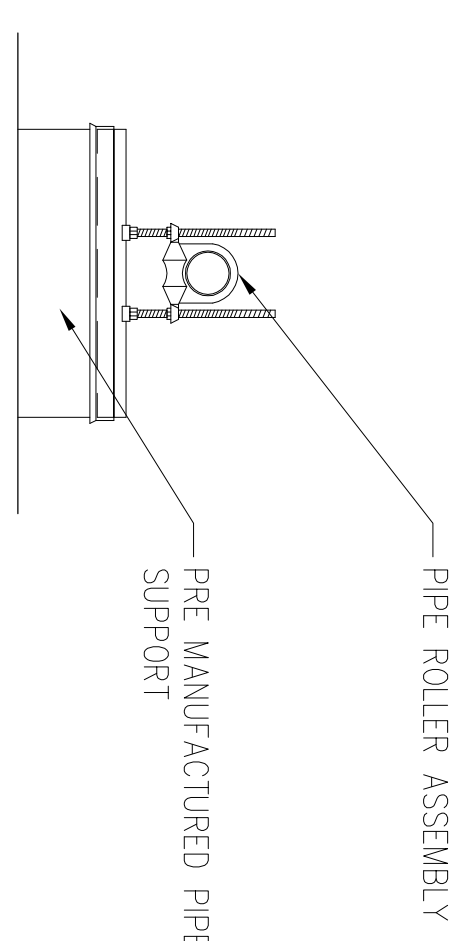


4D ROOF DETAIL @ GUTTER  
1"=1'-0"

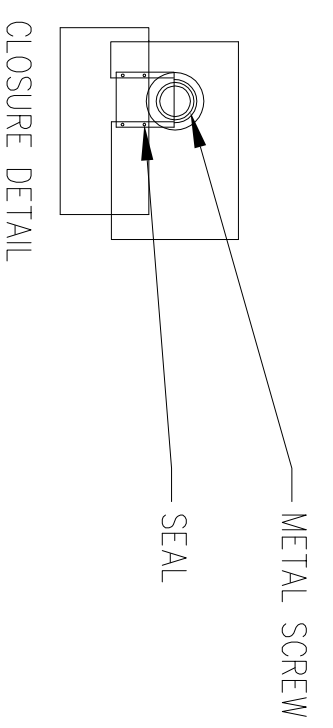


1B MODIFIED BITUMINOUS ROOF PIPING THRU ROOF  
1/2"=1'-0"

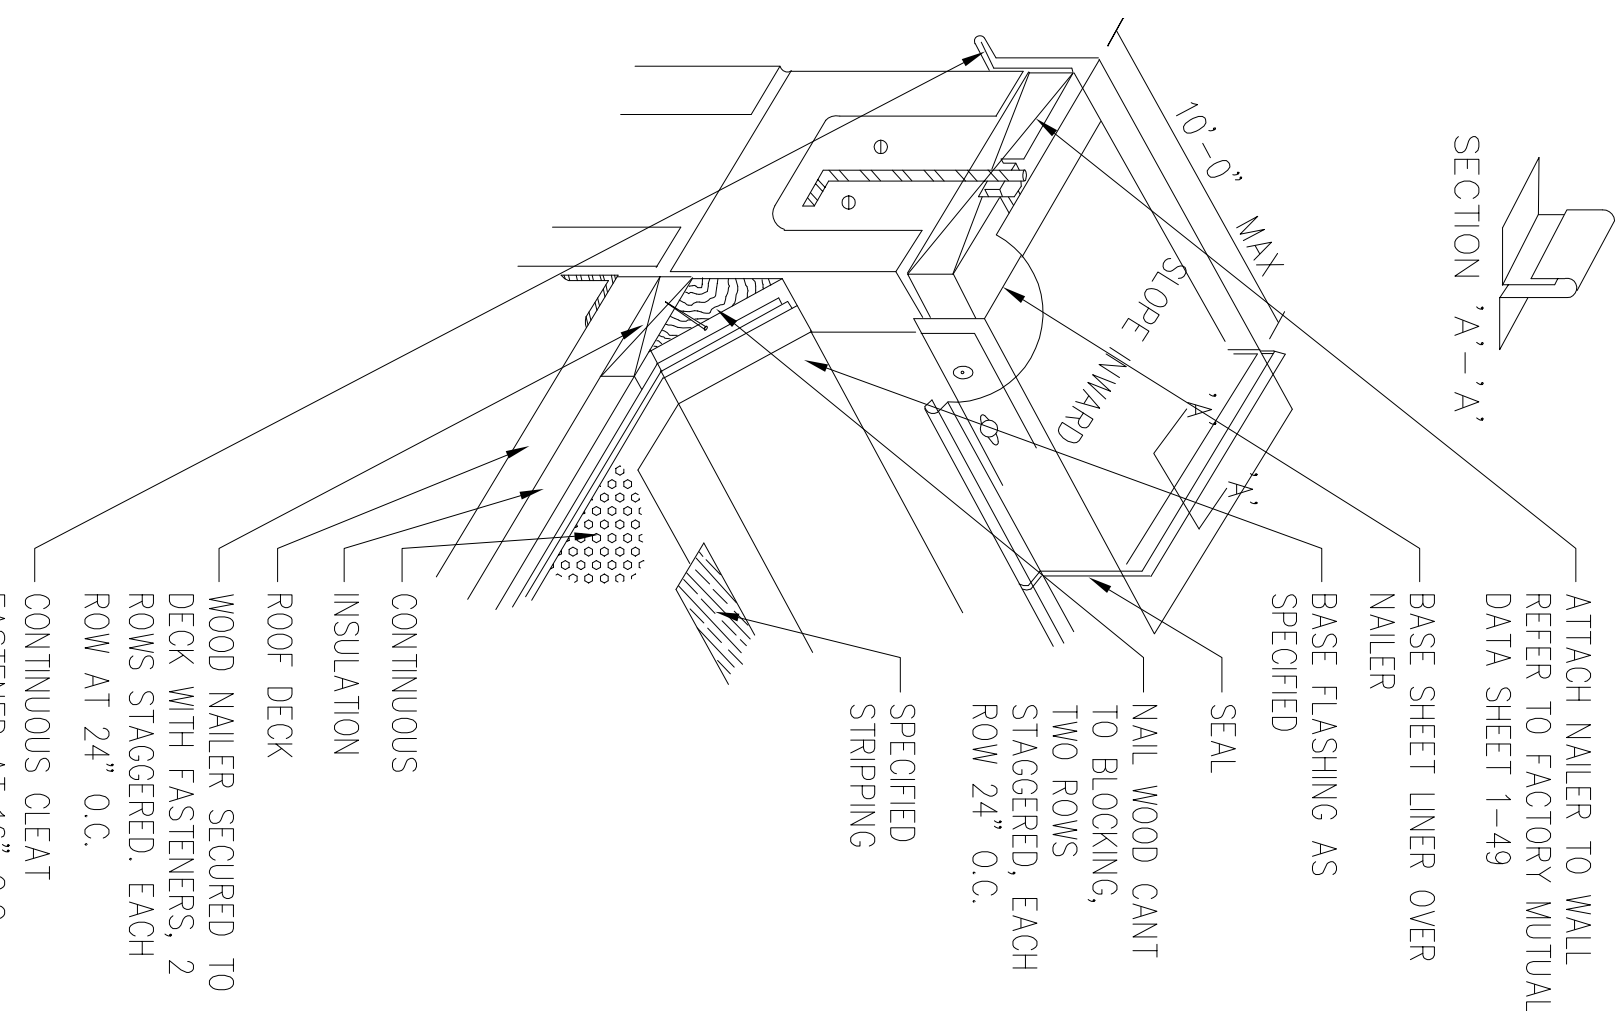


2B MODIFIED BITUMINOUS PARAPET @ CMU WALL  
1/2"=1'-0"

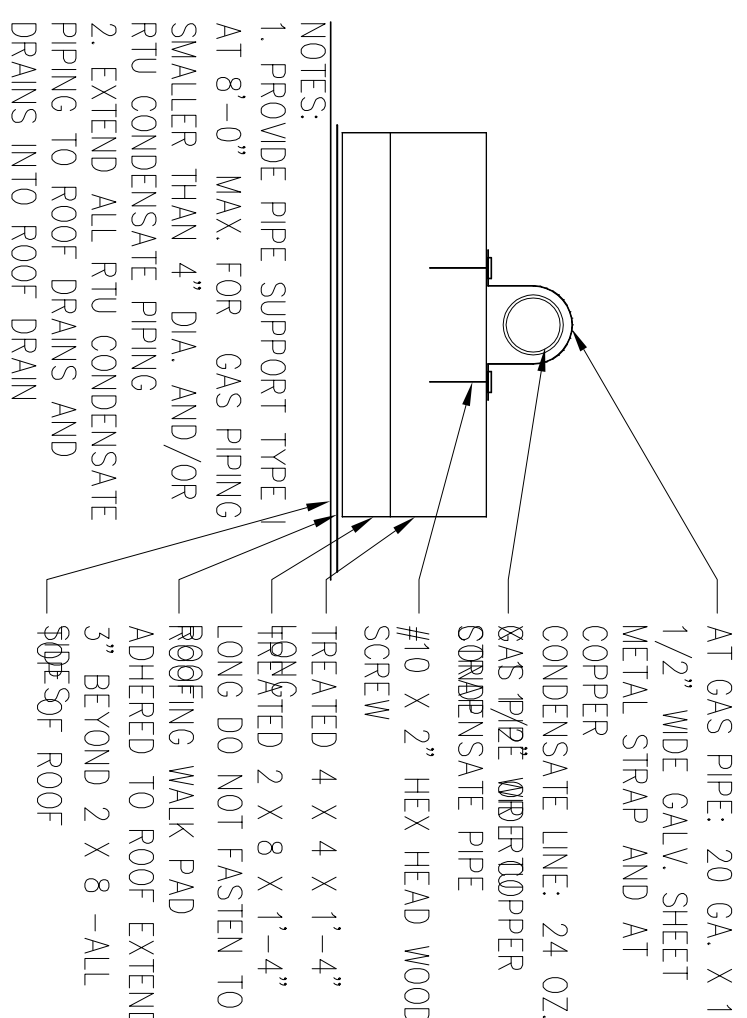


3C PIPE SUPPORT TYPE 1  
3/8"=1'-0"

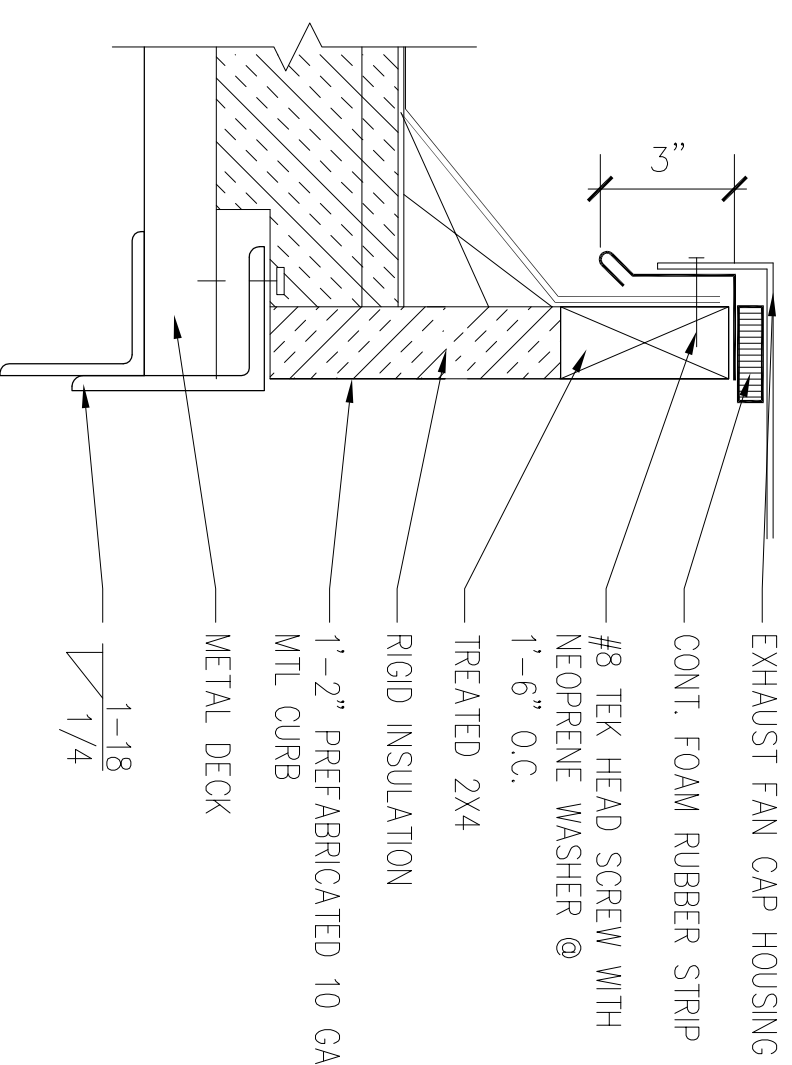


4C EXHAUST FAN CURB  
3/8"=1'-0"

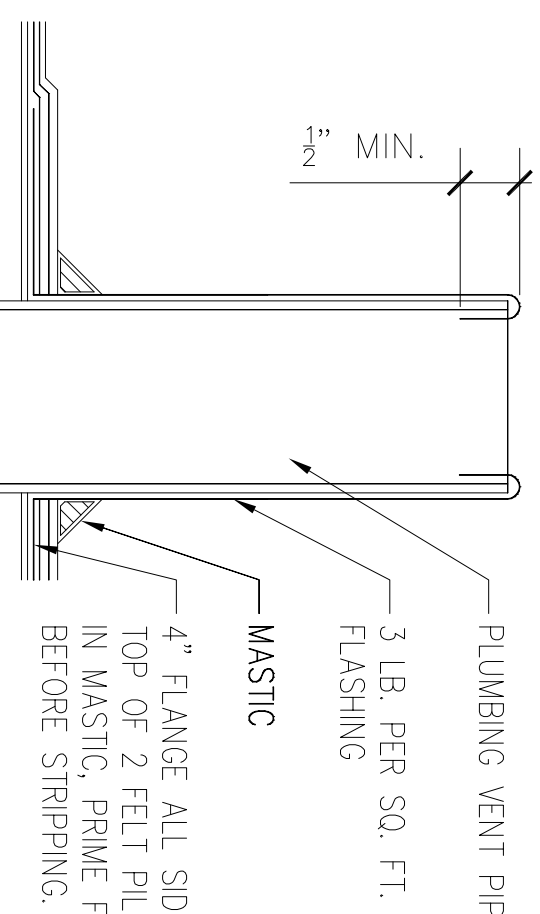


3B ROOF VENT  
3/8"=1'-0"

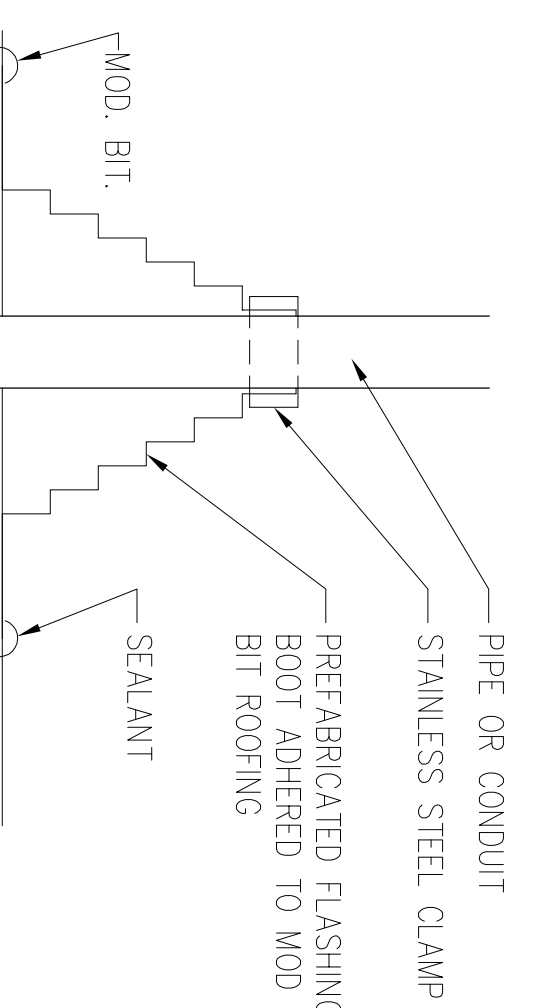


4B PIPE/CONDUIT FLASHING  
3/8"=1'-0"

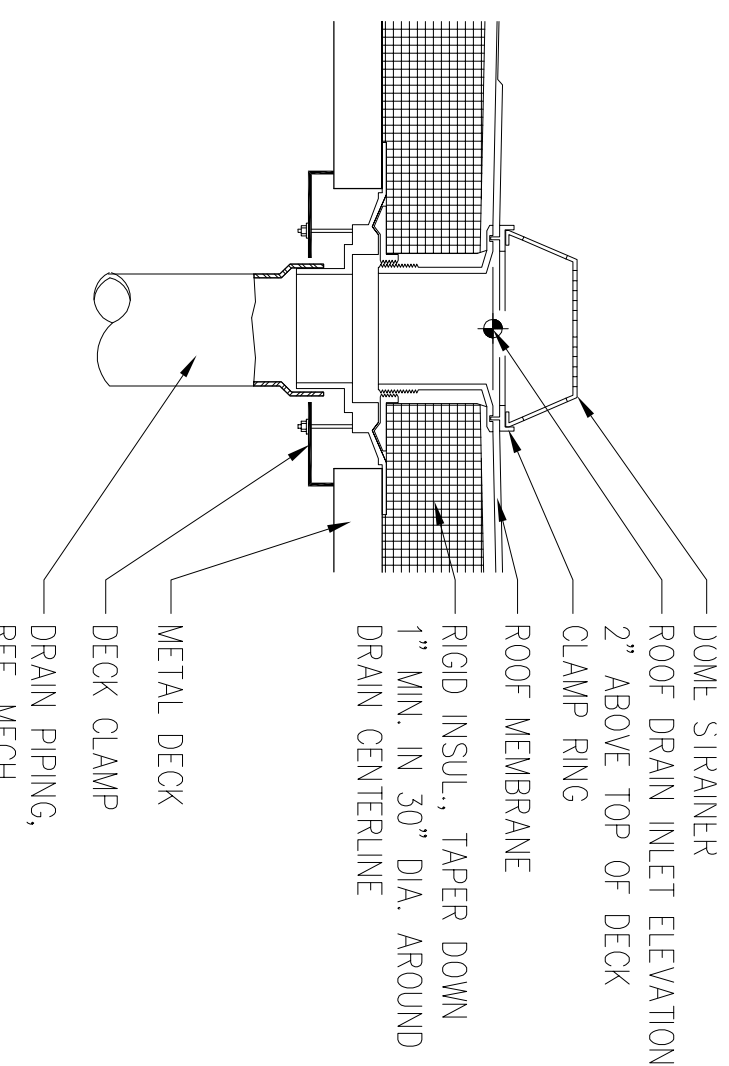

3A ROOF DRAIN  
1"=1'-0"

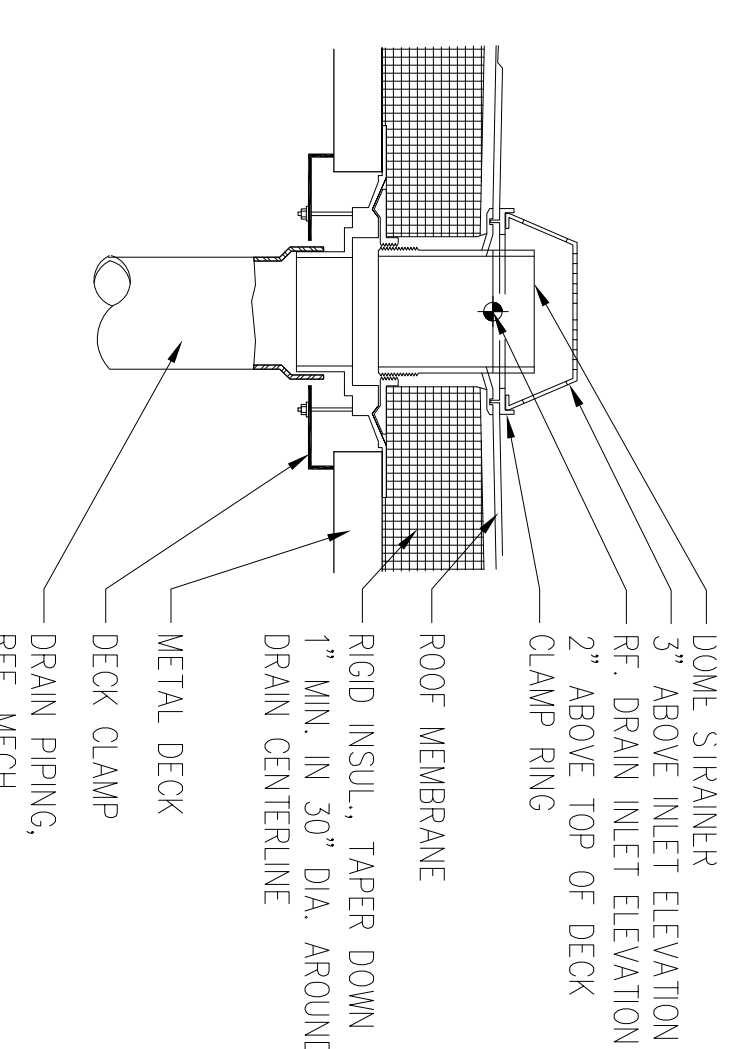

4A OVERFLOW ROOF DRAIN  
1"=1'-0"

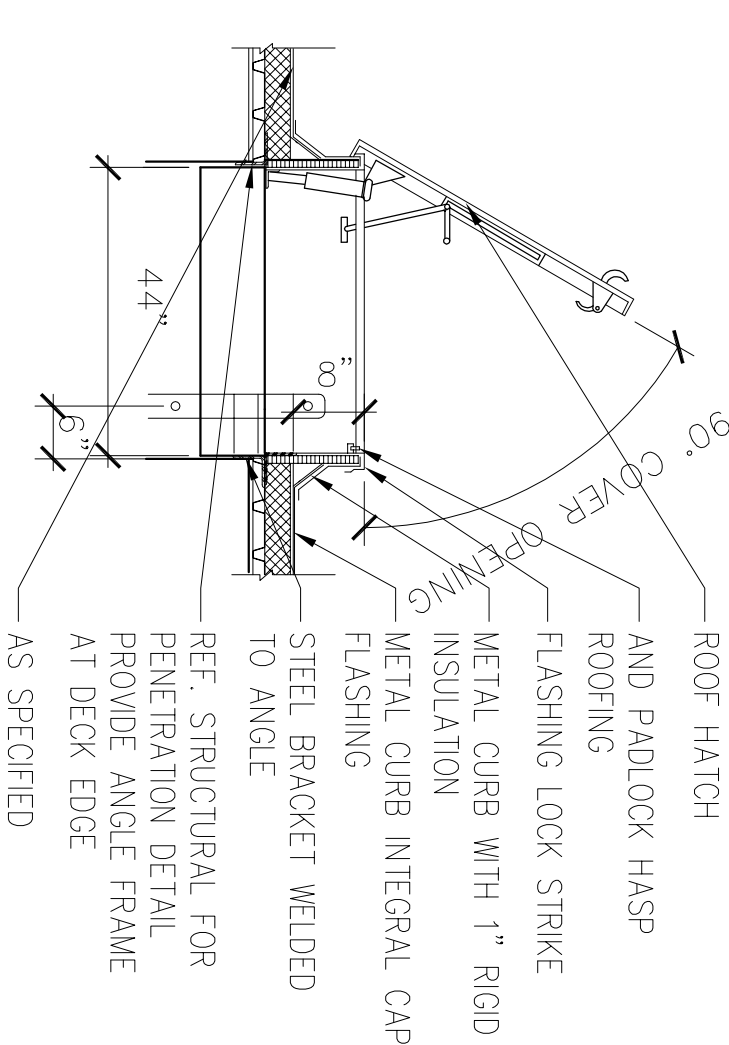

5A ROOF HATCH DETAIL  
1/2"=1'-0"

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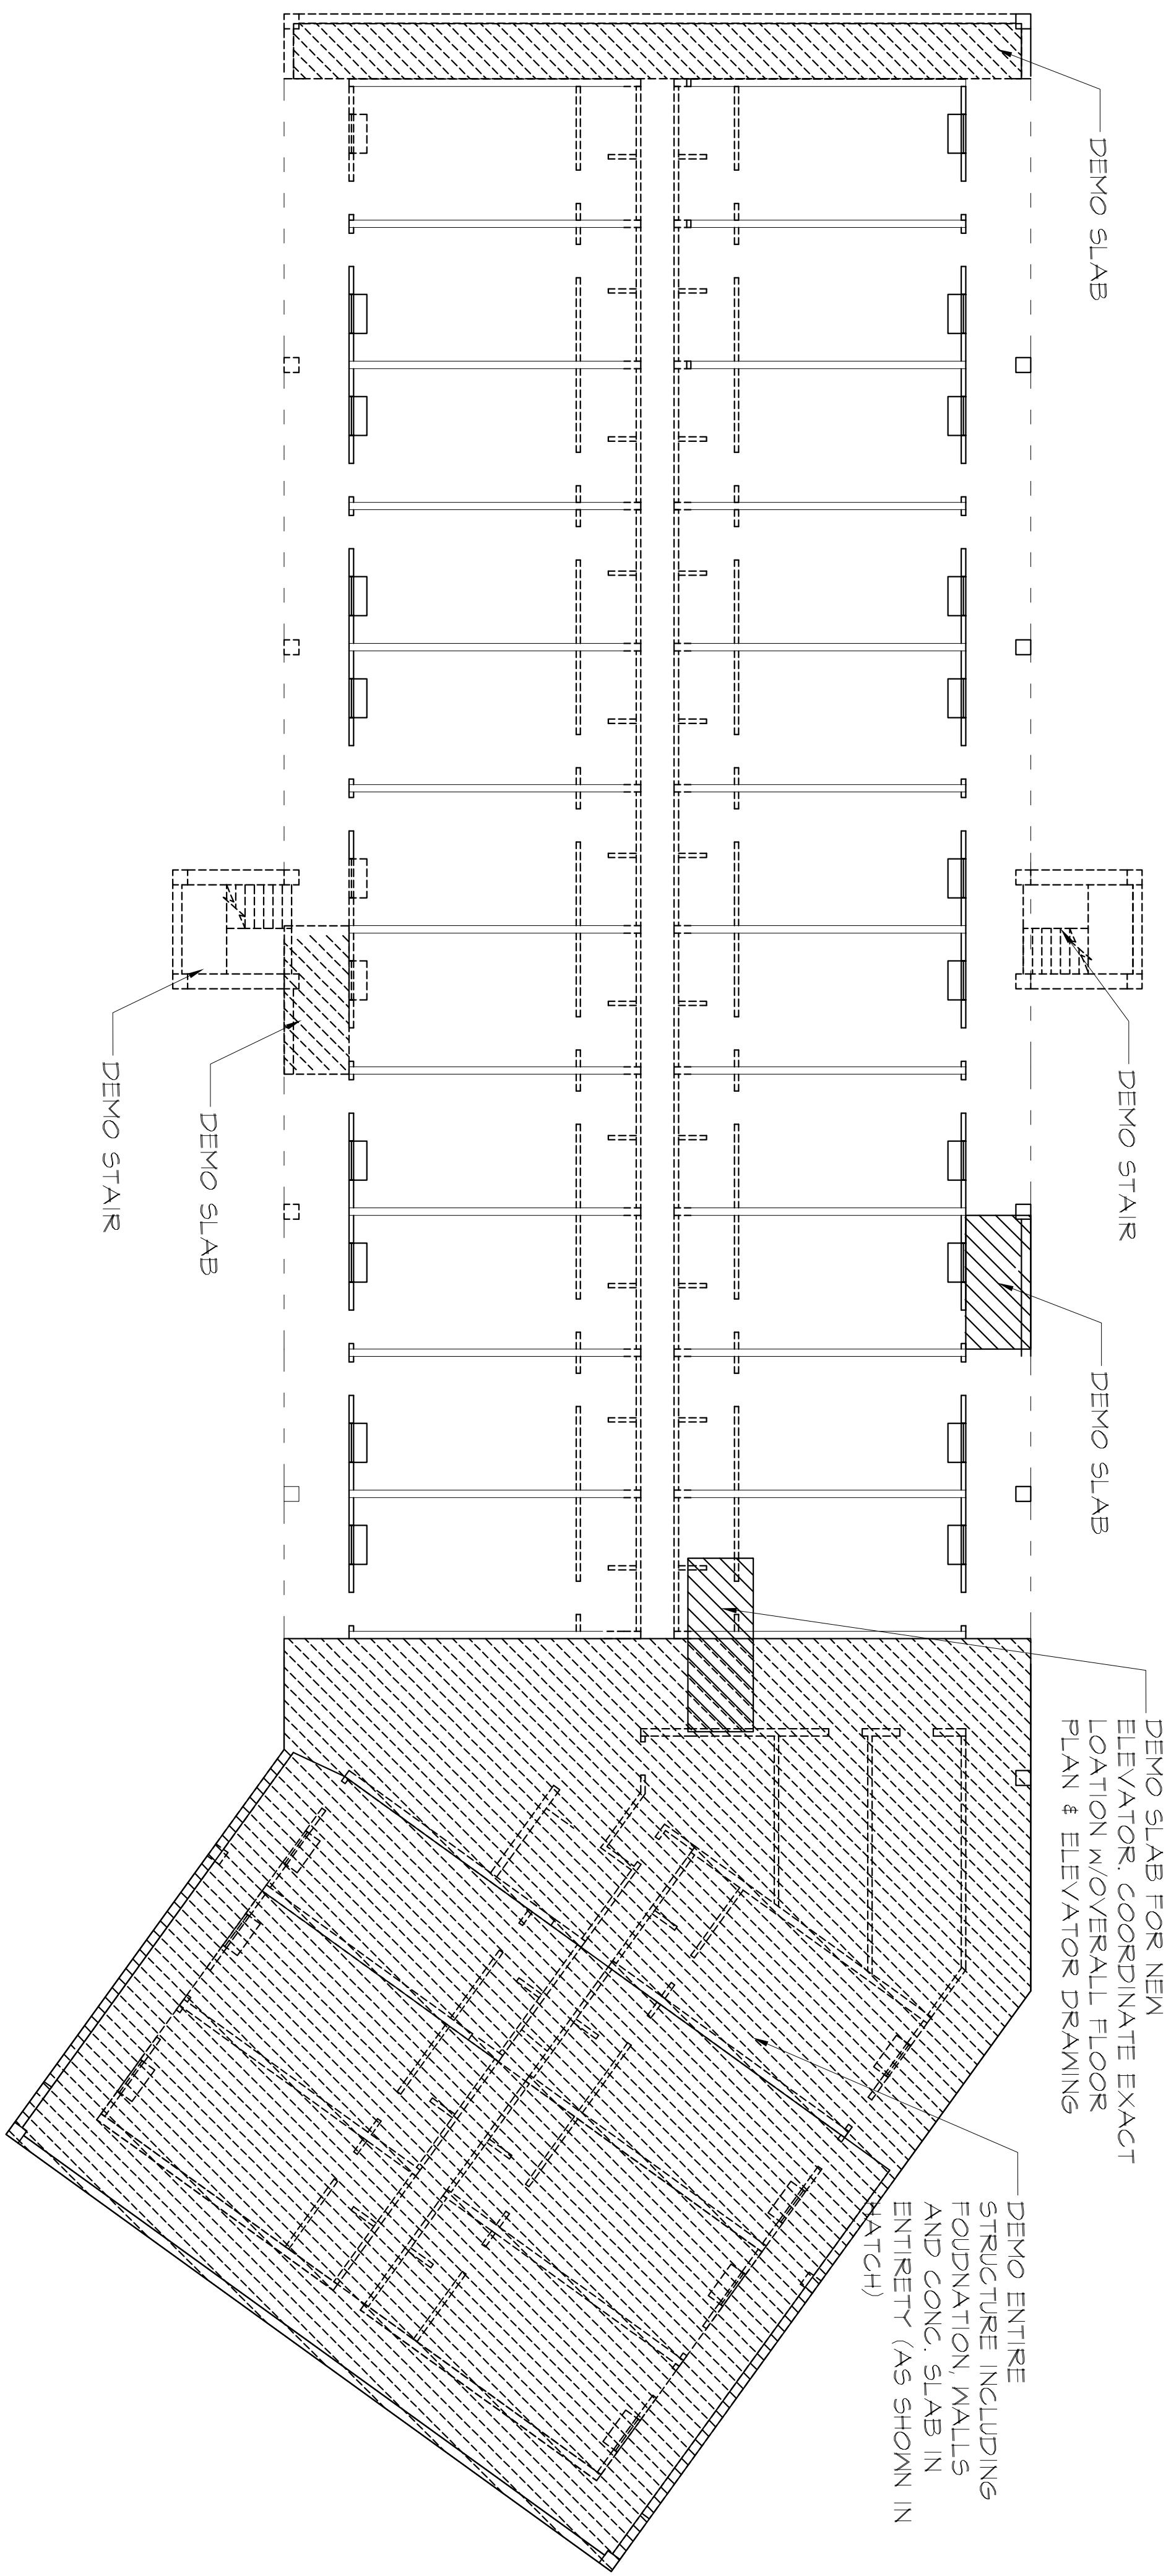
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MARRIOTT  
290 POWER DRIVE,  
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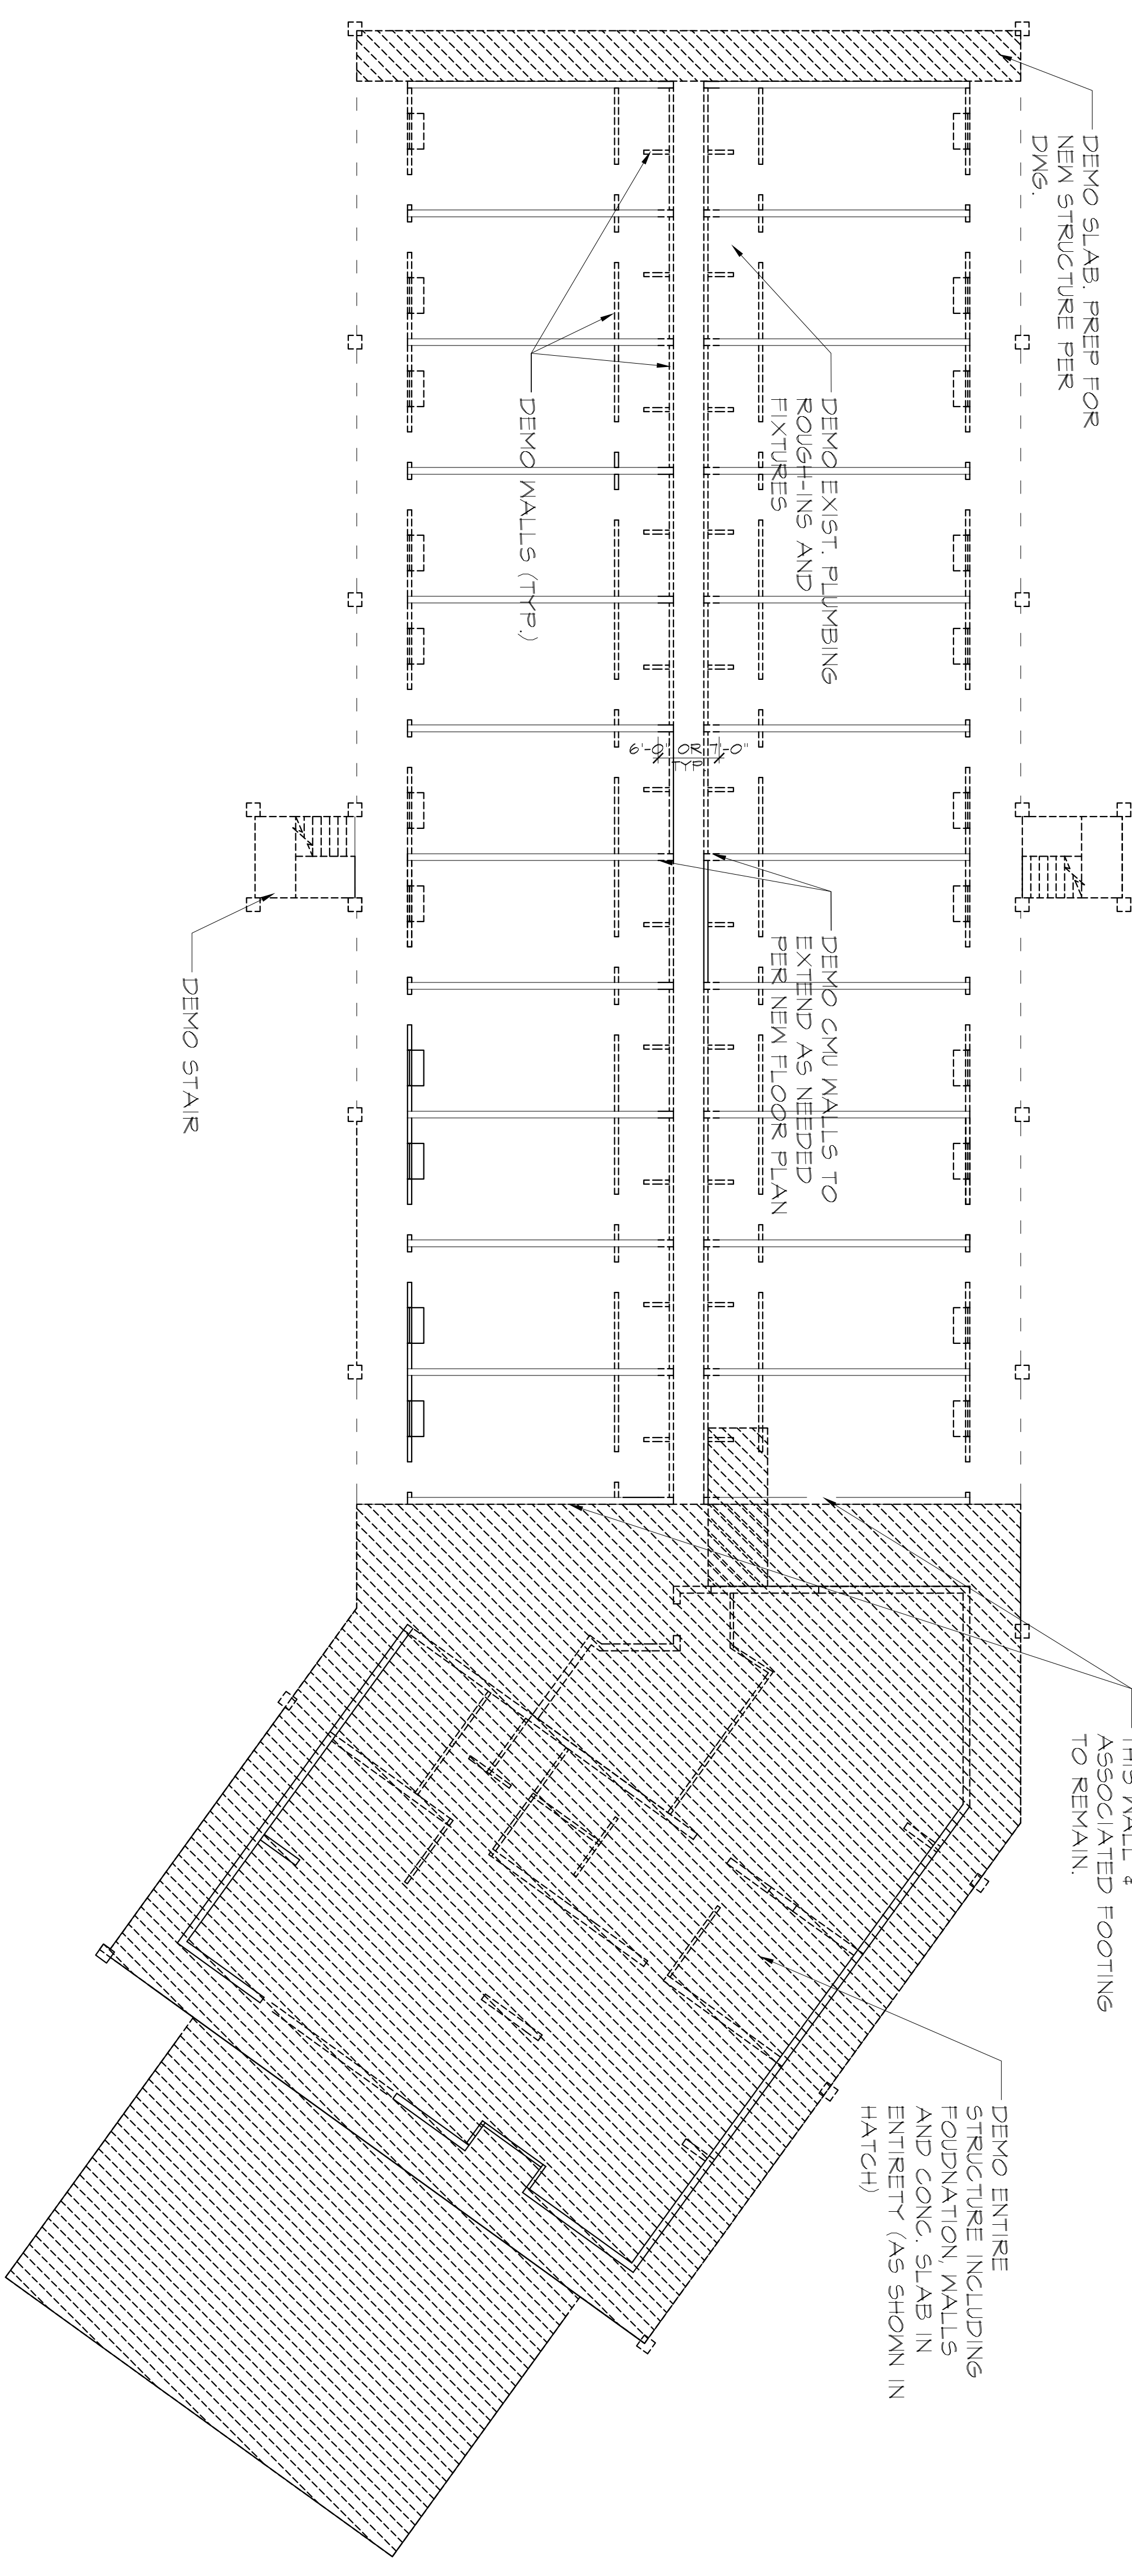
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3	12/22/2015	100% REVIEW SET

PROJECT NAME:	
DRAWING NUMBER:	15180
SHEET NAME:	ROOF DETAILS
DRAWN BY/CHK:	BBC
CHECKED BY:	BBC
DATE:	12-22-15
SCALE:	AS NOTED
DRAWING NUMBER:	<b>G105</b>

1 2 3 4 5



1C DEMO - SECOND FLOOR PLAN  
SCALE 3/32"=1'-0"



1A DEMO-FIRST FLOOR PLAN  
SCALE 3/32"=1'-0"

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CONSTRUCTION**

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PROJECT NAME:

PROJECT NUMBER: 15180

DRAWING NAME:

SHEET NAME:

DEMO


DRAWN BY: BNC, BBC

CHECKED BY: BBC

DATE: 12-22-15

SCALE: AS NOTED

DRAWING NUMBER  
**AD100**

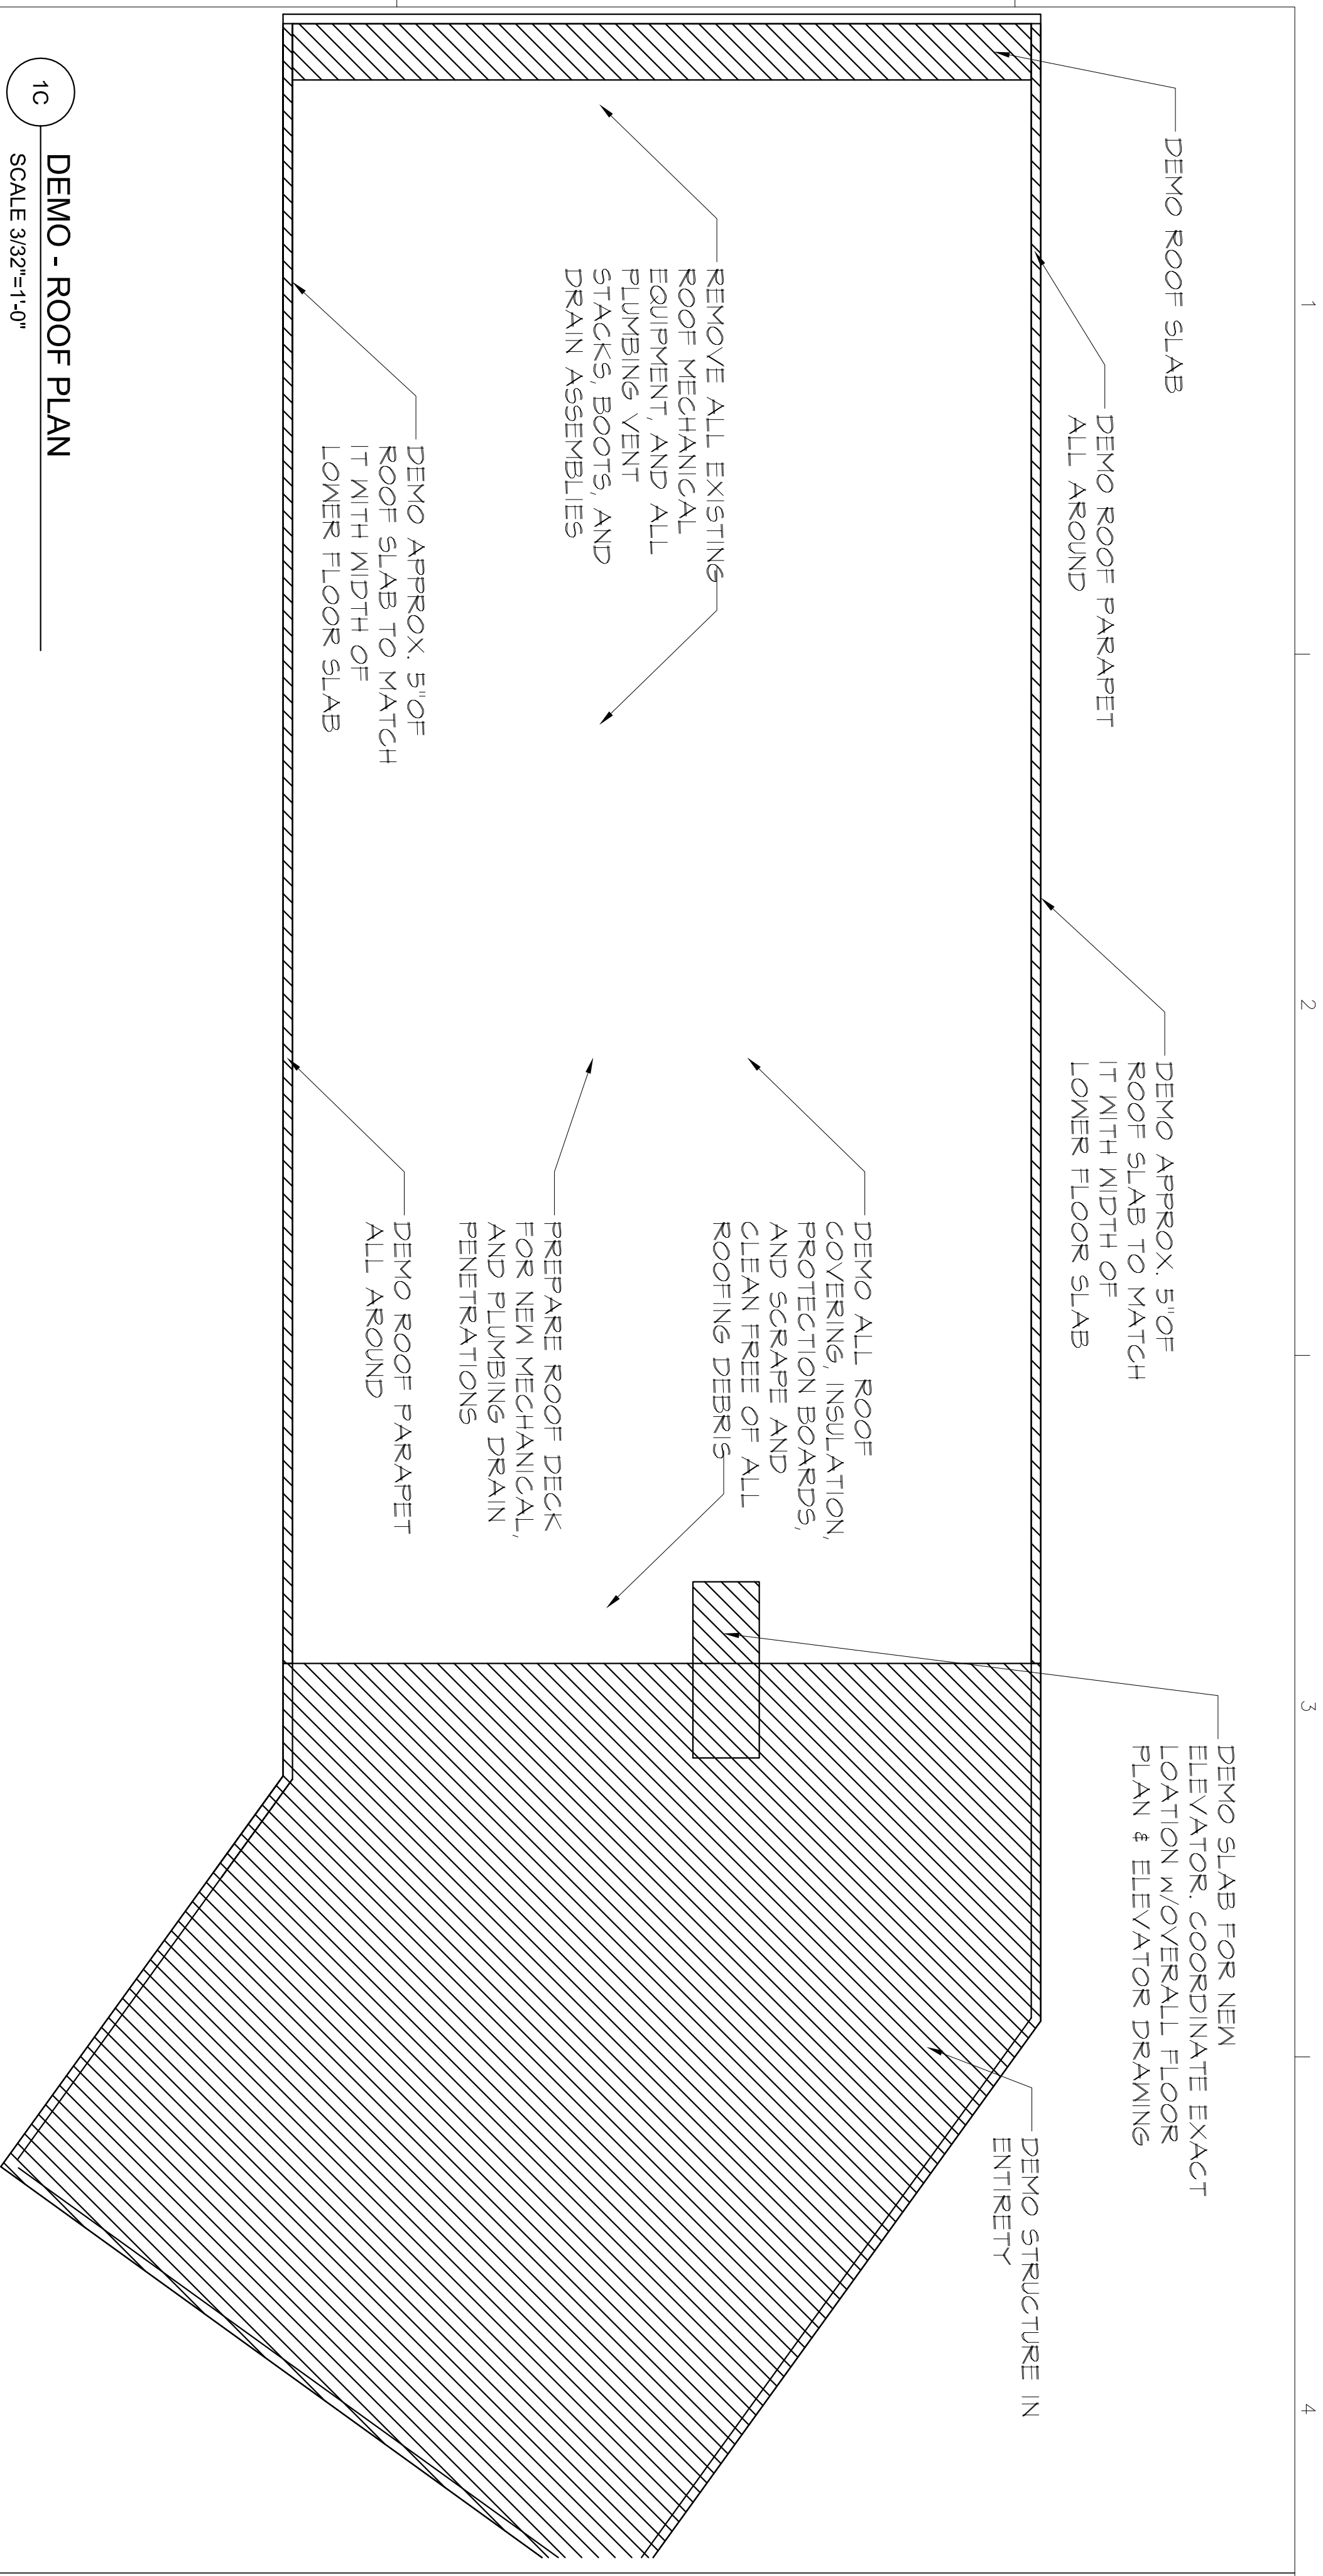

**1C DEMO - ROOF PLAN**  
SCALE 3/32"=1'-0"

**DEMOLITION NOTES:**

THE CONTRACTOR SHALL BE RESPONSIBLE TO CONDUCT DEMOLITION OPERATIONS TO PREVENT DAMAGE TO ADJACENT BUILDINGS, STRUCTURES AND OTHER FACILITIES AND INJURY TO PERSONS. THE CONTRACTOR IS TO PROVIDE SUFFICIENT PROTECTION WITHIN AND BEYOND DEMOLITION AREAS TO ELIMINATE ANY RISK TO CONSTRUCTION PERSONNEL, AND/OR OTHER THIRD PARTY INDIVIDUALS.

THE CONTRACTOR TO REMOVE ALL INDICATED EXISTING CONSTRUCTION MATERIALS/REMOVE ALL INDICATED DOORS, DOOR FRAMES, CEILING ELECTRICAL, AND TELEPHONE WIRING AS REQUIRED BY CODE (SLAB MUST BE CLEAN AND CLEAR OF ALL DEVICES) MILLWORK, AND FINISHES, INCLUDING BUT NOT LIMITED TO CARPET, CARPET PAD, RUBBER CUSHION PARABALL BASE, AND WALL COVERING. DEMOLISH GYPSUM BOARD AND ANY OTHER MATERIALS/FINISHES FROM WALLS OR COLUMN FACES AS NECESSARY TO REDUCE COLUMNS TO MINIMUM REQUIRED SIZE.

1. DEMOLISH AND REMOVE EXISTING CONSTRUCTION ONLY TO THE EXTENT REQUIRED BY NEW CONSTRUCTION AND AS INDICATED. USE METHODS REQUIRED TO COMPLETE WORK WITHIN LIMITATION OF GOVERNING REGULATIONS AND AS FOLLOWS:
  1. NEATLY CUT OPENINGS AND HOLES PLUMB, SQUARE AND TRUE TO DIMENSIONS REQUIRED. USE CUTTING METHODS LEAST LIKELY TO DAMAGE CONSTRUCTION MATERIALS TO REMAIN OR ADJOINING CONSTRUCTION.
  2. CUT OR DRILL FROM THE EXPOSED OR FINISHED SIDE INTO CONCEALED SURFACES TO AVOID MARKING EXISTING FINISHED SURFACES.
  3. DO NOT USE CUTTING TORCHES UNTIL WORK AREA IS CLEARED OF FLAMMABLE MATERIALS. AT CONCEALED SPACES, VERIFY CONDITION AND CONTENTS OF HIDDEN SPACE BEFORE STARTING FLAME-CUTTING OPERATIONS. MAINTAIN ADEQUATE VENTILATION WHEN USING CUTTING TORCHES.
  4. REMOVE DECAYED, VERMIN-INFESTED OR OTHERWISE DANGEROUS OR UNSUITABLE MATERIALS AND PROMPTLY DISPOSE OF OFF-SITE.
  5. LOCATE DEMOLITION EQUIPMENT THROUGHOUT THE STRUCTURE AND REMOVE DEBRIS AND MATERIALS SO AS NOT TO IMPOSE EXCESSIVE LOADS ON SUPPORTING WALLS, FLOORS OR FRAMING.
  6. RETURN ELEMENTS OF CONSTRUCTION AND SURFACES TO REMAIN BEFORE START OF DEMOLITION.

6. VERIFY ALL NEW OPENING DIMENSIONS PRIOR TO CUTTING WALLS, FLOOR OR ROOF OPENINGS.

4. SALVAGE CLEAN AND STORE (WRAP AS NECESSARY FOR ADEQUATE PROTECTION) ALL LIGHT FIXTURES, DOORS, DOOR FRAMES, USABLE DOOR HARDWARE, SWITCHES, THERMOSTATS, RECEPTACLE COVERS, EXIT SIGNS, FIRE EXTINGUISHERS, SMOKE DETECTORS, CEILING TILES, AND HVAC SUPPLY DIFFUSERS FOR REINSTALLATION. PROVIDE COMPLETE LIST OF SALVAGED ITEMS TO THE ARCHITECT AND COORDINATE STORAGE OF THESE ITEMS WITH BUILDING MANAGER.
5. ALL ITEMS FOR REUSE SHALL BE PROTECTED, REPAIRED, CLEANED, AND FINISHED TO A LIKE-NEW CONDITION.
6. THE CONTRACTOR IS RESPONSIBLE FOR OBTAINING THE BUILDING MANAGEMENT'S REQUIREMENTS PRIOR TO BEGINNING WORK. ALL WORK SHALL BE DONE IN ACCORDANCE WITH THE BUILDING OWNERS REQUIREMENTS AND STANDARD OPERATING PROCEDURES FOR DEMOLITION ACTIVITIES.

7. THE CONTRACTOR SHALL COORDINATE WITH LOCAL CODE OFFICIALS TO ENSURE THAT DEMOLITION OPERATIONS ARE CONDUCTED IN COMPLIANCE WITH ALL APPLICABLE CODES.
8. THE CONTRACTOR SHALL PROVIDE AND MAINTAIN ALL EXISTING EXITS, EXIT LIGHTING, FIRE PROTECTION DEVICES, AND ALARMS TO CONFORM TO LOCAL BUILDING CODE REQUIREMENTS.
9. MAINTAIN STRUCTURAL INTEGRITY OF BUILDING WHERE STRUCTURAL COLLAPSE HAS OCCURRED WITH STRONG-BACK SUPPORT BRACING OR FLOOR JOISTS, TRUSS FRAMING MEMBERS, OR STRUCTURAL GIRDERS.
10. MAINTAIN RATINGS FOR DOORS, WALLS AND CEILING ASSEMBLIES AT ALL INTERSECTIONS, CONNECTIONS, AND PENETRATIONS, AS REQUIRED PER APPLICABLE BUILDING CODES.
11. DEBRIS RESULTING FROM DEMOLITION AND CONSTRUCTION SHALL BE REMOVED DAILY FROM THE CONSTRUCTION SITE TO A WASTE AREA PROVIDED BY THE CONTRACTOR IN COORDINATION WITH BUILDING OWNER. REMOVE DEBRIS FROM BUILDING BY CHUTE, HOIST OR OTHER DEVICE AS APPROVED BY PROJECT OWNER.
12. LIMIT USE OF THE PREMISES TO CONSTRUCTION ACTIVITIES IN AREAS INDICATED AS SCOPE OF PROJECT; ALLOW OWNER OCCUPANCY AND USE BY BUILDING'S DRIVERS MAINTENANCE AND SERVICE PERSONNEL AT ALL TIMES.
13. ALL DRIVEWAYS AND CIRCULATION PATHS SHALL REMAIN OPEN AND AVAILABLE TO OWNER.

**GENERAL NOTES:**

1. ALL MATERIAL FINISH AND COLOR SELECTION SHALL BE APPROVED BY THE ARCHITECT PRIOR TO INSTALLATION.
2. ALL WORK AND CONSTRUCTION SHALL MEET OR EXCEED ALL CODES, ORDINANCES, AND REGULATIONS OF THE CITY OF SOUTHAVEN, AND DESOTO COUNTY (MISSISSIPPI), AND THE MISSISSIPPI STATE DEPARTMENT OF HEALTH IN JACKSON, MISSISSIPPI.
3. ERRORS OR OMISSIONS IN THE DRAWING CONTAINED HEREWITH, DO NOT RELIEVE THE GENERAL CONTRACTOR FROM EXECUTION OF THE INTENDED WORK IN THE CONTRACT DOCUMENTS. NOTIFY THE ARCHITECT UPON NOTICE OF ANY DISCREPANCY.
4. VERIFY ALL DIMENSIONS, CONDITIONS, EXISTING GRADES AND UTILITIES RELATED TO THIS EXISTING BUILDING AND PROJECT SITE PRIOR TO EXECUTION OF WORK. REPORT ANY AND ALL DISCREPANCIES TO THE ARCHITECT FOR CLARIFICATION. WAIT FOR A WRITTEN RELEASE OR VERBAL STATEMENT TO PROCEED FROM THE ARCHITECT.
5. THE CONTRACTOR SHALL BE RESPONSIBLE FOR ANY EXISTING CONDITION DAMAGED DURING CONSTRUCTION, EXISTING EQUIPMENT, OR NEW EQUIPMENT. NEW IMPROVEMENTS NOT INDICATED IN THE DRAWINGS OR SPECIFICATIONS TO RECEIVE ALTERATIONS, ADDITIONS, OR ITS REMOVAL.
6. THE CONTRACTOR SHALL BEAR THE FULL EXPENSE FOR UNDERGROUND DAMAGE AND REPAIR TO EXISTING UTILITY PIPES, CONDUIT AND MISCELLANEOUS EQUIPMENT DURING THE COURSE OF CONSTRUCTION.
7. ALL EXTERIOR EXPOSED WORK SHALL BE INSTALLED WITH WEATHER TIGHT PROFESSIONAL WORKSMANSHIP MANNERS AND WITH WEATHER BARRIER MATERIALS AS REQUIRED FOR THOSE CONDITIONS.
8. FIRE BLOCKING SHALL BE INSTALLED AT THE THIRD POINTS IN ALL WALLS AND PARTITIONS TO CUT OFF THE CONCEALED DRAFT OPENINGS BOTH HORIZONTAL AND VERTICAL, AND TO FORM A FIRE BARRIER BETWEEN RATED FLOOR ASSEMBLIES, OR BETWEEN RATED ROOF ASSEMBLIES WITH RATED CEILING PROTECTION, AS REQUIRED BY THE LOCAL CODE AUTHORITIES.
9. FIRE RESISTIVE MATERIAL CONSTRUCTION IS TO BE INSTALLED AT ALL MECHANICAL, ELECTRICAL, AND PLUMBING ASSEMBLIES THAT PENETRATE FIRE RATED WALLS, RATED FLOOR RATED CEILING WITH ROOF ASSEMBLIES. THE CONTRACTOR SHALL SUBMIT ALL UL PENETRATION DETAILS INTENDED FOR CONSTRUCTION OF WORK FOR THIS PROJECT.
10. ALL RATED WALL ASSEMBLIES MUST EXTEND THROUGH RATED CEILING ASSEMBLIES, AND BE SEALED TIGHT TO THE ROOF DECK, FLOOR ASSEMBLIES WITH FIRE SAFE CAULKING APPLIED BETWEEN FRAMING TRACKS, BEAMS, OR GIRDERS, COMPLETELY SEAL AROUND ALL FRAMING TIGHT TO THE FLOOR ASSEMBLY OR ROOF DECK. CONTINUITY OF THE FIRE RATING MUST ABSOLUTELY BE MAINTAINED.
11. CORRIDOR PARTITIONS, SMOKESTOP PARTITIONS, HORIZONTAL EXIT PARTITIONS, EXIT ENCLOSURES AND FIRE WALLS SHALL BE EFFECTIVELY AND PERMANENTLY IDENTIFIED WITH SIGNS OR PAINTED STENCIL MARKINGS ACCEPTABLE TO LOCAL OFFICIALS. RATING IDENTIFICATIONS SHALL BE LOCATED ABOVE DECORATIVE CEILINGS, AND IN CONCEALED SPACES. APPLY THE FOLLOWING STATEMENTS WITH 3" LETTERS: "RATED FIRE AND SMOKE BARRIER", "PROTECT ALL OPENINGS PER SIFPC 504.9.2"
12. ALL ELECTRICAL POWER DUPLEX BOXES LOCATED ON OPPOSITE SIDES OF ANY FIRE RATED WALL ASSEMBLY SHALL BE STAGGERED WITH A SEPARATION OF 24" MINIMUM, HORIZONTALLY.
13. FIRE WALLS, FIRE STOPS AND FIRE RATED PARTITIONS, AND FLOOR ASSEMBLIES REQUIRED BY THE BUILDING CODE SHALL BE MAINTAINED. ALL OPENINGS MADE THEREIN FOR THE PASSAGE OF MECHANICAL, ELECTRICAL AND PLUMBING PIPES, AND HOLES MADE FOR ANY REASON SHALL BE SEALED WITH APPROVED NONCOMBUSTIBLE MATERIAL TO PROTECT AGAINST THE PASSAGE OF SMOKE AND FIRE. ALL OPENINGS THROUGH THESE PARTITIONS (IE ACCESS DOORS) SHALL BE PROTECTED BY SELF CLOSING OR AUTOMATIC DOORS OF APPROVED CONSTRUCTION MEETING THE PARTITION REQUIREMENTS.
14. ALL FIRE EXTINGUISHERS SHALL BE CONSPICUOUSLY MOUNTED WHERE THEY WILL BE READILY ACCESSIBLE AND IMMEDIATELY AVAILABLE IN THE EVENT OF A FIRE. LOCATE FIRE EXTINGUISHERS ALONG THE NORMAL TRAVEL PATH OF EXIT FROM THE AREA.
25. ALL PROPOSED CHANGES AND MODIFICATIONS, AND/OR SUBSTITUTIONS TO THE CONTRACT DOCUMENTS SHALL BE SUBMITTED IN WRITING AS A REQUEST FOR PROPOSAL, AND IF APPROVED, THEN THE ARCHITECT WILL PREPARE A FORMAL C. ORDER TO CONTRACT FOR APPROVAL WITH THE SIGNATURE OF THE OWNER, CONTRACTOR, AND THE ARCHITECT.

21. PROMPTLY PATCH AND REPAIR HOLES AND DAMAGED SURFACES CAUSED BY ADJACENT CONSTRUCTION BY DEMOLITION. RESTORE EXPOSED FINISHES OF PATCHED AREAS AND EXTEND FINISH RESTORATION INTO ADJOINING CONSTRUCTION TO REMAIN IN A MANNER THAT ELIMINATES EVIDENCE OF PATCHING AND REFINISHING.
20. SWEEP THE PROJECT SITE BROOM CLEAN AND CHANGE FILTERS ON AIR-HANDLING EQUIPMENT UPON COMPLETION OF DEMOLITION.
21. PROVIDE RECORD DRAININGS AT PROJECT CLOSEOUT WHICH IDENTIFY AND ACCURATELY LOCATE CAPPED UTILITIES AND OTHER STRUCTURAL, ELECTRICAL OR MECHANICAL CONDITIONS.
22. UPON COMPLETION OF DEMOLITION SPACE SHOULD BE STRIPED, CLEANED AND MADE READY FOR NEW CONSTRUCTION.
23. COVER AND PROTECT EQUIPMENT AND FIXTURES TO REMAIN FROM SOLING OR DAMAGE WHEN DEMOLITION WORK IS PERFORMED IN AREAS WHERE SUCH ITEMS HAVE NOT BEEN OR CANNOT BE REMOVED.
24. PROTECT EXISTING STEEL ROOF TRUSSES AFTER REMOVAL OF EXISTING RATED CEILING ASSEMBLY COVERING. PREPARE TO MECHANICALLY SURFACE ATTACH NEW LIGHT GAUGE STEEL RESILIENT HAT CHANNELS AT 24" O.C., PERPENDICULAR TO THE BOTTOM CHORD. SEE REFLECTED CEILING PLAN FOR LOCATION OF SURFACE MOUNTED HAT CHANNELS FOR THE NEW INSTALLATION OF ACCOUSTICAL CEILING PANELS.

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DRAWN BY: BBC  
CHECKED BY: BBC  
DATE: 12-22-15  
SCALE: AS NOTED

PROJECT NUMBER: 15180

DRAWING NAME:  
SHEET NAME:  
DEMO



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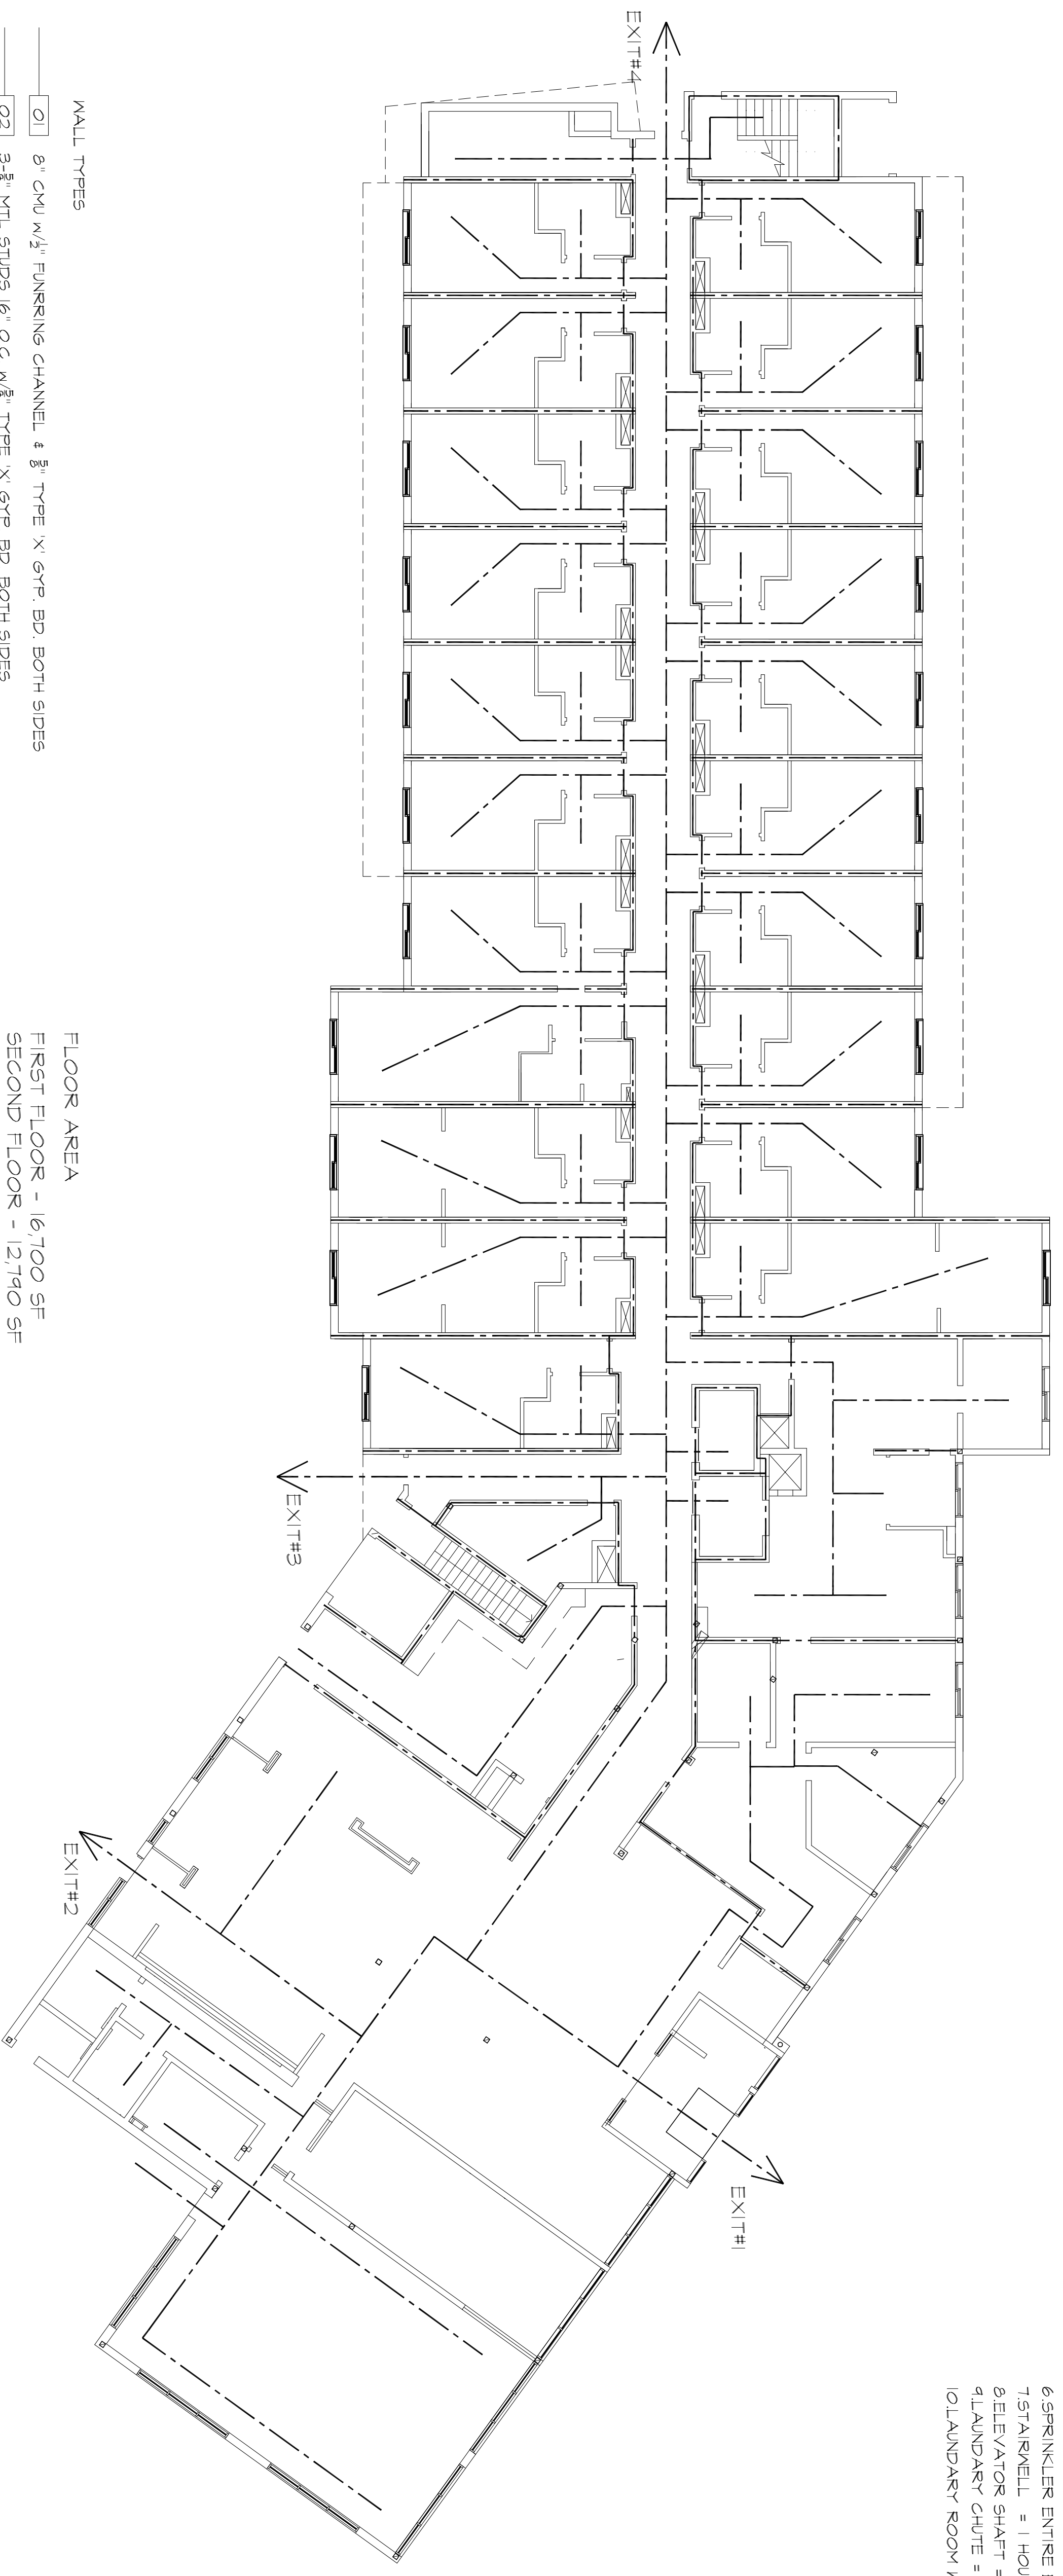
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FLOOR AREA  
 FIRST FLOOR - 16,700 SF  
 SECOND FLOOR - 12,740 SF  
 THIRD FLOOR - 14,500 SF

- WALL TYPES**
- 01 8" CMU W/1/4" FUNKING CHANNEL, 3/8" TYPE 'X' GYP. BD. BOTH SIDES
  - 02 3-5/8" MTL STUDS 16" O.C. W/3/8" TYPE 'X' GYP. BD. BOTH SIDES
  - 03 6" MTL STUDS 16" O.C. W/1 LAYER OF 5/8" TYPE 'X' GYP. BD. BOTH SIDES
  - 1 HOUR RATED PARTITION

**NOTE:**  
 1. FOR WALL TYPES IN GUESTROOMS, REFER TO GUESTROOM ENLARGED PLAN SHEETS  
 2. FOR WALL TYPES IN LOBBY AND OTHER COMMON AREAS, REFER TO ENLARGED PLANS

1B LIFE SAFETY PLAN - FIRST FLOOR  
 SCALE 3/32"=1'-0"

**FIRE RESISTIVE RATING REQUIREMENTS**


BASED ON 2009 IBC, TAB. E-601 (UNLESS NOTED OTHERWISE)	RATING	SHAFT CONSTRUCTION:	1-HOUR
STRUCTURAL FRAME	1-HOUR	(IBC 707.4, WHERE CONNECTING LESS THAN 3 STORES)	
BEARING WALL, INTERIOR	1-HOUR	(IBC 707.4, WHERE CONNECTING 4 STORES OR MORE)	2-HOUR
BEARING WALL, EXTERIOR	1-HOUR	(IBC 707.4, WHERE CONNECTING 4 STORES OR MORE)	2-HOUR
NON-BEARING WALL, EXTERIOR	1-HOUR	(IBC 707.4)	1-HOUR
NON-BEARING CORRIDOR WALLS	1-HOUR	(IBC 707.4)	1-HOUR
MARRIOTT MODULE 14	1-HOUR	STAR ENCLOSURE CONSTRUCTION	1-HOUR
FLOOR CONSTRUCTION:	1-HOUR	(IBC 1020.1, WHERE CONNECTING LESS THAN 4 STORES)	2-HOUR
ROOF CONSTRUCTION:	1-HOUR	(IBC 1020.1, WHERE CONNECTING 4 STORES OR MORE)	1-HOUR
SLEEPING UNIT SEPARATION:	1-HOUR	LAUNDRY CHUTE ACCESS ROOM:	1-HOUR
(IBC 707.1.3.2)		(IBC 707.1.3.2)	

PROJECT NAME:


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 CHECKED BY: BBC  
 DATE: 12-22-15  
 SCALE: AS NOTED

DRAWING NUMBER  
**LS 100**

1 2 3 4 5

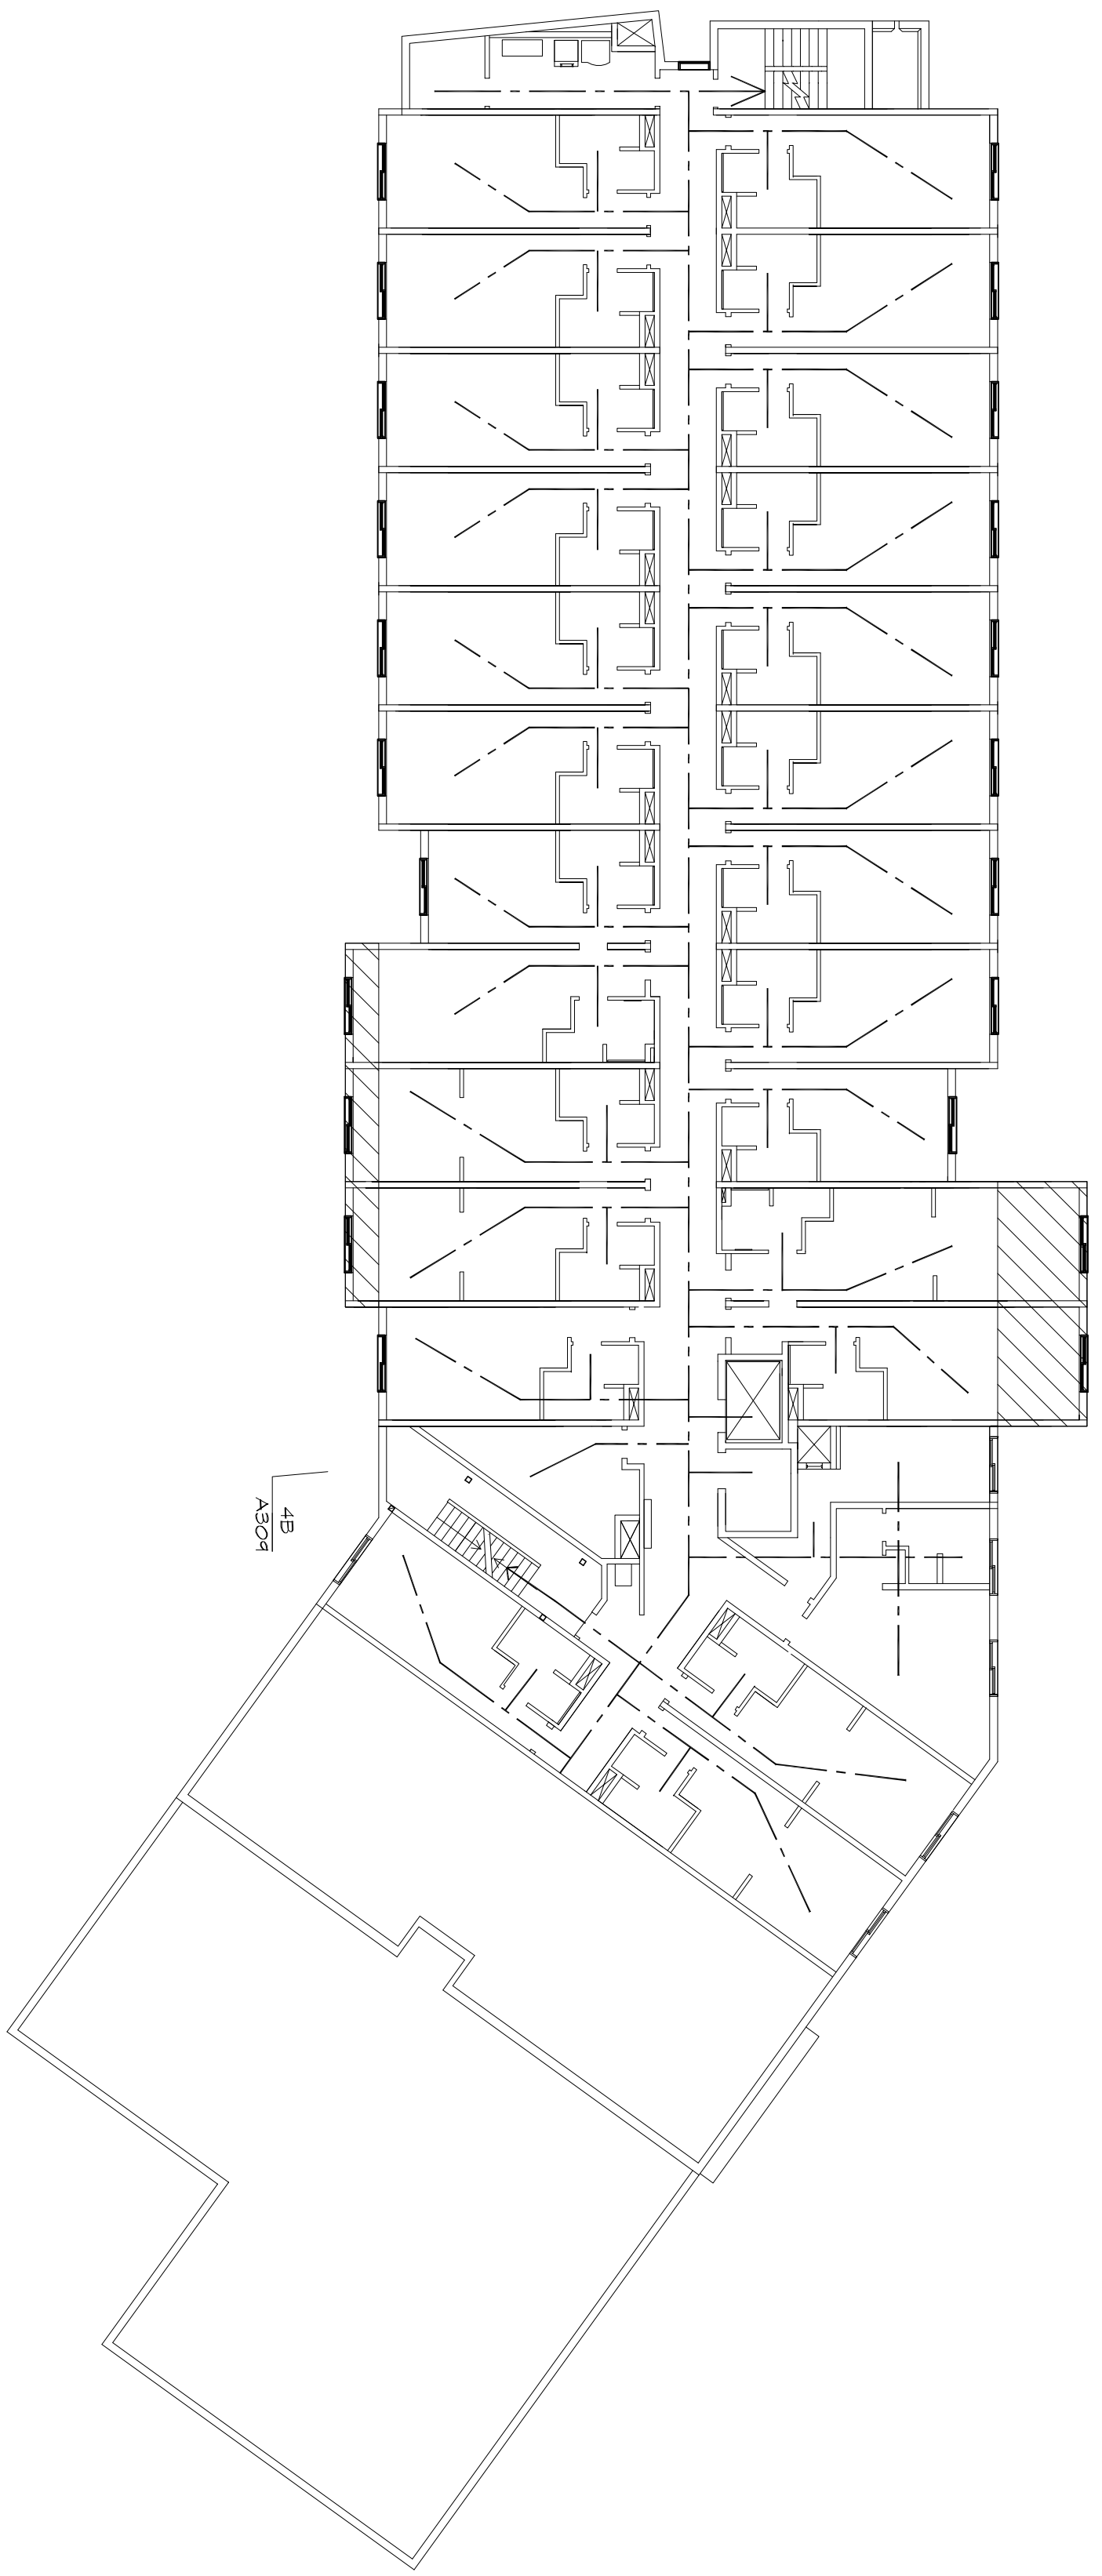

1C LIFE SAFETY PLAN- SECOND FLOOR  
SCALE 1/16"=1'-0"

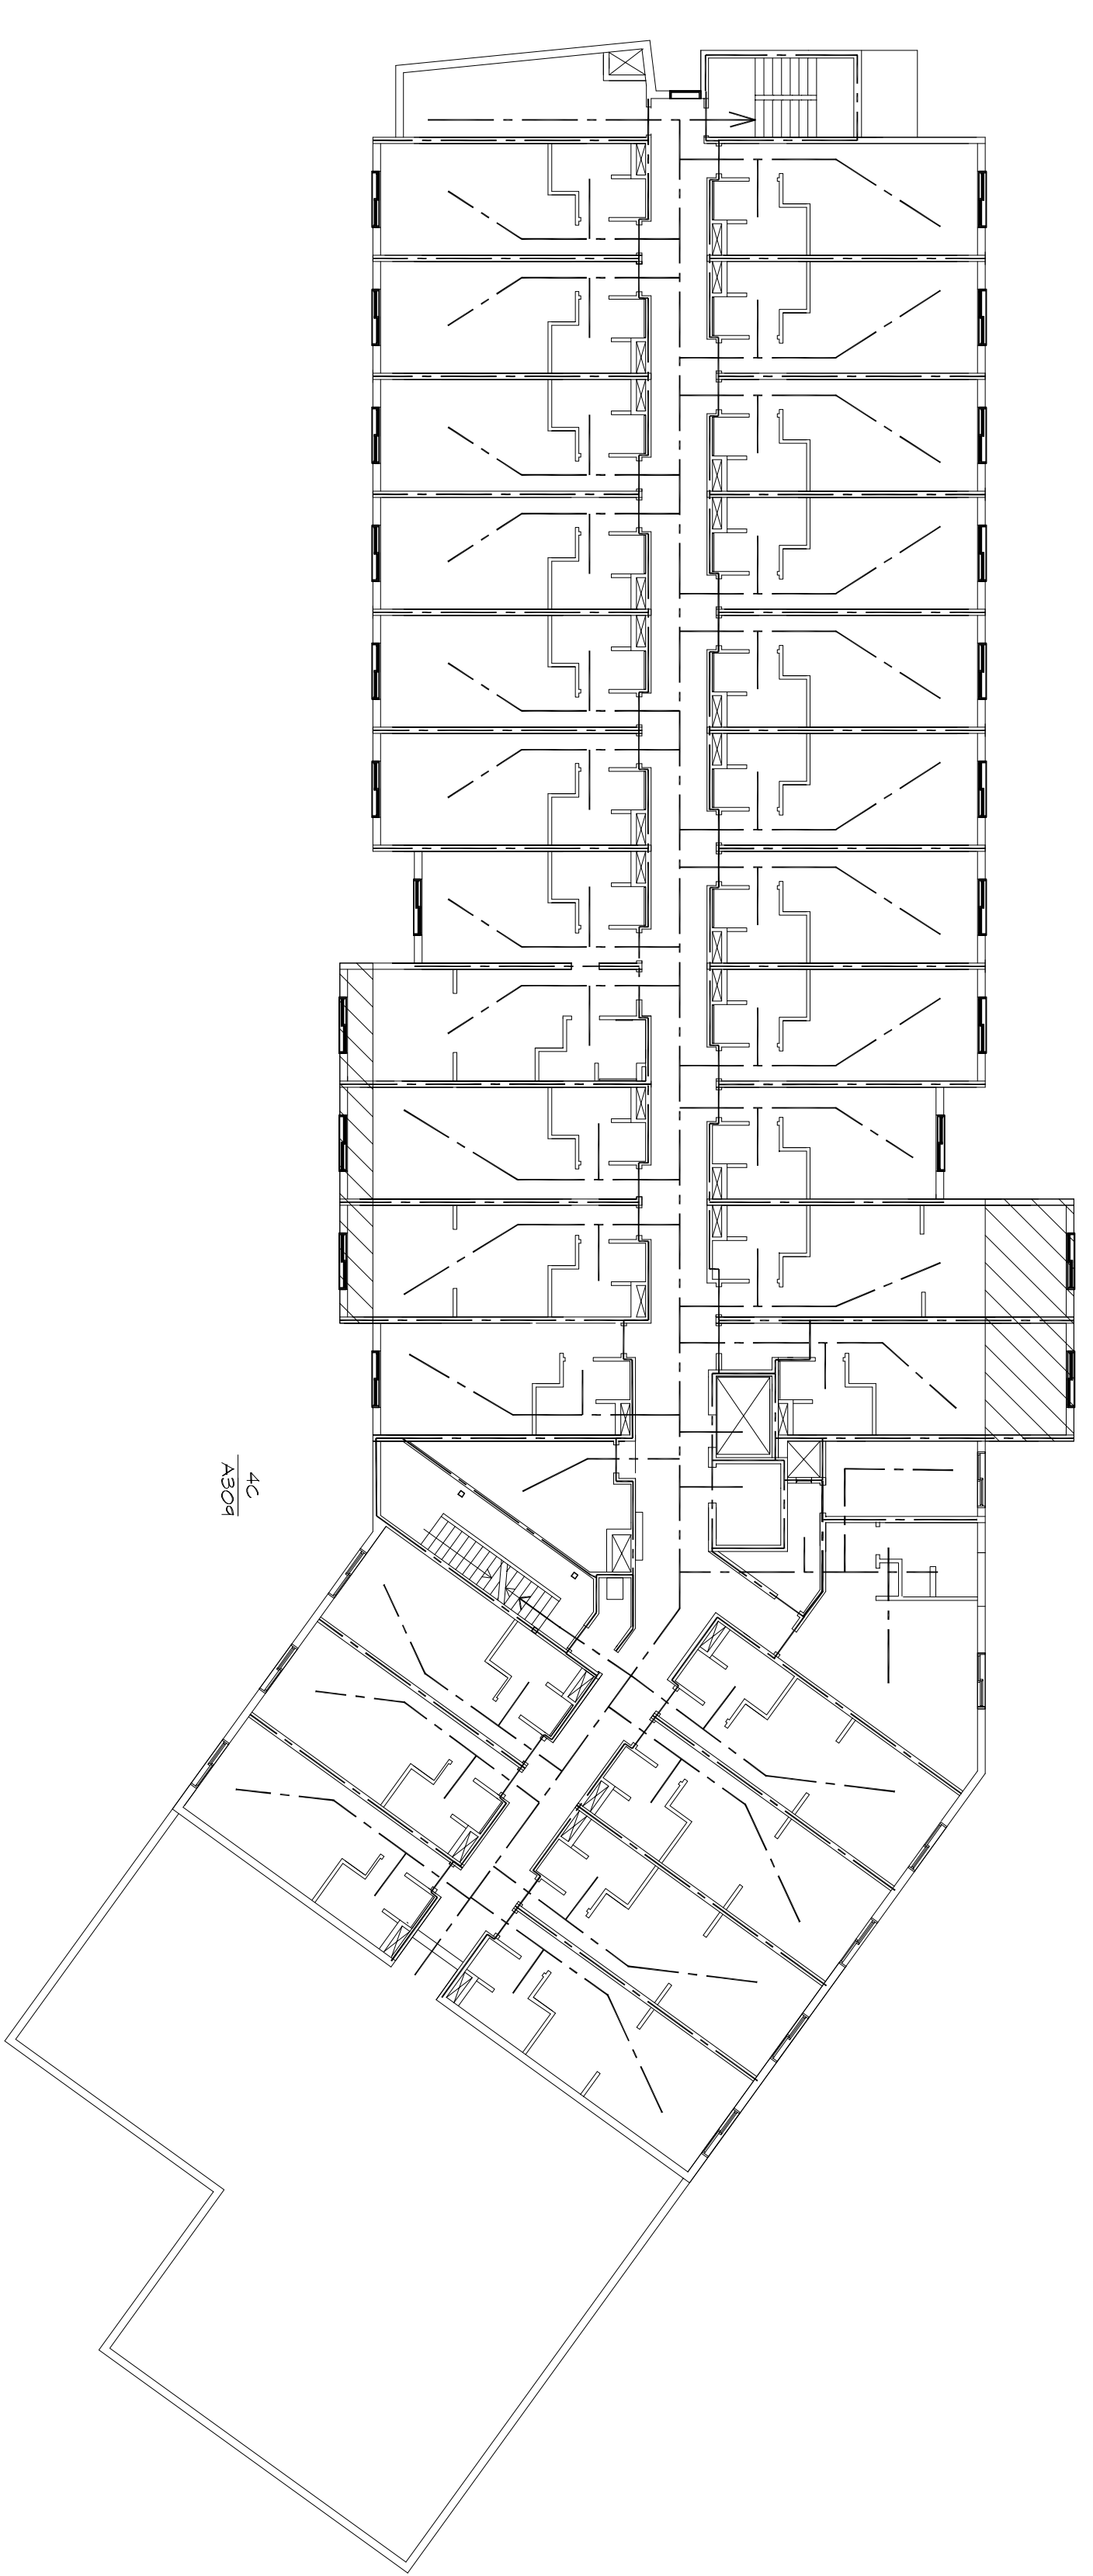

1A LIFE SAFETY PLAN- THIRD FLOOR PLAN  
SCALE 1/16"=1'-0"

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3	12/22/2015	100% REVIEW SET

PROJECT NAME:	
DRAWING NUMBER:	LS 101
SHEET NAME:	LIFE SAFETY PLAN
LIFE SAFETY PLAN	
SECOND AND THIRD FLOOR	

DRAWN BY: NK, BBC  
CHECKED BY: BBC  
DATE: 12-22-15  
SCALE: AS NOTED  
DRAWING NUMBER  
**LS 101**

A B C D

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SCALE

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NO.	DATE	DESCRIPTION
1	06/21/16	50% REVIEW SET
2	11/22/16	60% REVIEW SET
3	12/22/16	100% REVIEW SET

PROJECT NUMBER: 16160


DRAWING NAME:  
**FIRST FLOOR PLAN & NOTES**

SHEET NAME

DRAWN BY: BBC  
 CHECKED BY: BBC  
 DATE: 12-22-15  
 SCALE: AS NOTED

DRAWING NUMBER

**A100**

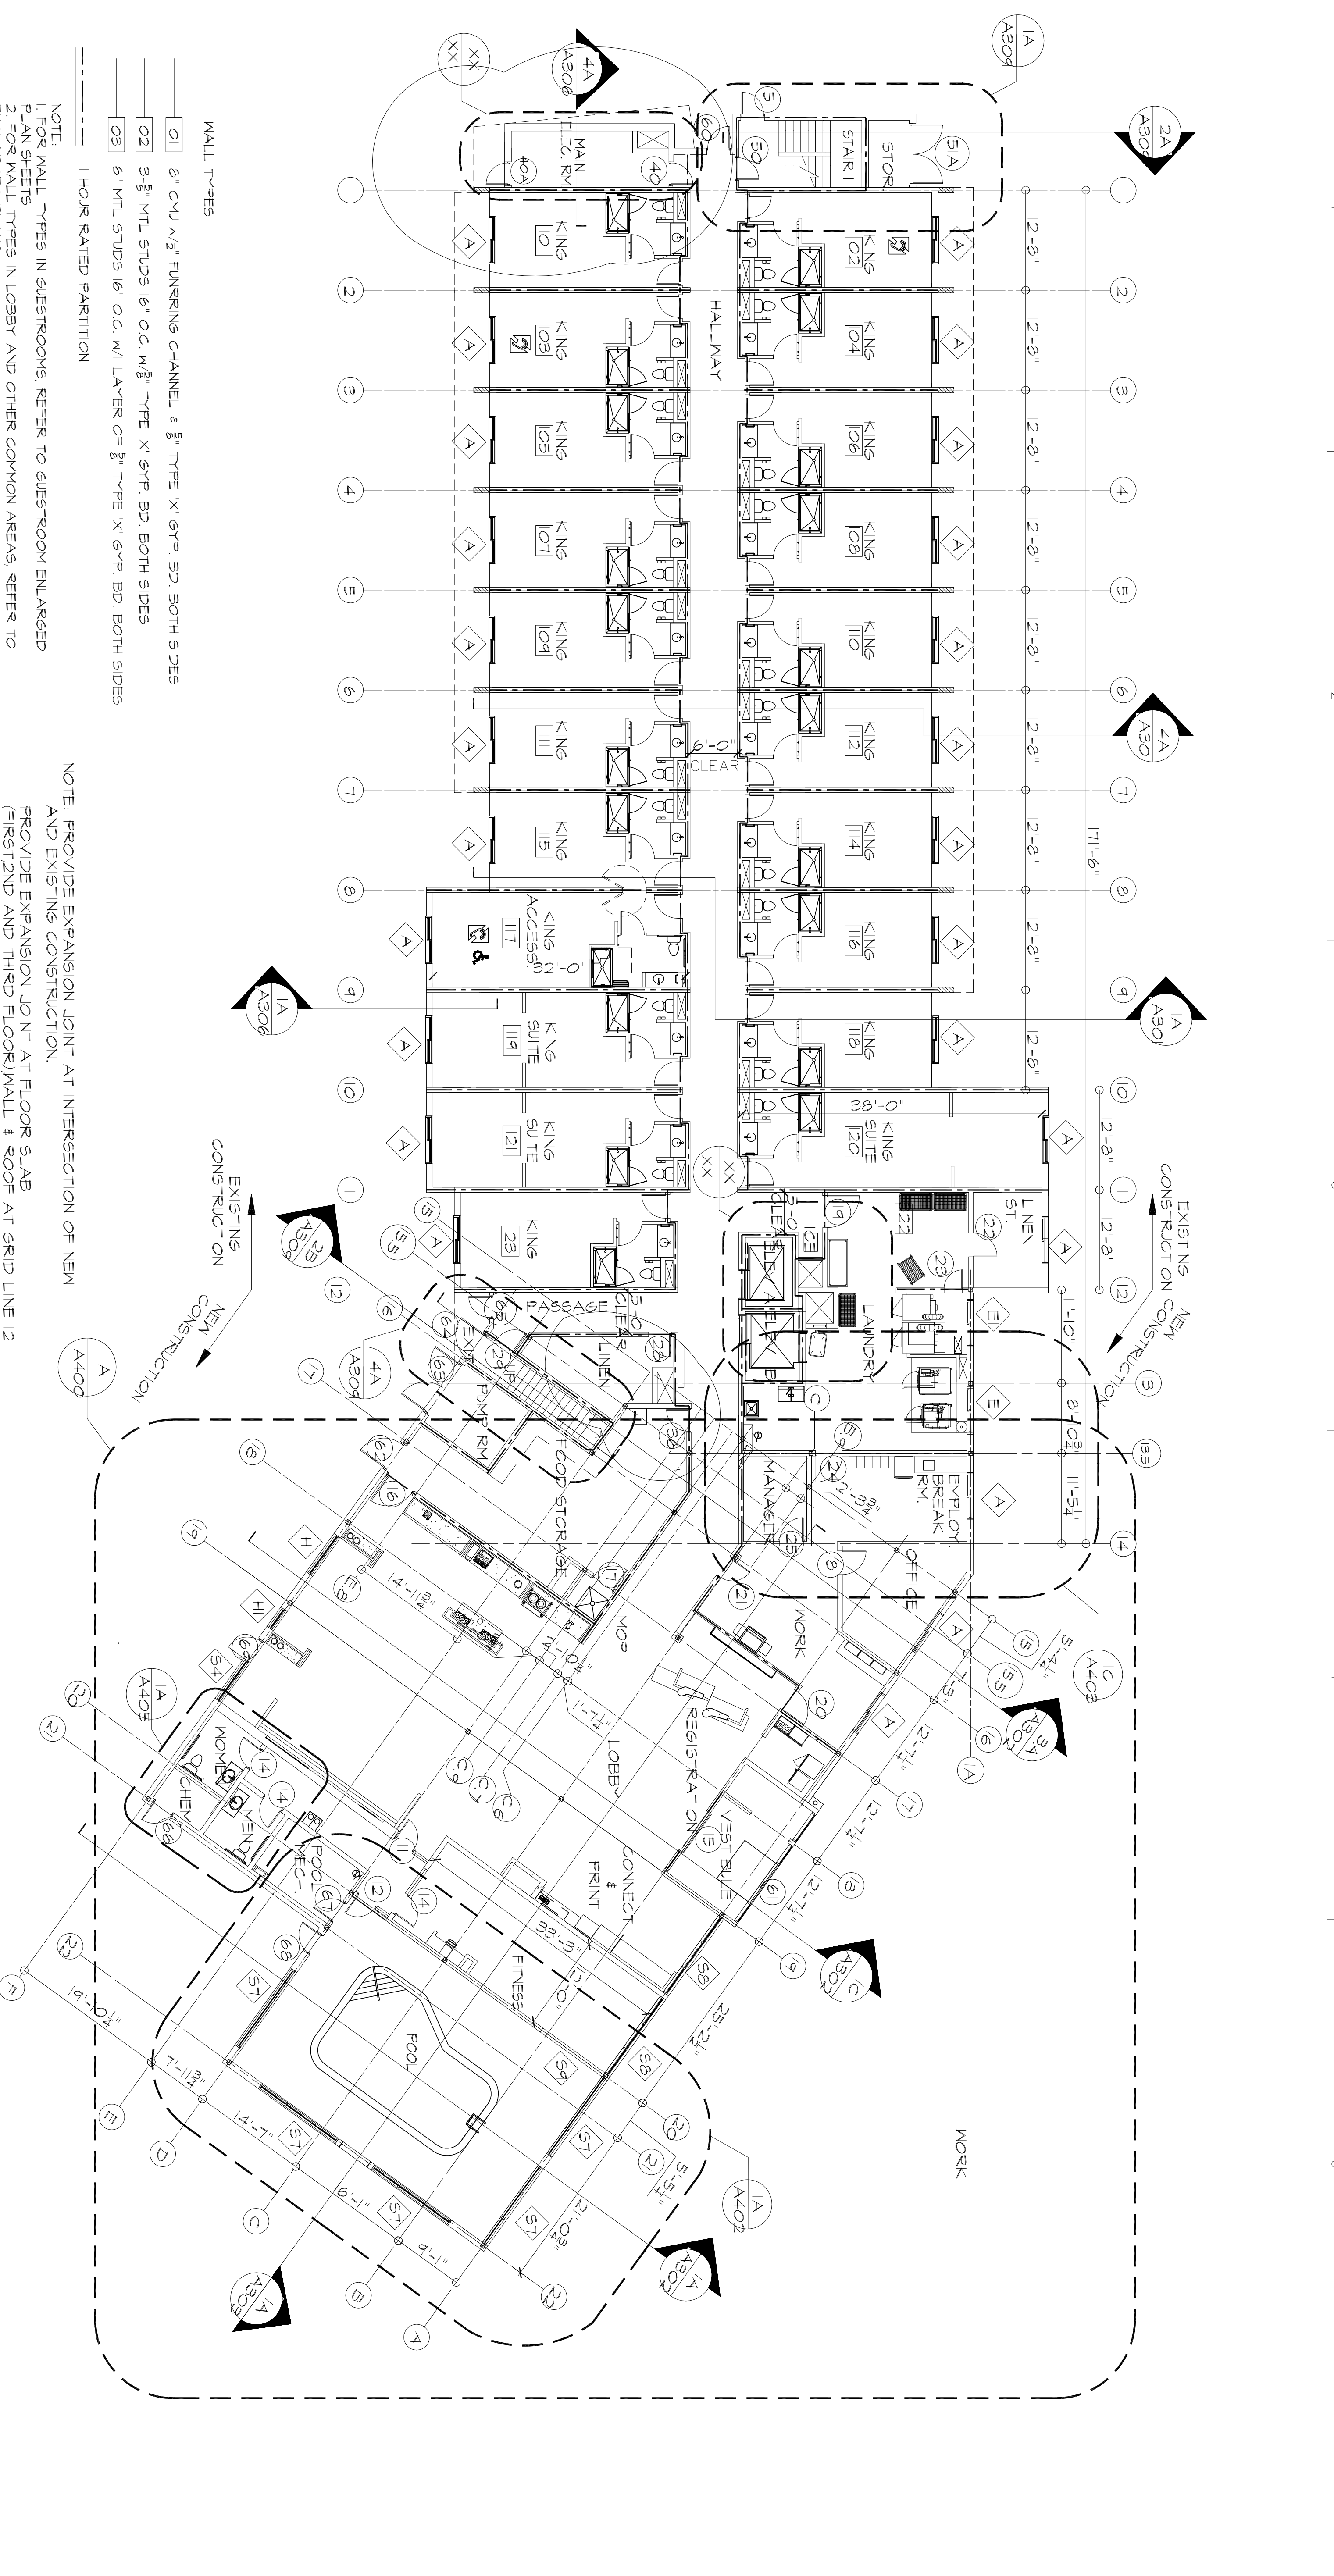

FLOOR	KING	KING ADA	Q/Q	Q/Q ADA	KING SUITE	KING SUITE ADA	TOTAL
01	16	01	01	01	04	04	21
02	04	01	16	01	01	04	26
03	04	01	18	01	07	01	30
03	24	01	34	02	15	01	77

**18 FIRST FLOOR PLAN**  
 SCALE 3/32"=1'-0"

- GENERAL NOTES**
- DO NOT SCALE DRAWINGS. USE GIVEN DIMENSIONS ONLY. IF NO DIMENSION GIVEN VERIFY CORRECT DIMENSION WITH ARCHITECT. GC SHALL VERIFY DIMENSIONS AT JOB SITE PRIOR TO CONSTRUCTION.
  - WORK SHALL COMPLY WITH APPLICABLE BUILDING CODES, AMENDED ORDINANCES, AND ALL OTHER APPLICABLE CODES AND REGULATIONS.
  - ALL MATERIALS FURNISHED UNDER THIS CONTRACT SHALL BE NEW UNLESS OTHERWISE NOTED.
  - THE GENERAL CONTRACTOR SHALL BE RESPONSIBLE FOR CHECKING WORK AND WORKING CONDITIONS AND SHALL VERIFY EXISTING CONDITIONS AT THE JOB SITE.
  - THE GENERAL CONTRACTOR AND EACH SUBCONTRACTOR SHALL BE RESPONSIBLE FOR CHECKING ALL DIMENSIONS AND CONDITIONS AT THE JOB SITE SHALL REPORT ANY DISCREPANCIES TO THE OWNER.

**14 GENERAL NOTES**  
 SCALE NTS

**24 GENERAL NOTES CONT.**  
 SCALE NTS

**34 GENERAL NOTES CONT.**  
 SCALE NTS

**18 FIRST FLOOR PLAN**  
 SCALE 3/32"=1'-0"

**GENERAL NOTES**

- THE CONTRACTOR SHALL BE RESPONSIBLE FOR DAILY CLEAN-UP OF ALL TRADES AND REMOVE ALL DEBRIS. AT THE COMPLETION OF THE PROJECT CONTRACTOR SHALL THOROUGHLY CLEAN THE CONSTRUCTION SITE AND ALL AREAS AFFECTED BY CONSTRUCTION.
- CONTRACTOR SHALL BE RESPONSIBLE FOR ADEQUATELY BRACING AND PROTECTING WORK DURING CONSTRUCTION AGAINST DAMAGE, BREAKAGE, COLLAPSE AND MISALIGNMENT.
- ALL DIMENSIONS ARE FROM FINISH SURFACE TO FINISH SURFACE.

**14 GENERAL NOTES**  
 SCALE NTS

**GENERAL NOTES**

- DO NOT SCALE DRAWINGS. USE GIVEN DIMENSIONS ONLY. IF NO DIMENSION GIVEN VERIFY CORRECT DIMENSION WITH ARCHITECT. GC SHALL VERIFY DIMENSIONS AT JOB SITE PRIOR TO CONSTRUCTION.
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**24 GENERAL NOTES CONT.**  
 SCALE NTS


**GENERAL NOTES CONT.**

- CONTRACTOR SHALL BE RESPONSIBLE FOR ADEQUATELY BRACING AND PROTECTING WORK DURING CONSTRUCTION AGAINST DAMAGE, BREAKAGE, COLLAPSE AND MISALIGNMENT.
- ALL DIMENSIONS ARE FROM FINISH SURFACE TO FINISH SURFACE.

**34 GENERAL NOTES CONT.**  
 SCALE NTS

**GENERAL NOTES CONT.**

- CONTRACTOR SHALL BE RESPONSIBLE FOR ADEQUATELY BRACING AND PROTECTING WORK DURING CONSTRUCTION AGAINST DAMAGE, BREAKAGE, COLLAPSE AND MISALIGNMENT.
- ALL DIMENSIONS ARE FROM FINISH SURFACE TO FINISH SURFACE.

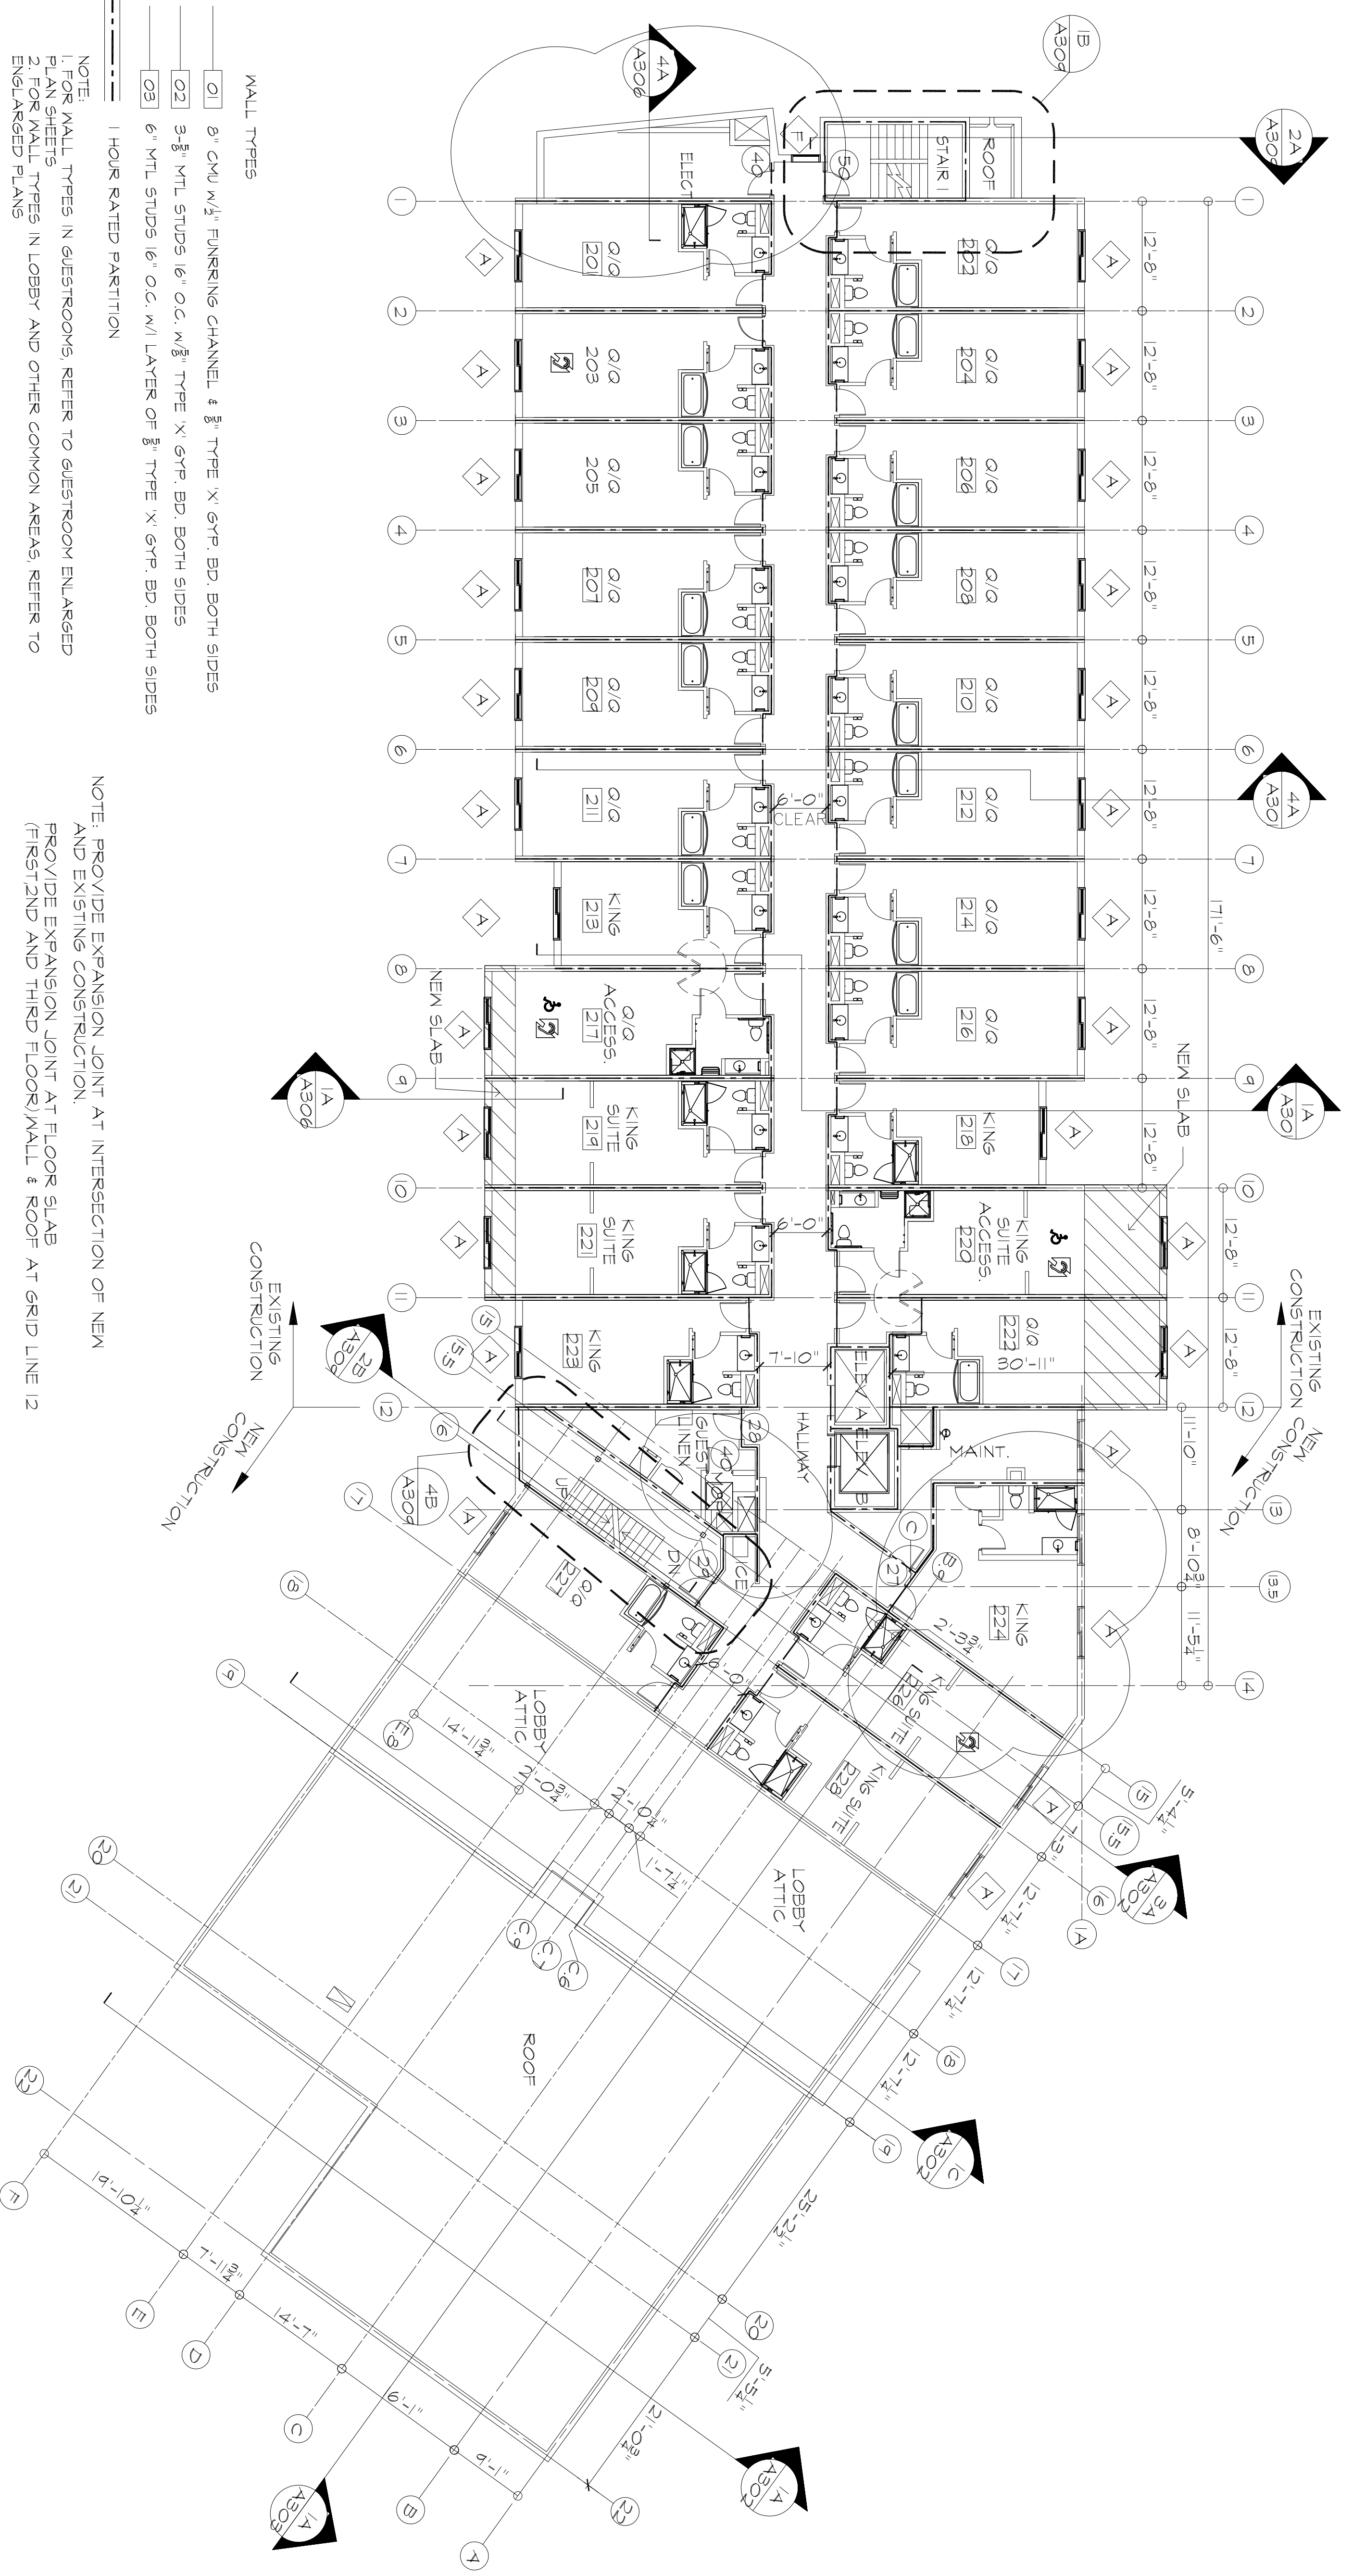

**1B SECOND FLOOR PLAN**  
SCALE 3/32"=1'-0"





**WALL TYPES**

- 01 6" CMU W/ 1/2" FLANKING CHANNEL, 4 3/8" TYPE 'X' GYP. BD. BOTH SIDES
- 02 3-3/8" MTL STUDS 16" O.C. W/ 3/8" TYPE 'X' GYP. BD. BOTH SIDES
- 03 6" MTL STUDS 16" O.C. W/ 1 LAYER OF 3/8" TYPE 'X' GYP. BD. BOTH SIDES

----- 1 HOUR RATED PARTITION

**NOTE:**  
1. FOR WALL TYPES IN GUESTROOMS, REFER TO GUESTROOM ENLARGED PLAN SHEETS  
2. FOR WALL TYPES IN LOBBY AND OTHER COMMON AREAS, REFER TO ENLARGED PLANS

**NOTE:** PROVIDE EXPANSION JOINT AT INTERSECTION OF NEW AND EXISTING CONSTRUCTION.  
PROVIDE EXPANSION JOINT AT FLOOR SLAB (FIRST AND THIRD FLOOR)/WALL & ROOF AT GRID LINE 12

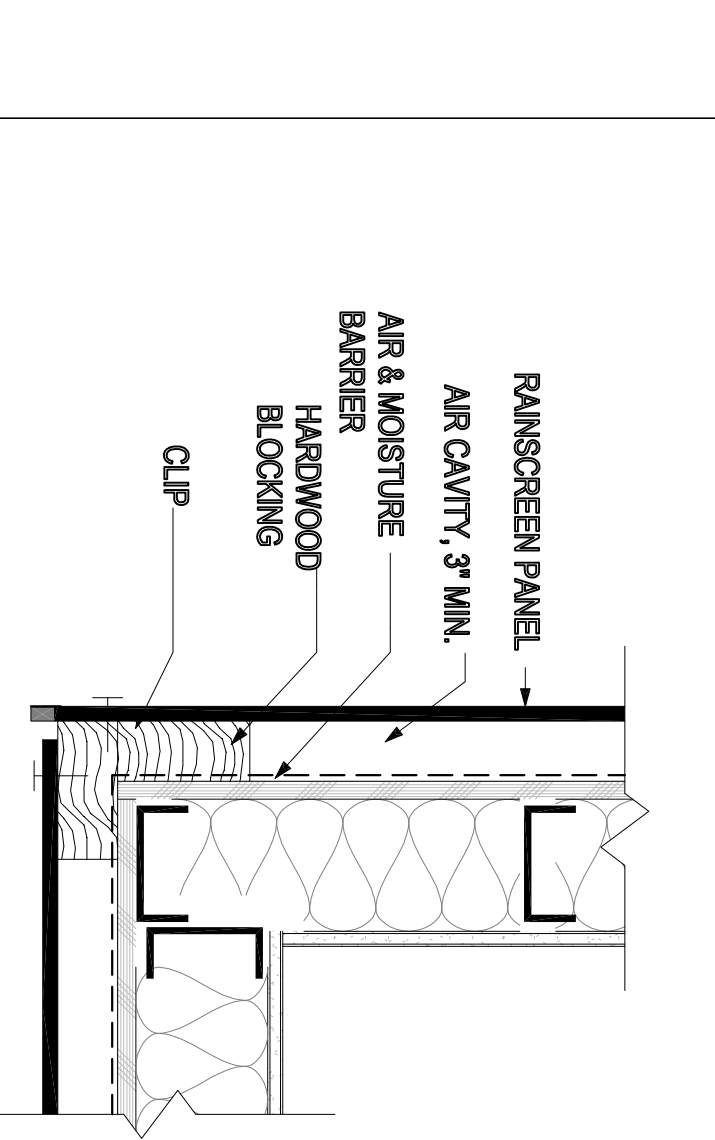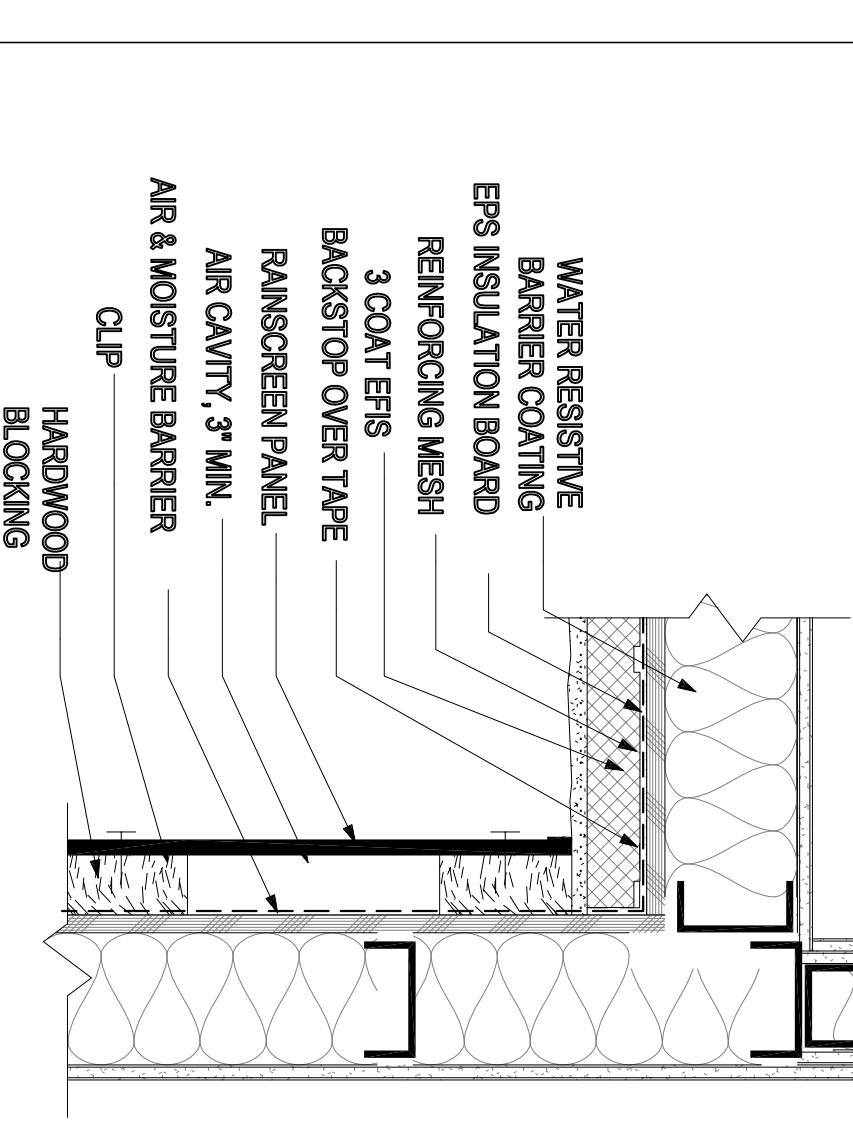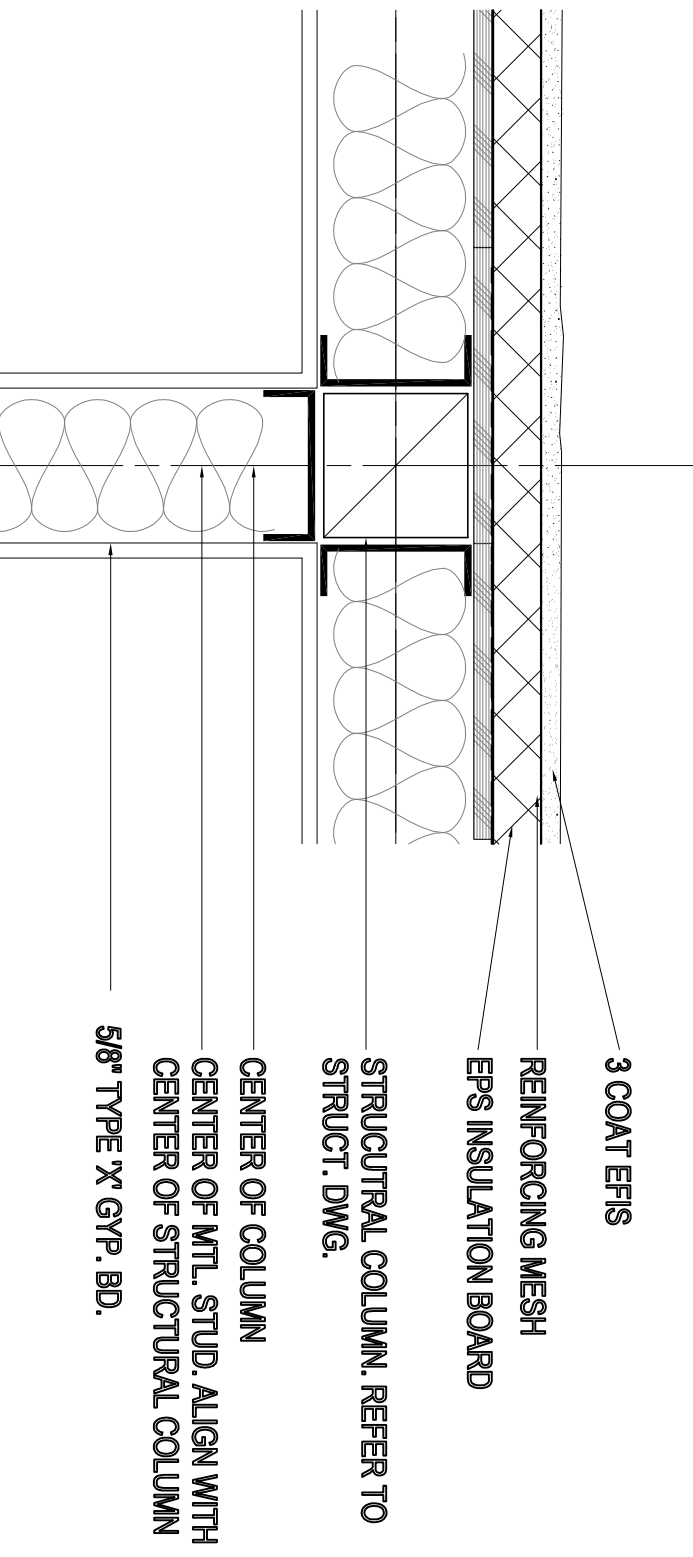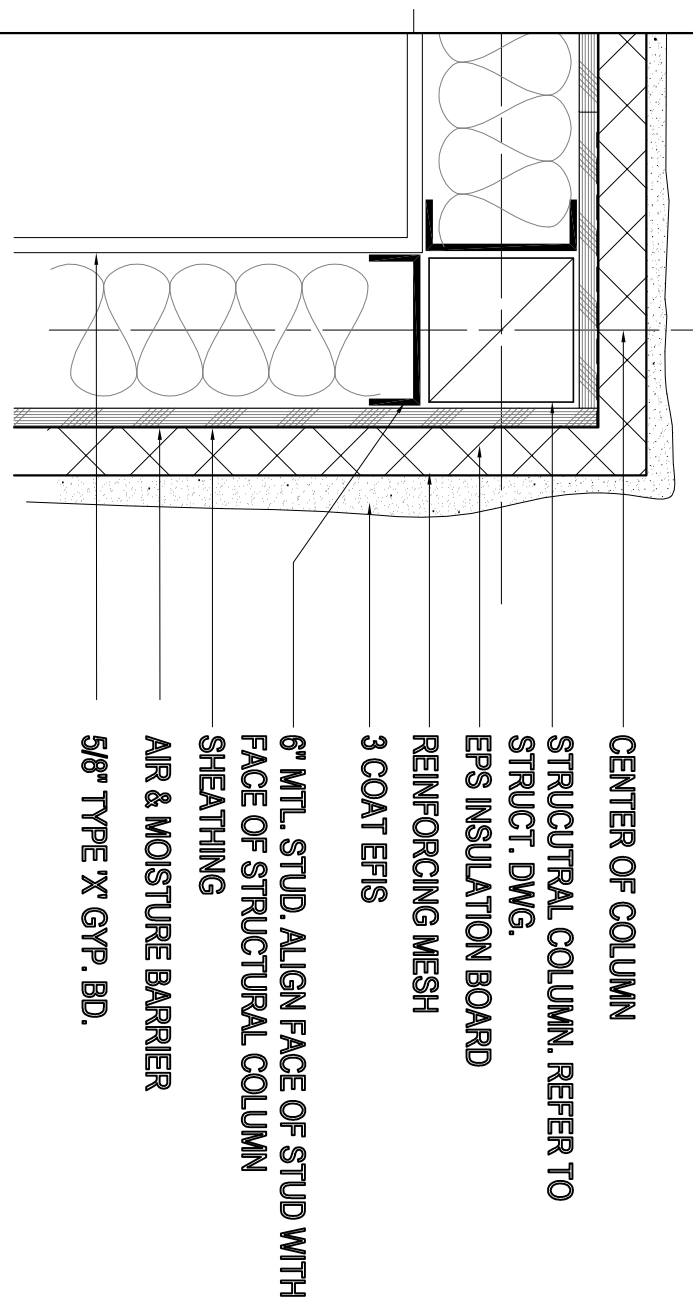

**1A STEEL COLUMN @ EXTERIOR WALL**  
SCALE 1 1/2"=1'-0"

**2A STEEL COLUMN @ EXTERIOR WALL**  
SCALE 1 1/2"=1'-0"

**3A RAINSCREEN & EIFS**  
SCALE 1 1/2"=1'-0"

**4A CORNER @ RAINSCREEN**  
SCALE 1 1/2"=1'-0"

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BY  
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BATESVILLE, MS 38606

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**CONSTRUCTION**

**ISSUES & REVISIONS**

NO.	DATE	DESCRIPTION
1	06/21/16	50% REVIEW SET
2	11/22/16	90% REVIEW SET
3	12/22/16	100% REVIEW SET

**PROJECT NUMBER:** 16180  
**DRAWING NAME:** SECOND FLOOR PLAN

**PROJECT NAME:** FAIRFIELD INN & SUITES  
**CHECKED BY:** BBC  
**DATE:** 12-22-16  
**SCALE:** AS NOTED

**DRAWING NUMBER:** A101

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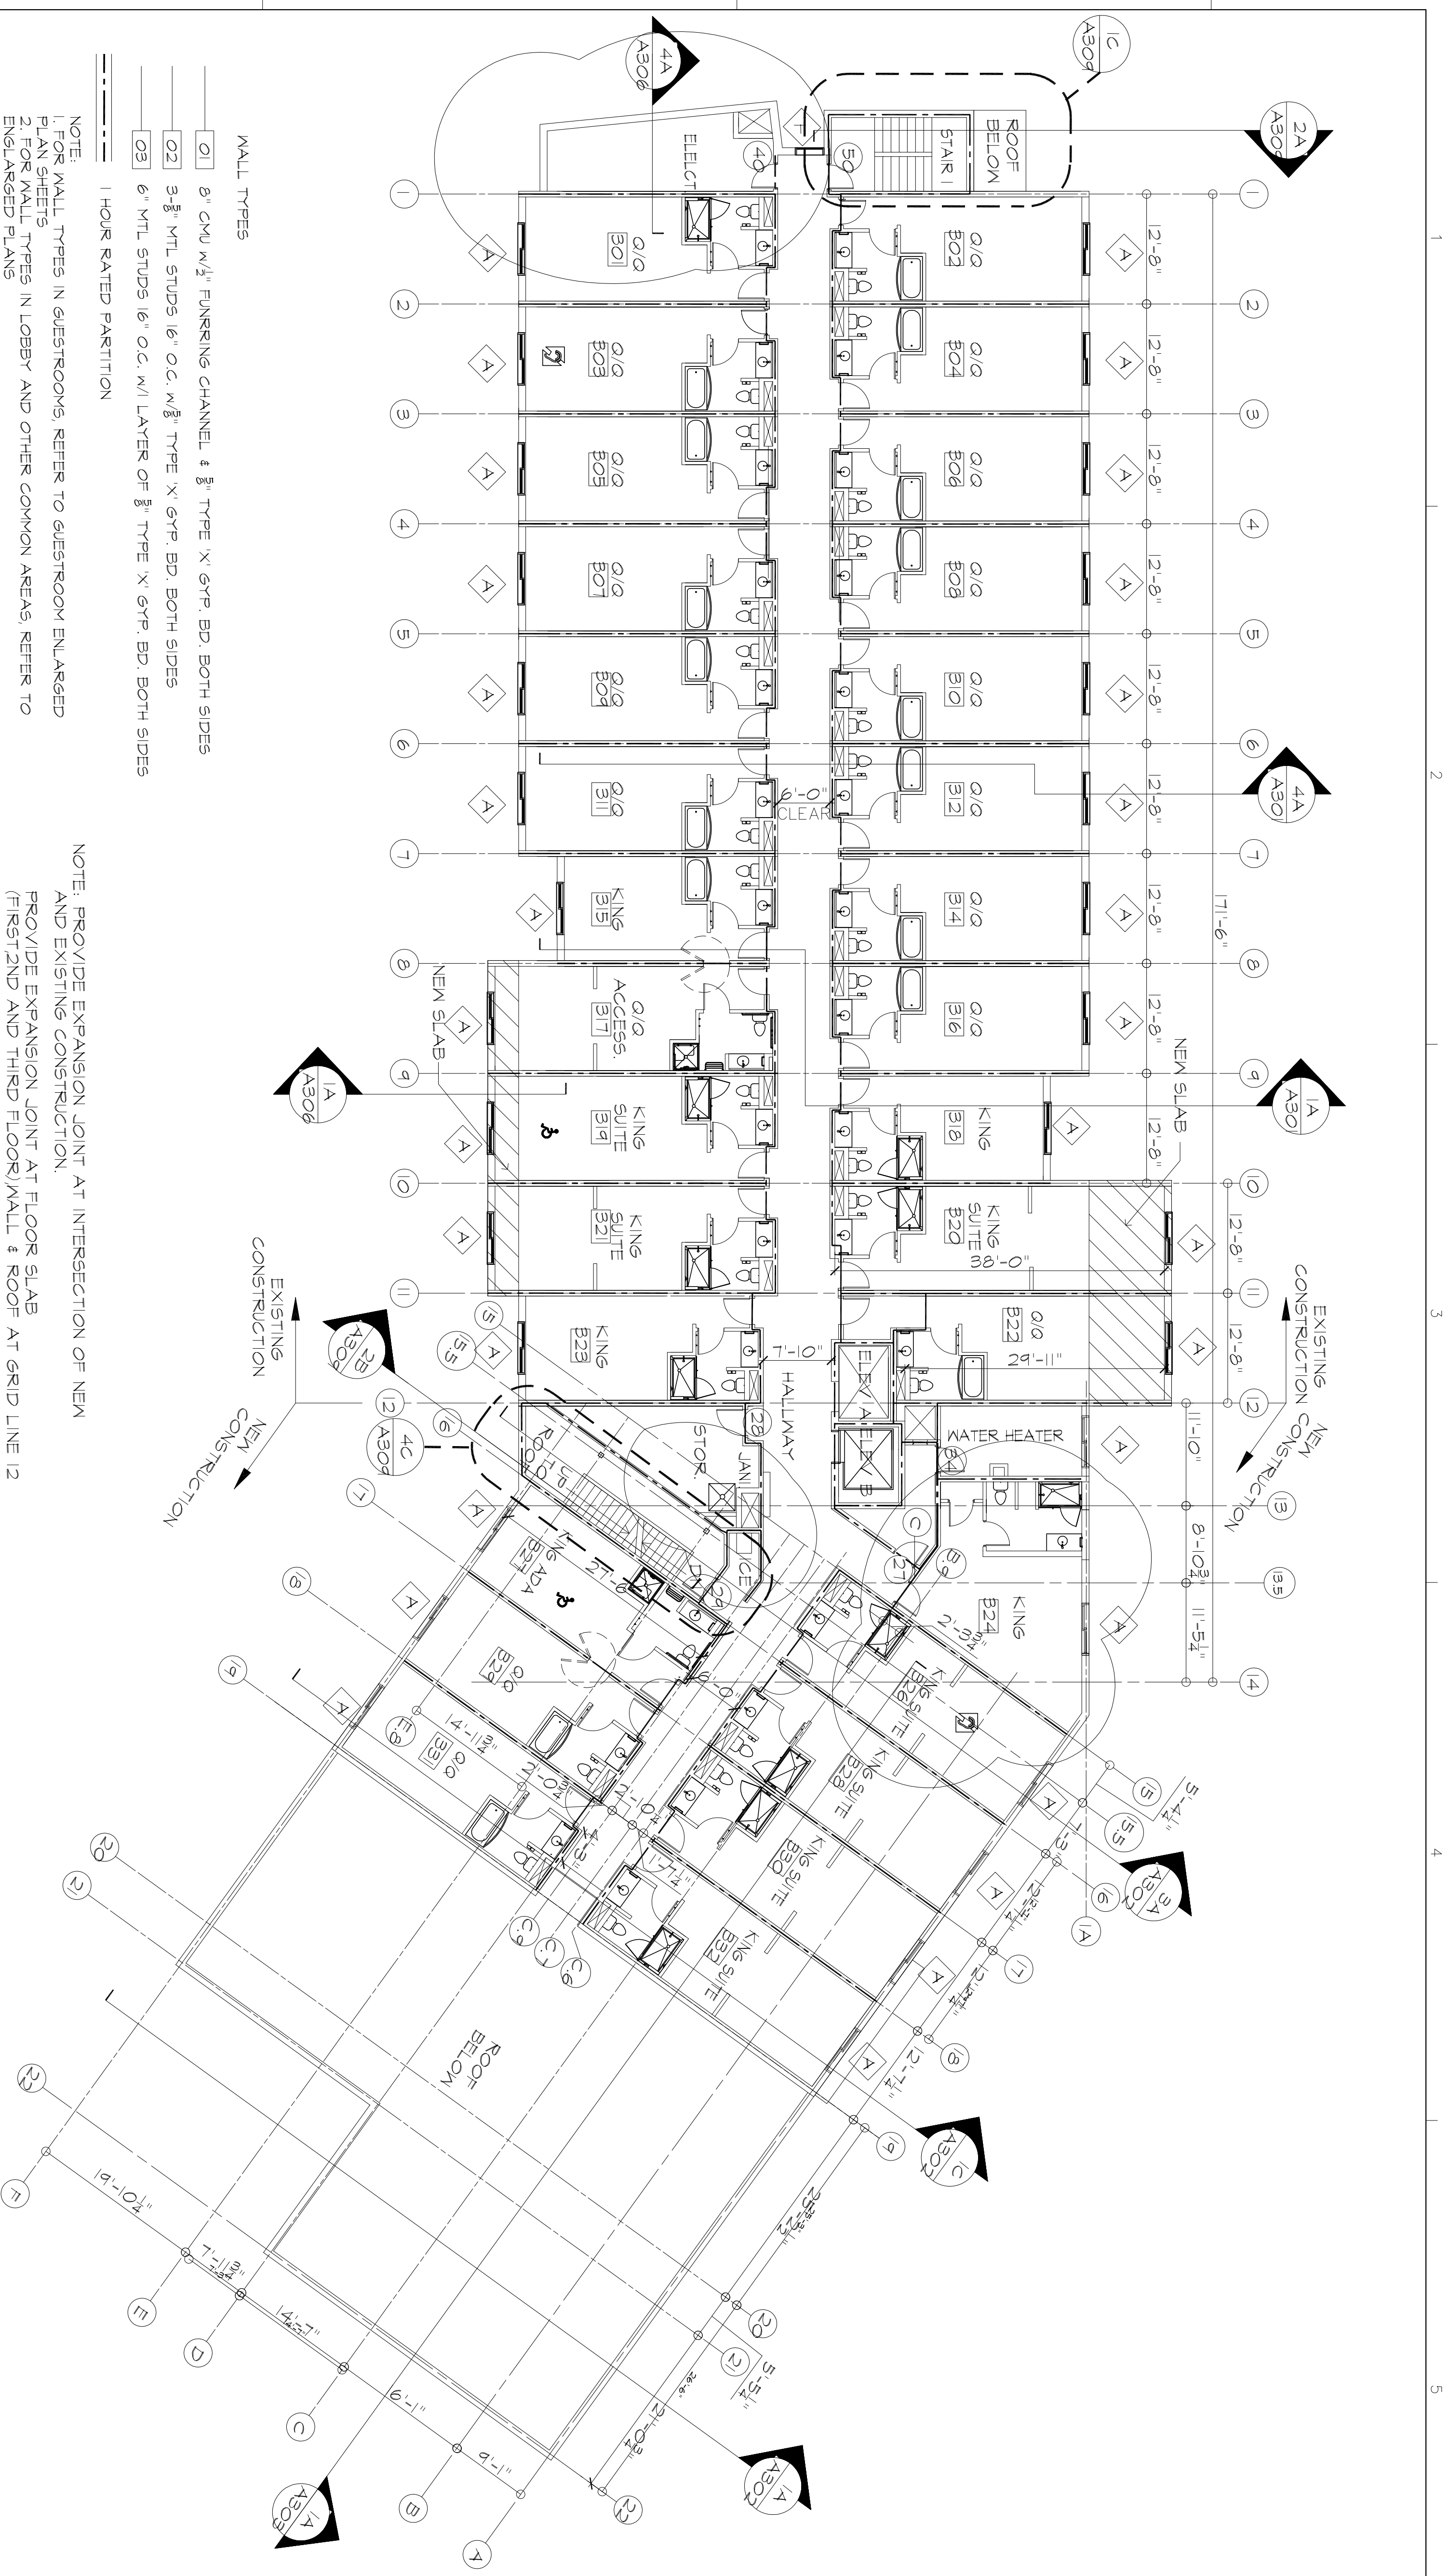
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NO.	DATE	DESCRIPTION
1	06/12/16	50% REVIEW SET
2	11/22/16	60% REVIEW SET
3	12/22/16	100% REVIEW SET

PROJECT NUMBER: 16180  
 DRAWING NAME:  
 SHEET NAME:  
**THIRD FLOOR PLAN**

DRAWN BY: BKC  
 CHECKED BY: BBC  
 DATE: 12-22-16  
 SCALE: AS NOTED  
 DRAWING NUMBER:  
**A102**



**18 THIRD FLOOR PLAN**  
 SCALE 3/8"=1'-0"

**MALL TYPES**

- 01 6" CHU W/1/2" FUNKING CHANNEL, 3/8" TYPE 'X' GYP. BD. BOTH SIDES
- 02 3-3/8" MTL STUDS 16" O.C. W/1/2" TYPE 'X' GYP. BD. BOTH SIDES
- 03 6" MTL STUDS 16" O.C. W/1 LAYER OF 5/8" TYPE 'X' GYP. BD. BOTH SIDES

1 HOUR RATED PARTITION

NOTE:  
 1. FOR MALL TYPES IN GUESTROOMS, REFER TO GUESTROOM ENLARGED PLAN SHEETS  
 2. FOR MALL TYPES IN LOBBY AND OTHER COMMON AREAS, REFER TO ENLARGED PLANS

NOTE: PROVIDE EXPANSION JOINT AT INTERSECTION OF NEW AND EXISTING CONSTRUCTION.  
 PROVIDE EXPANSION JOINT AT FLOOR SLAB (FIRST, SECOND AND THIRD FLOOR), MALL & ROOF AT GRID LINE 12

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2	11/22/2015	90% REVIEW SET
3	12/22/2015	100% REVIEW SET

PROJECT NAME:

PROJECT NUMBER: 15180

DRAWING NAME:

SHEET NAME:


ROOF PLAN

DRAWN BY: BJC  
CHECKED BY: BJC

DATE: 12-22-15  
SCALE: AS NOTED

DRAWING NUMBER

**A102A**

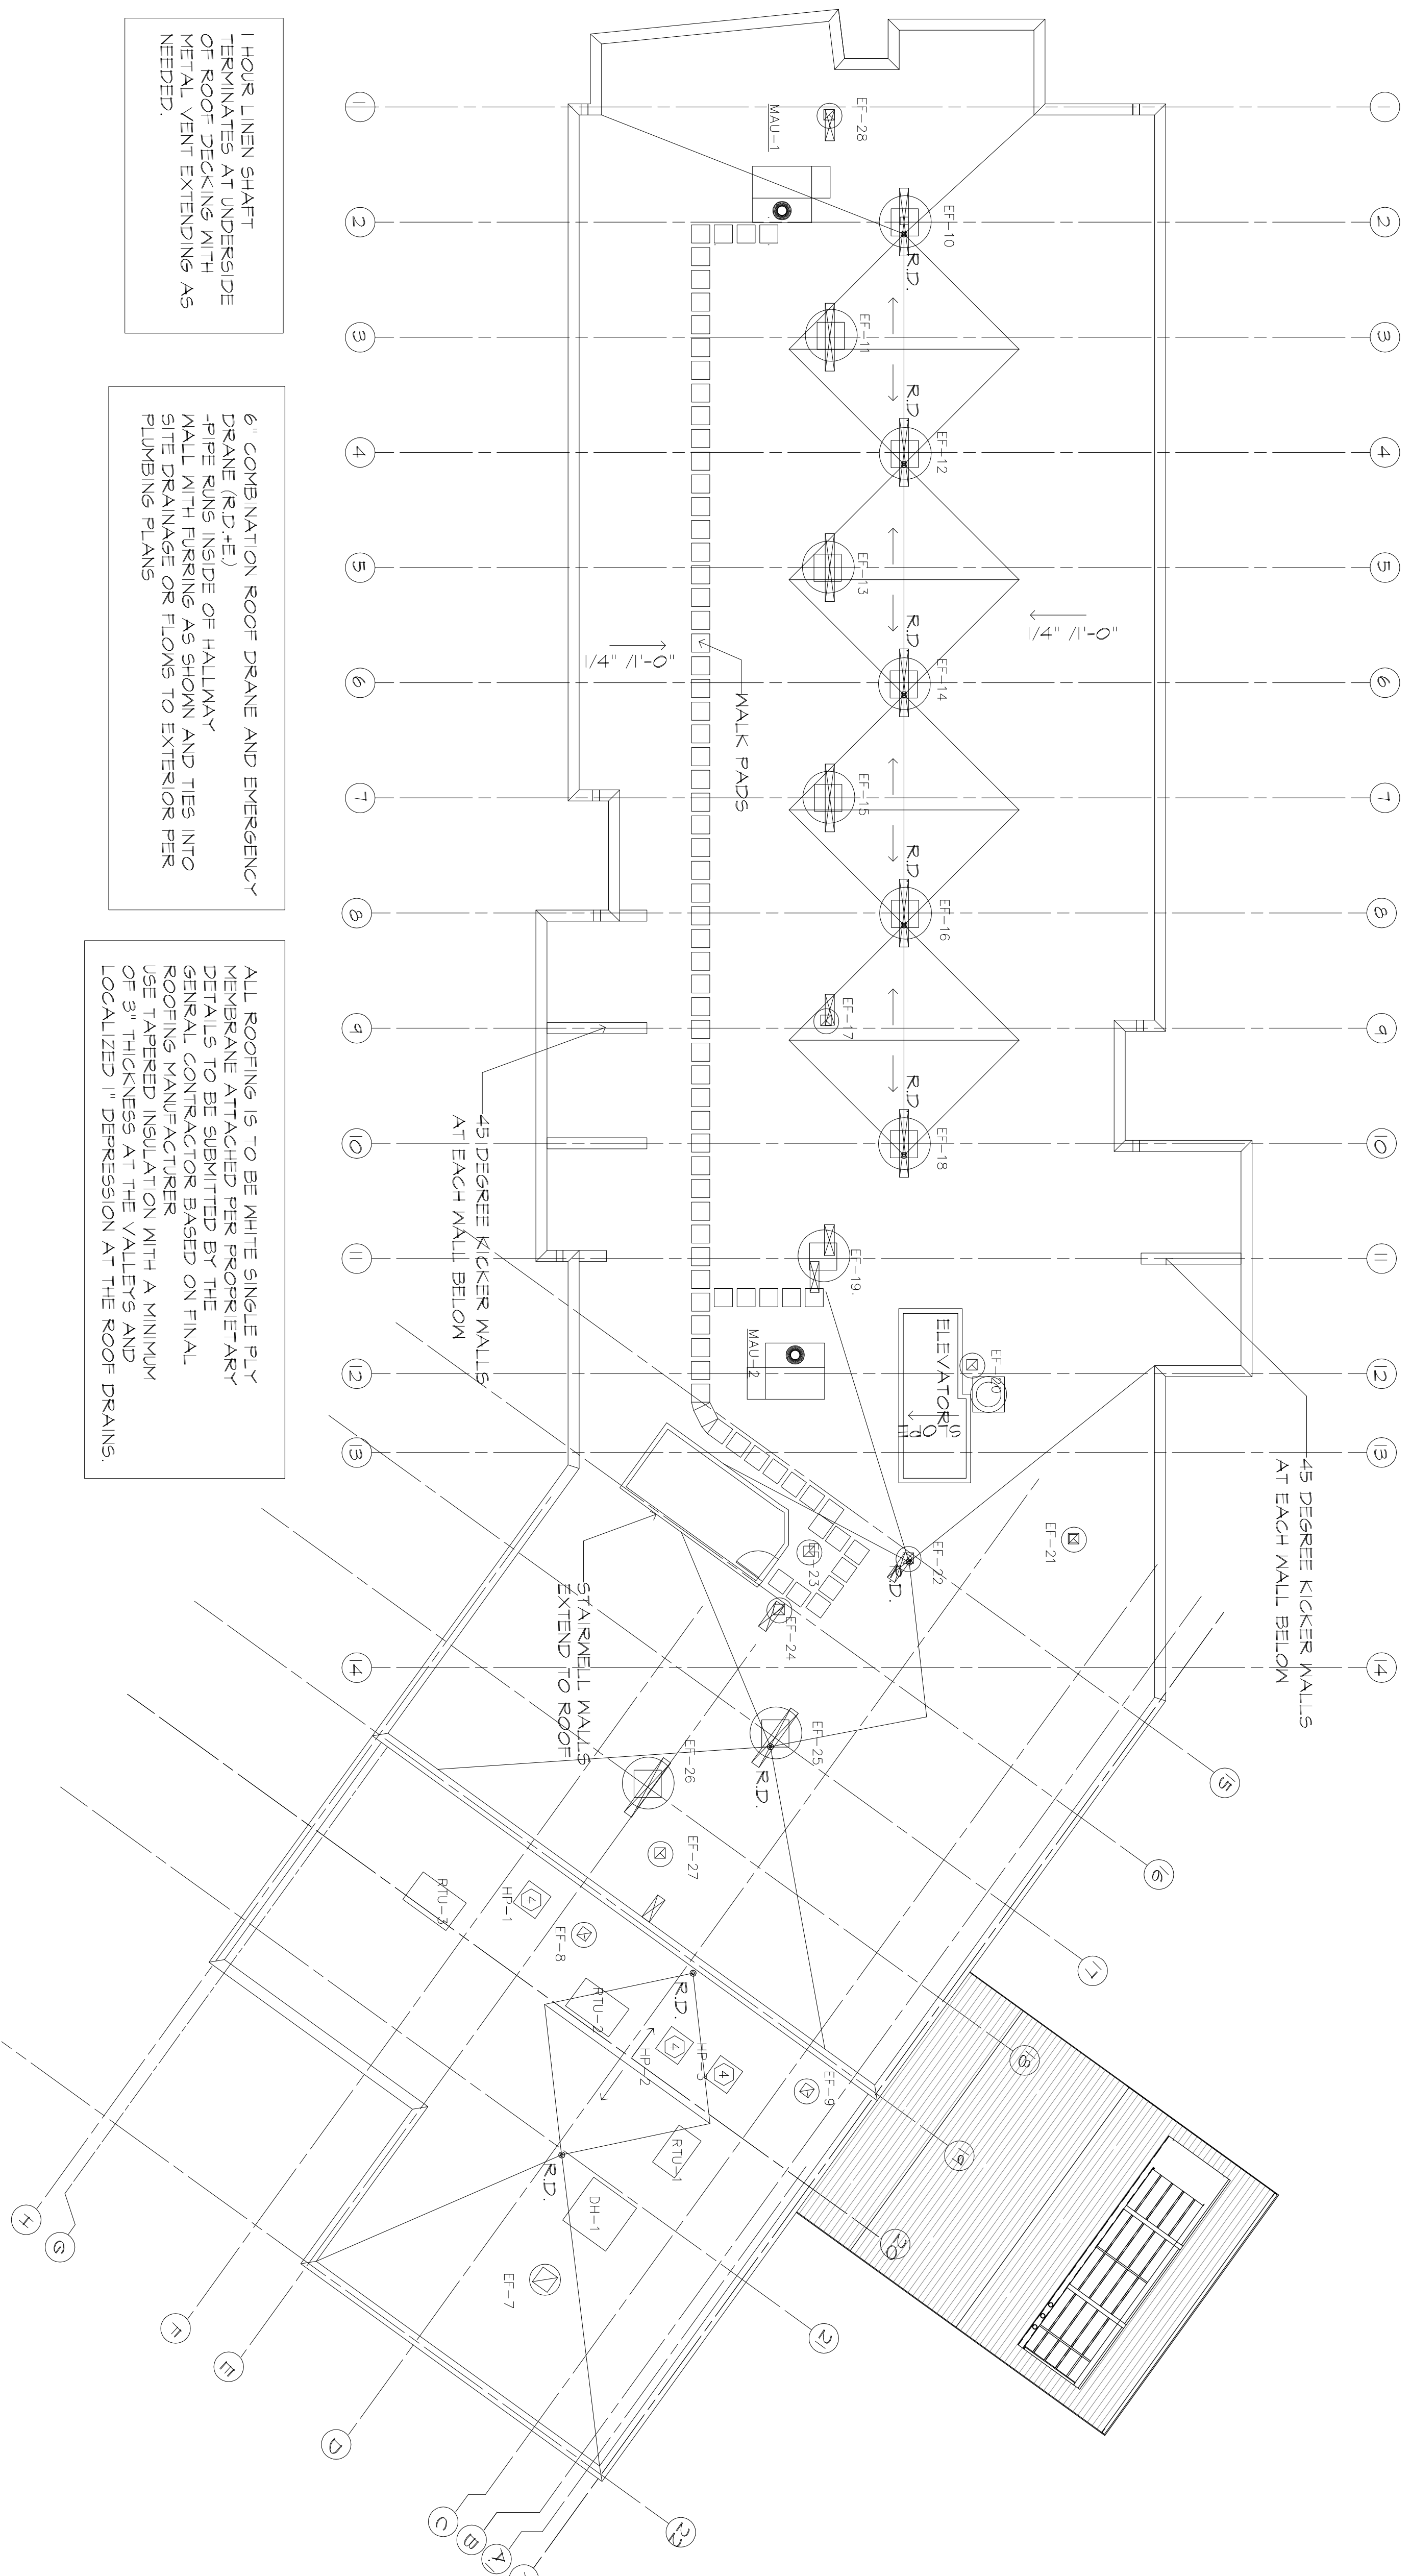

1 HOUR LINEN SHAFT  
TERMINATES AT UNDERSIDE  
OF ROOF DECKING WITH  
METAL VENT EXTENDING AS  
NEEDED.

6" COVENATION ROOF DRAPE AND EMERGENCY  
DRAPE (RD +E)  
-PIPE RUNS INSIDE OF HALLWAY  
WALL WITH TURNING AS SHOWN AND TIES INTO  
SITE DRAINAGE OR FLOWS TO EXTERIOR PER  
PLUMBING PLANS

ALL ROOFING IS TO BE WHITE SINGLE PLY  
MEMBRANE ATTACHED PER PROPRIETARY  
DETAILS TO BE SUBMITTED BY THE  
GENERAL CONTRACTOR BASED ON FINAL  
ROOFING MANUFACTURER  
USE TAPERED INSULATION WITH A MINIMUM  
OF 3" THICKNESS AT THE VALLEYS AND  
LOCALIZED 1" DEPRESSION AT THE ROOF DRAINS.

**1B**  
**ROOF PLAN**  
SCALE 3/8"=1'-0"

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1	06/27/2015	30% REVIEW SET
2	11/22/2015	50% REVIEW SET
3	12/22/2015	100% REVIEW SET

PROJECT NUMBER: 15180

DRAWING NAME:

SHEET NAME:

RCP, FIRST FLOOR

DRAWN BY: BKC


CHECKED BY: BKC

DATE: 12-22-15

SCALE: AS NOTED

DRAWING NUMBER

**A103**

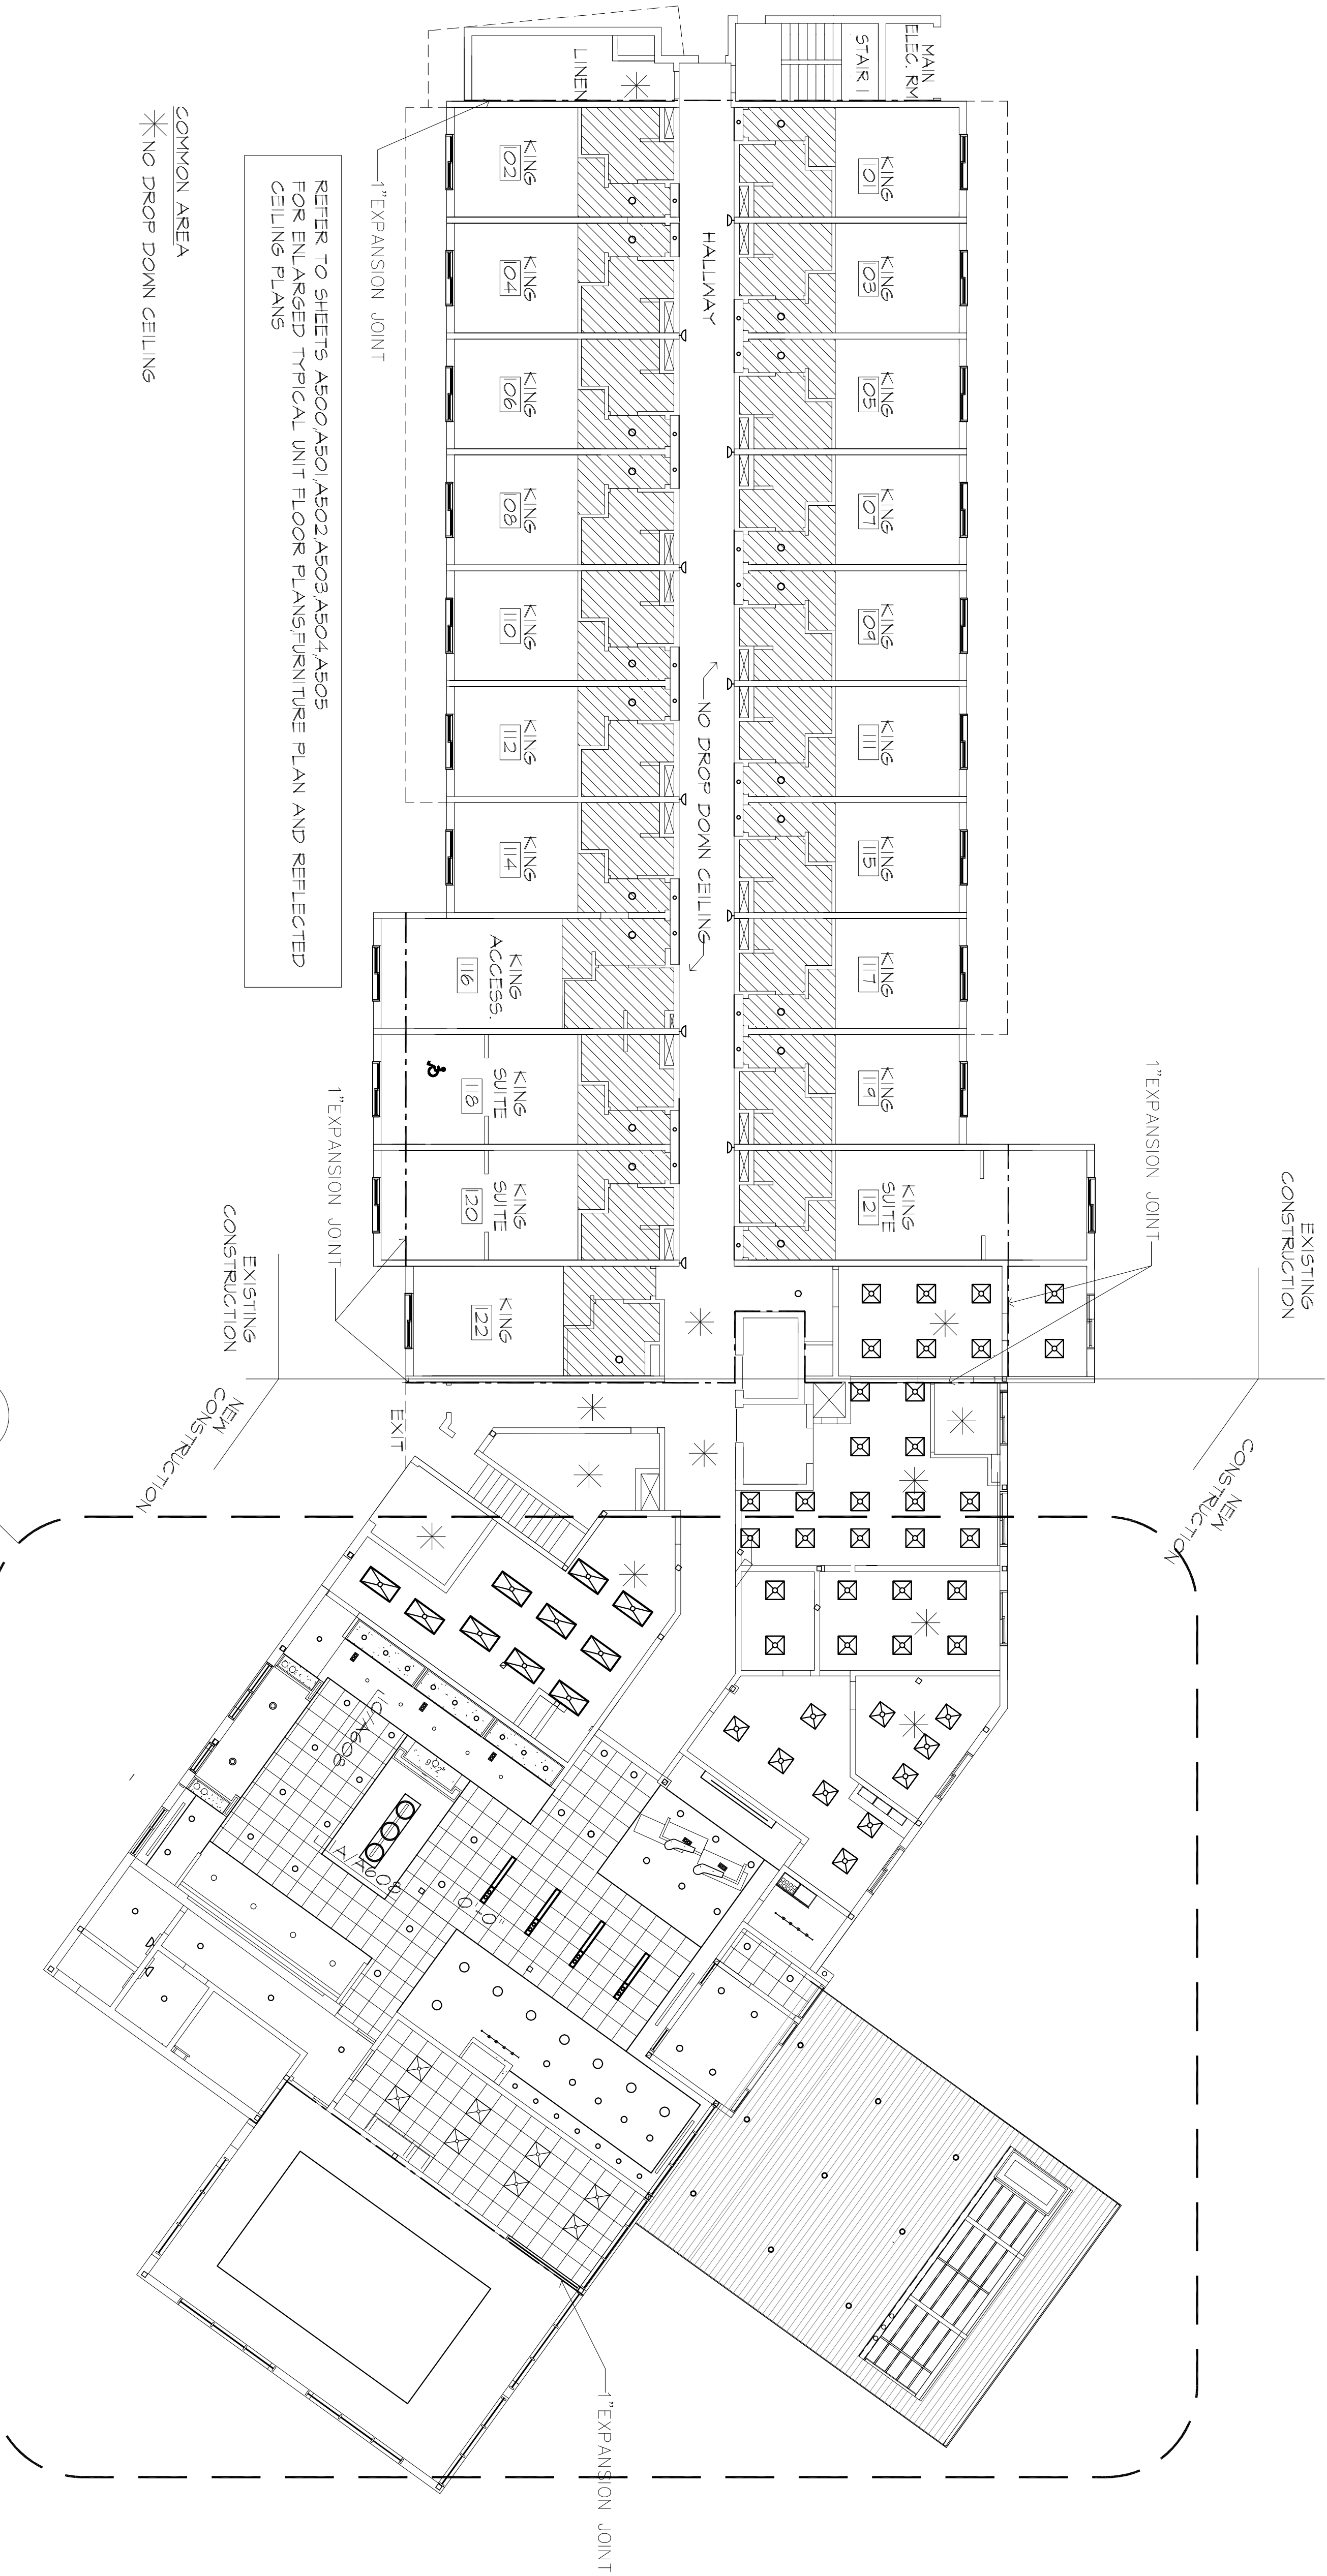

**1C FIRST FLOOR REFLECTED CEILING PLAN**  
 SCALE 3/32"=1'-0"

**SYMBOLS LEGEND**

ELECTRICAL SYMBOLS

- SURFACE AND FLUORESCENT LIGHT FIXTURE
- RECESSED 2x2 LIGHT FIXTURE
- RECESSED 2x4 LIGHT FIXTURE
- RECESSED DIRECT / INDIRECT FLUORESCENT
- WALL MOUNT
- RECESSED
- WALL SCONCE
- PENDANT LIGHT - SEE PLANS FOR SIZE
- TRACK W/ ADJUSTABLE TRACK HEADS
- LED / FLUORESCENT STRIP LIGHT
- HVAC DIFFUSER
- RETURN AIR GRILL
- LINEAR DIFFUSER
- EXIT LIGHT



SYMBOLS LEGEND	
ELECTRICAL SYMBOLS	
	SURFACE AND FLUORESCENT LIGHT FIXTURE
	RECESSED 2x2 LIGHT FIXTURE
	RECESSED 2x4 LIGHT FIXTURE
	RECESSED DIRECT/INDIRECT FLUORESCENT
	WALL MOUNT
	RECESSED
	WALL SCONCE
	PENDANT LIGHT - SEE PLANS FOR SIZE
	TRACK W/ADJUSTABLE FLUORESCENT
	TRACK HEADS
	LED FLUORESCENT STRIP LIGHT
	HVAC DIFFUSER
	RETURN AIR GRILL
	LINEAR DIFFUSER
	EXIT LIGHT

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1	08/20/15	30% REVIEW SET
2	11/22/2015	50% REVIEW SET
3	12/22/2015	100% REVIEW SET

PROJECT NAME:  
 PROJECT NUMBER: 15180  
 DRAWING NAME:  
 SHEET NAME  
 RCP- FIRST FLOOR

DRAWN BY: NK, BBC  
 CHECKED BY: BBC  
 DATE: 12-22-15  
 SCALE: AS NOTED  
 DRAWING NUMBER  
**A103A**

1A  
 LOBBY RCP  
 SCALE 3/16" = 1'-0"



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2	11/22/2015	50% REVIEW SET
3	12/22/2015	100% REVIEW SET

PROJECT NAME:

PROJECT NUMBER: 15180

DRAWING NAME:

SHEET NAME

RCP - SECOND FLOOR

DRAWN BY: NK, BBC

CHECKED BY: BBC

DATE: 12-22-15

SCALE: AS NOTED

DRAWING NUMBER

**A104**



REFER TO SHEETS A500A, A501, A502, A503, A504, A505  
 FOR ENLARGED TYPICAL UNIT FLOOR PLANS, FURNITURE PLAN AND REFLECTED  
 CEILING PLANS

**1c SECOND FLOOR REFLECTED CEILING PLAN**  
 SCALE 3/32" = 1'-0"




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1	08/07/2014	CODE SUBMITTAL


PROJECT NAME:

PROJECT NUMBER:  
DRAWING NAME:  
SHEET NAME

RCP- THIRD FLOOR


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CHECKED BY: BBC/NK  
DATE: 7-30-14  
SCALE: AS NOTED  
DRAWING NUMBER

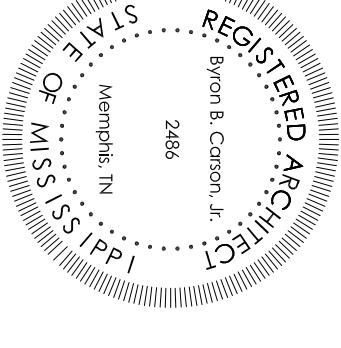A105

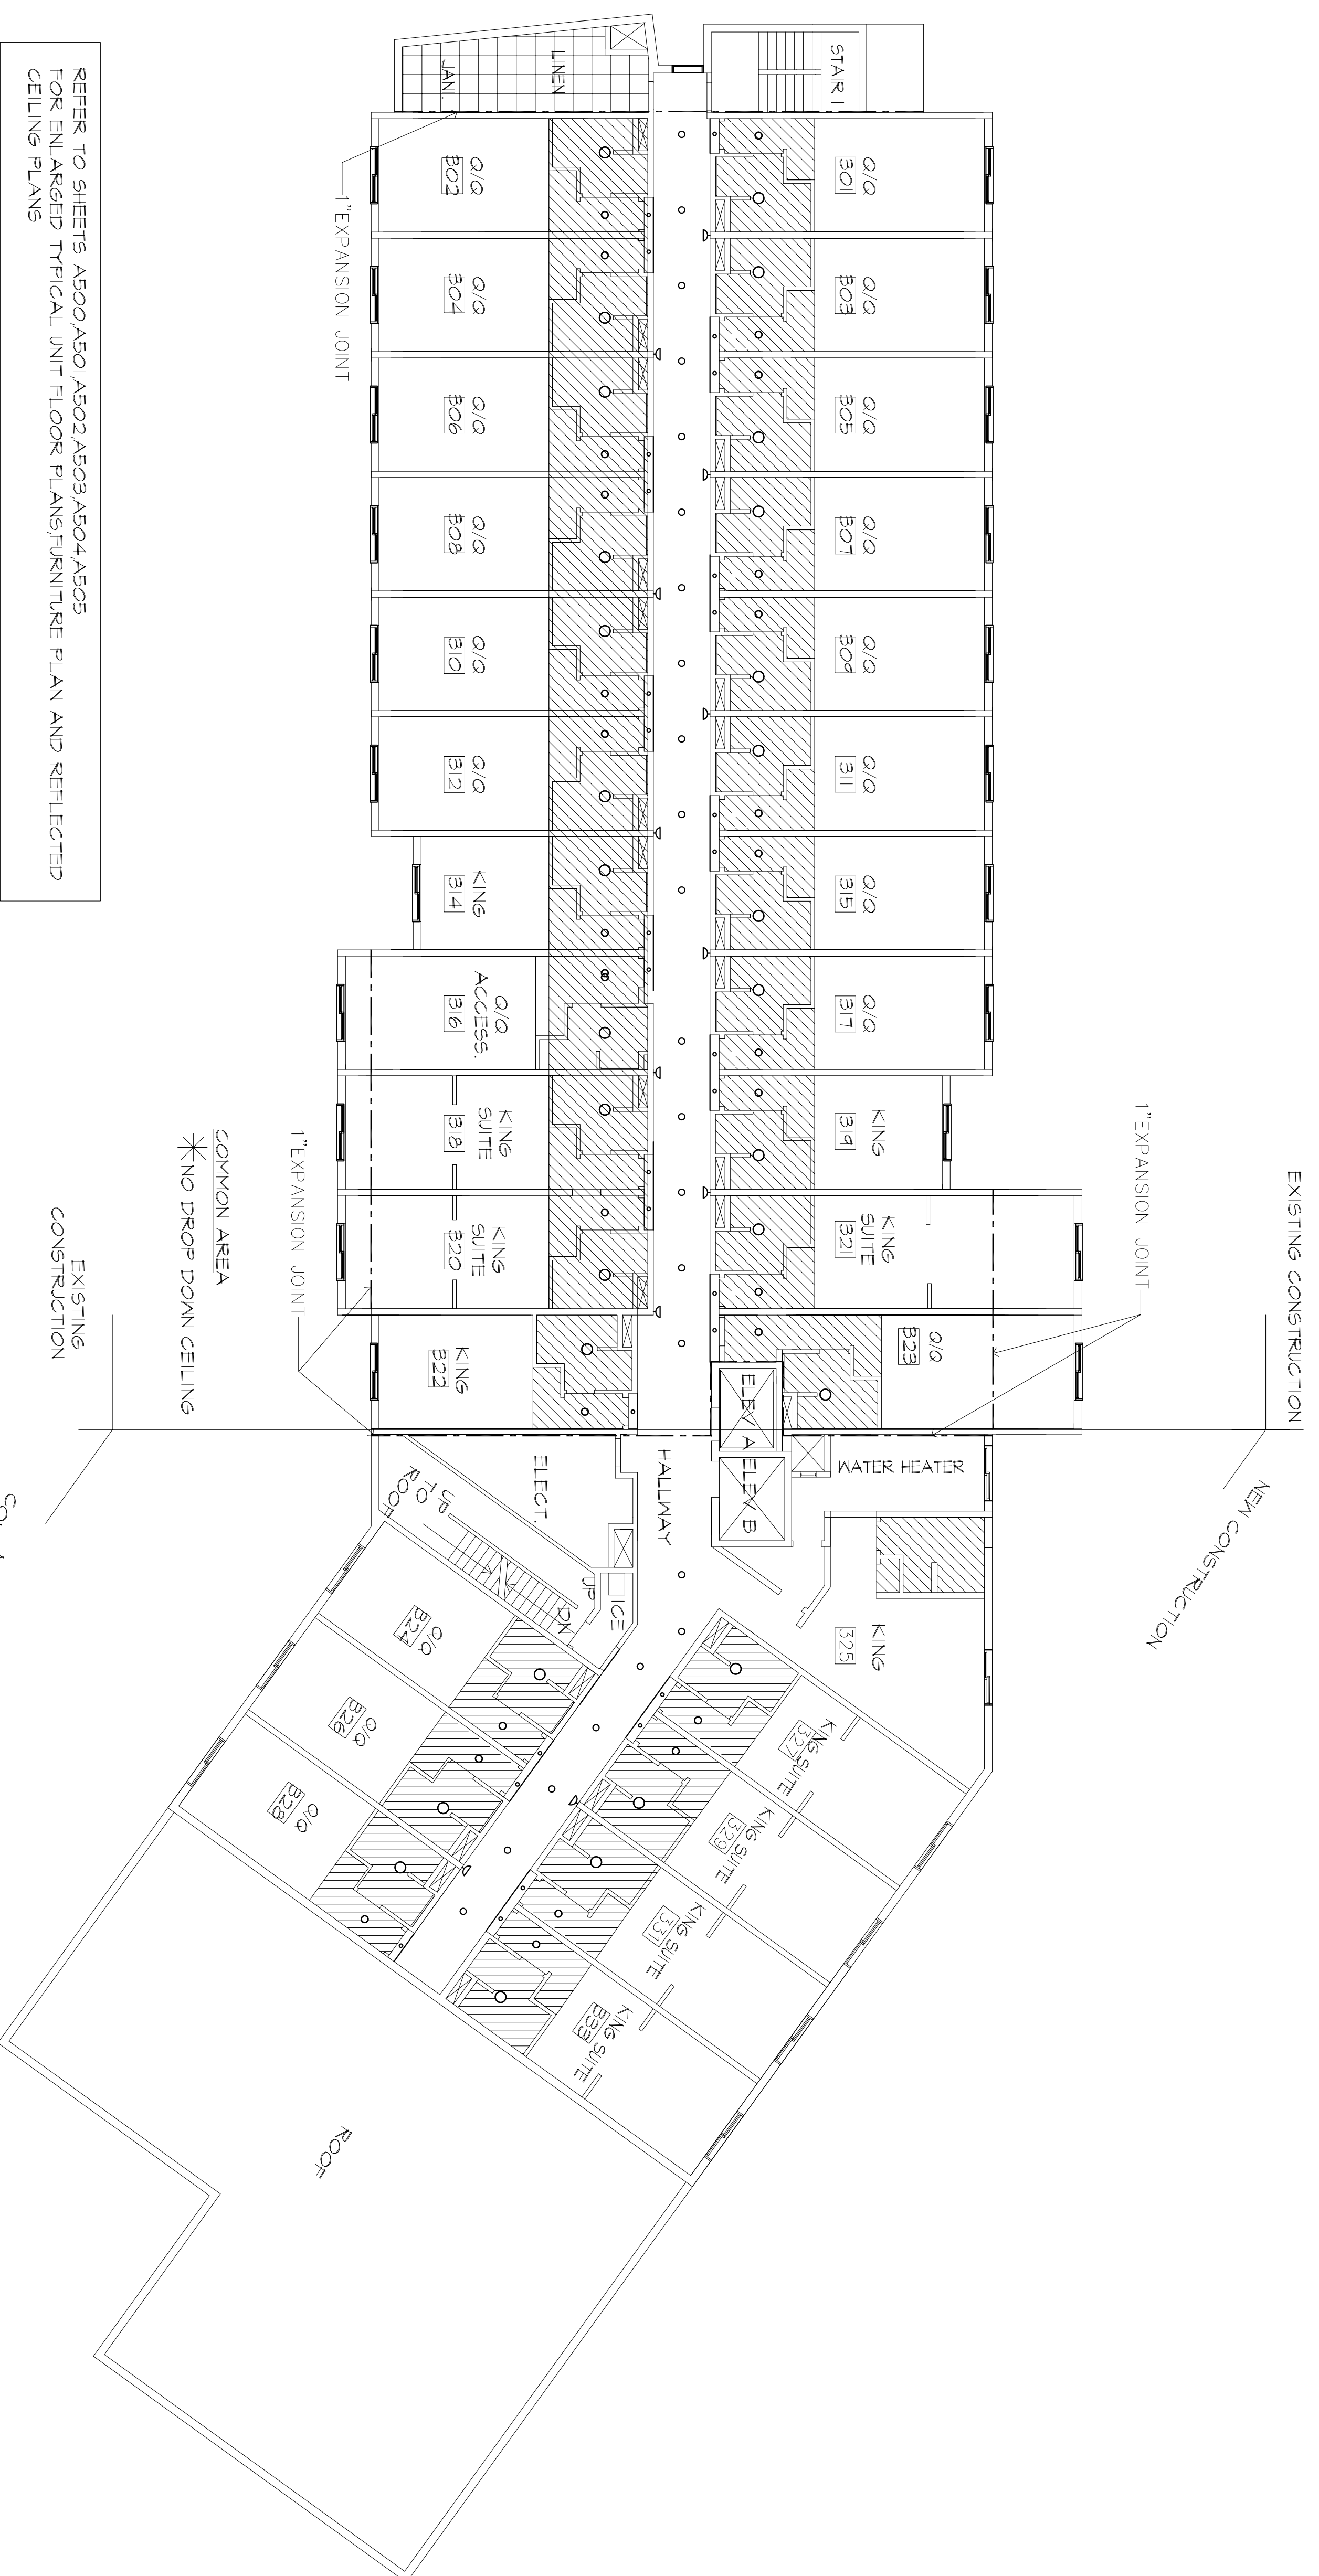


REFER TO SHEETS A500 A501 A502 A503 A504 A505  
FOR ENLARGED TYPICAL UNIT FLOOR PLANS/FURNITURE PLAN AND REFLECTED  
CEILING PLANS


**THIRD FLOOR REFLECTED CEILING PLAN**  
SCALE 3/32"=1'-0"

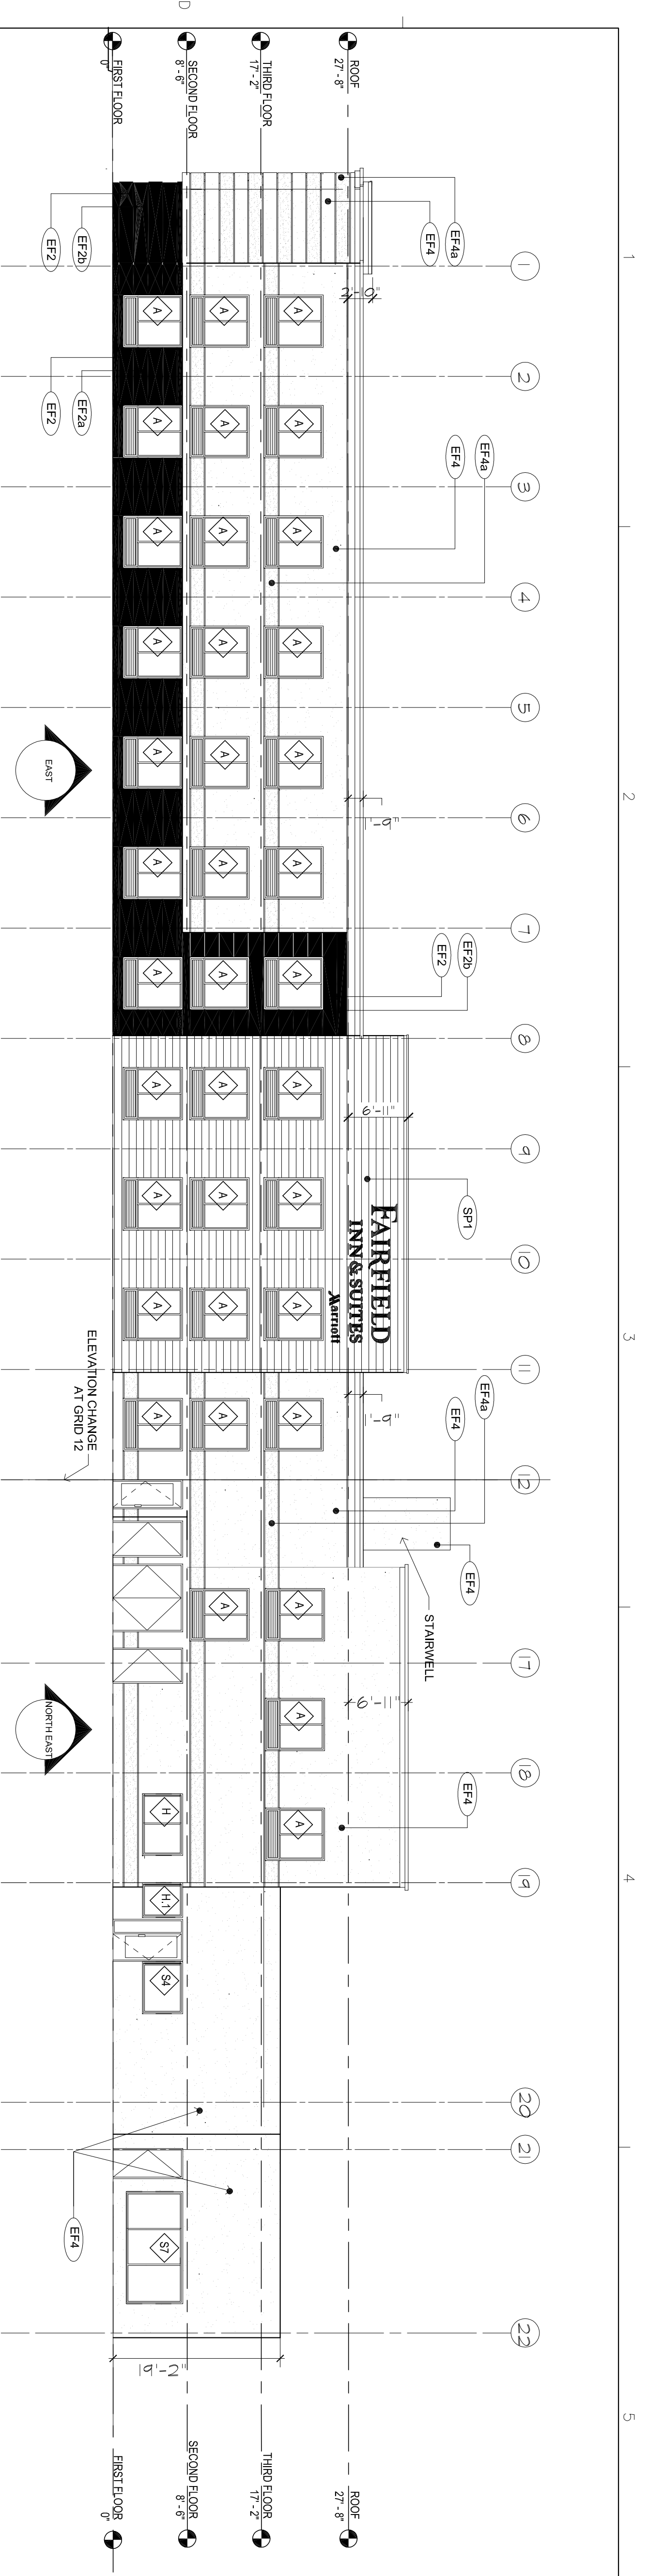


10 EAST /NORTH EAST ELEVATION  
SCALE 3/32"=1'-0"

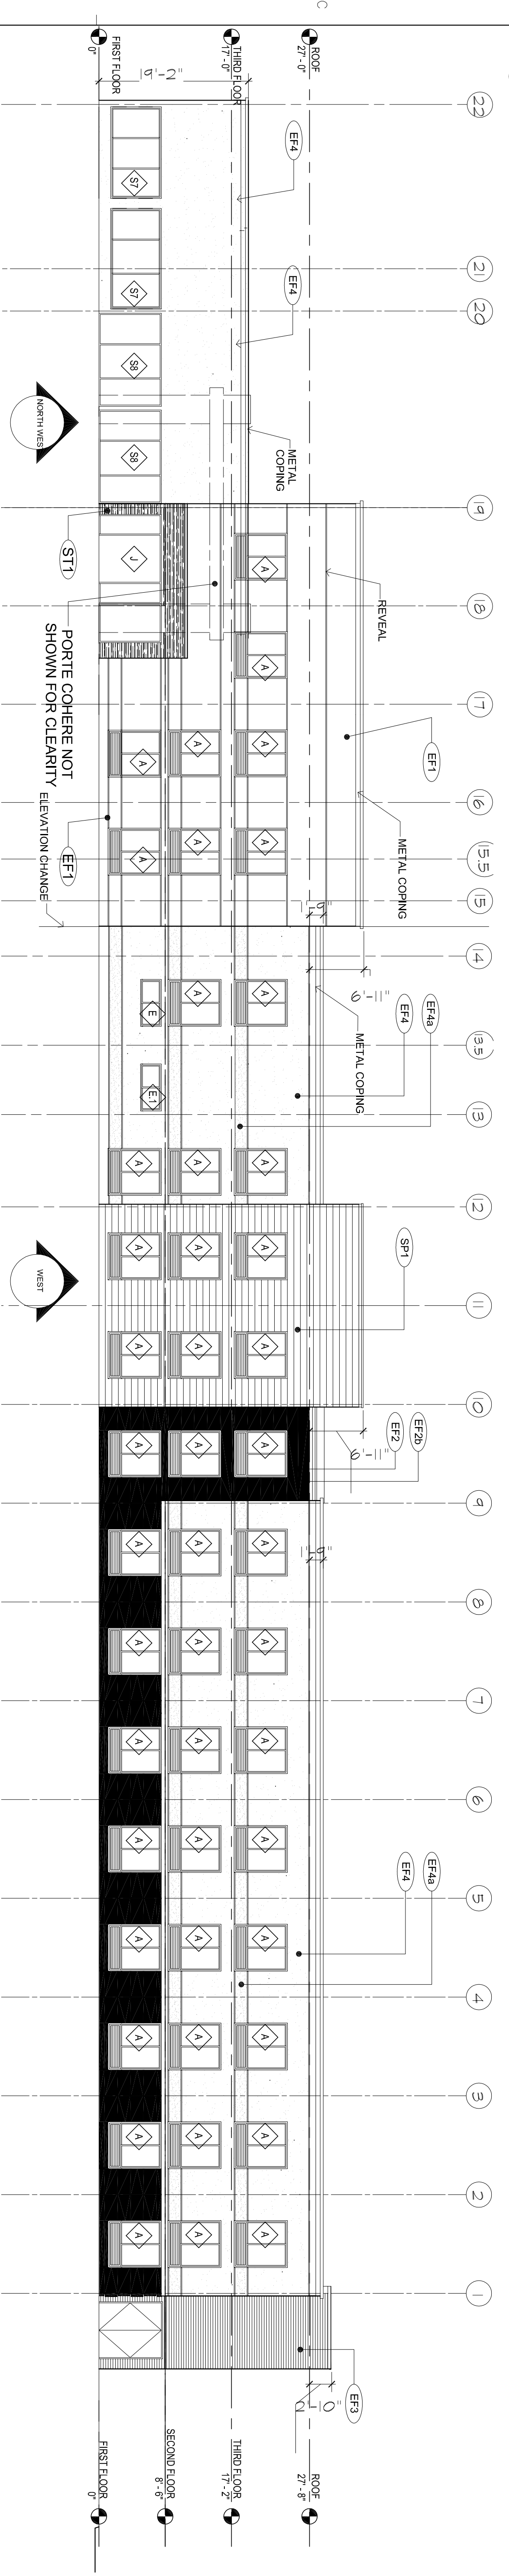

10C WEST /NORTH WEST ELEVATION  
SCALE 3/32"=1'-0"

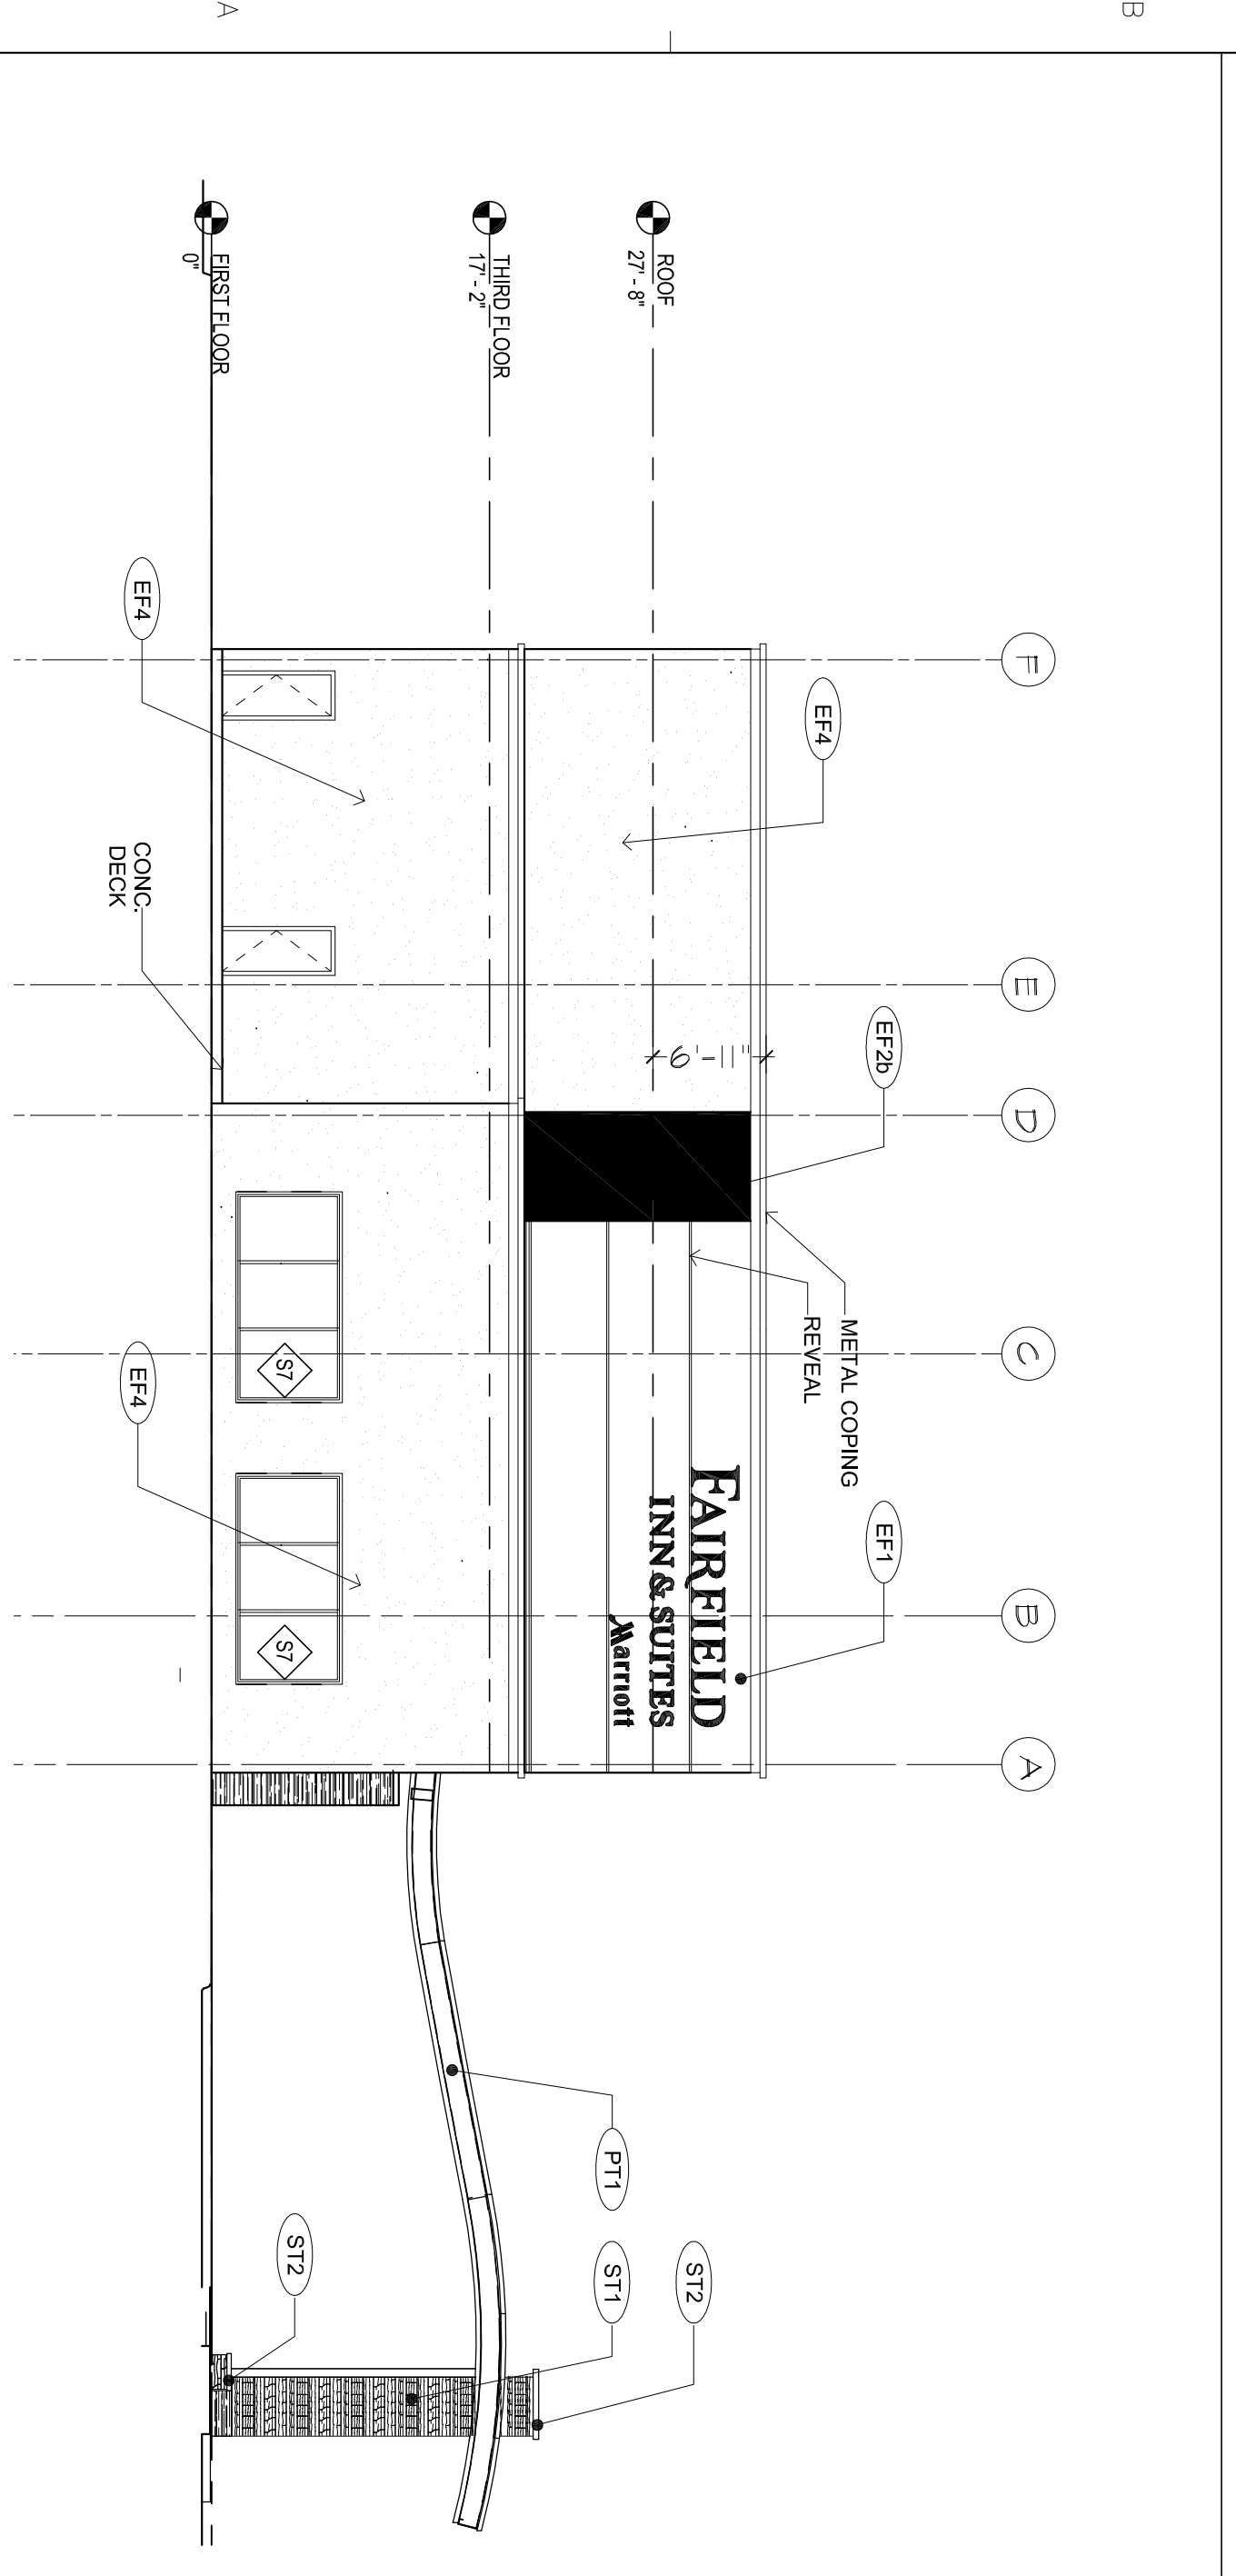

11A NORTH EAST ELEVATION  
SCALE 3/32"=1'-0"

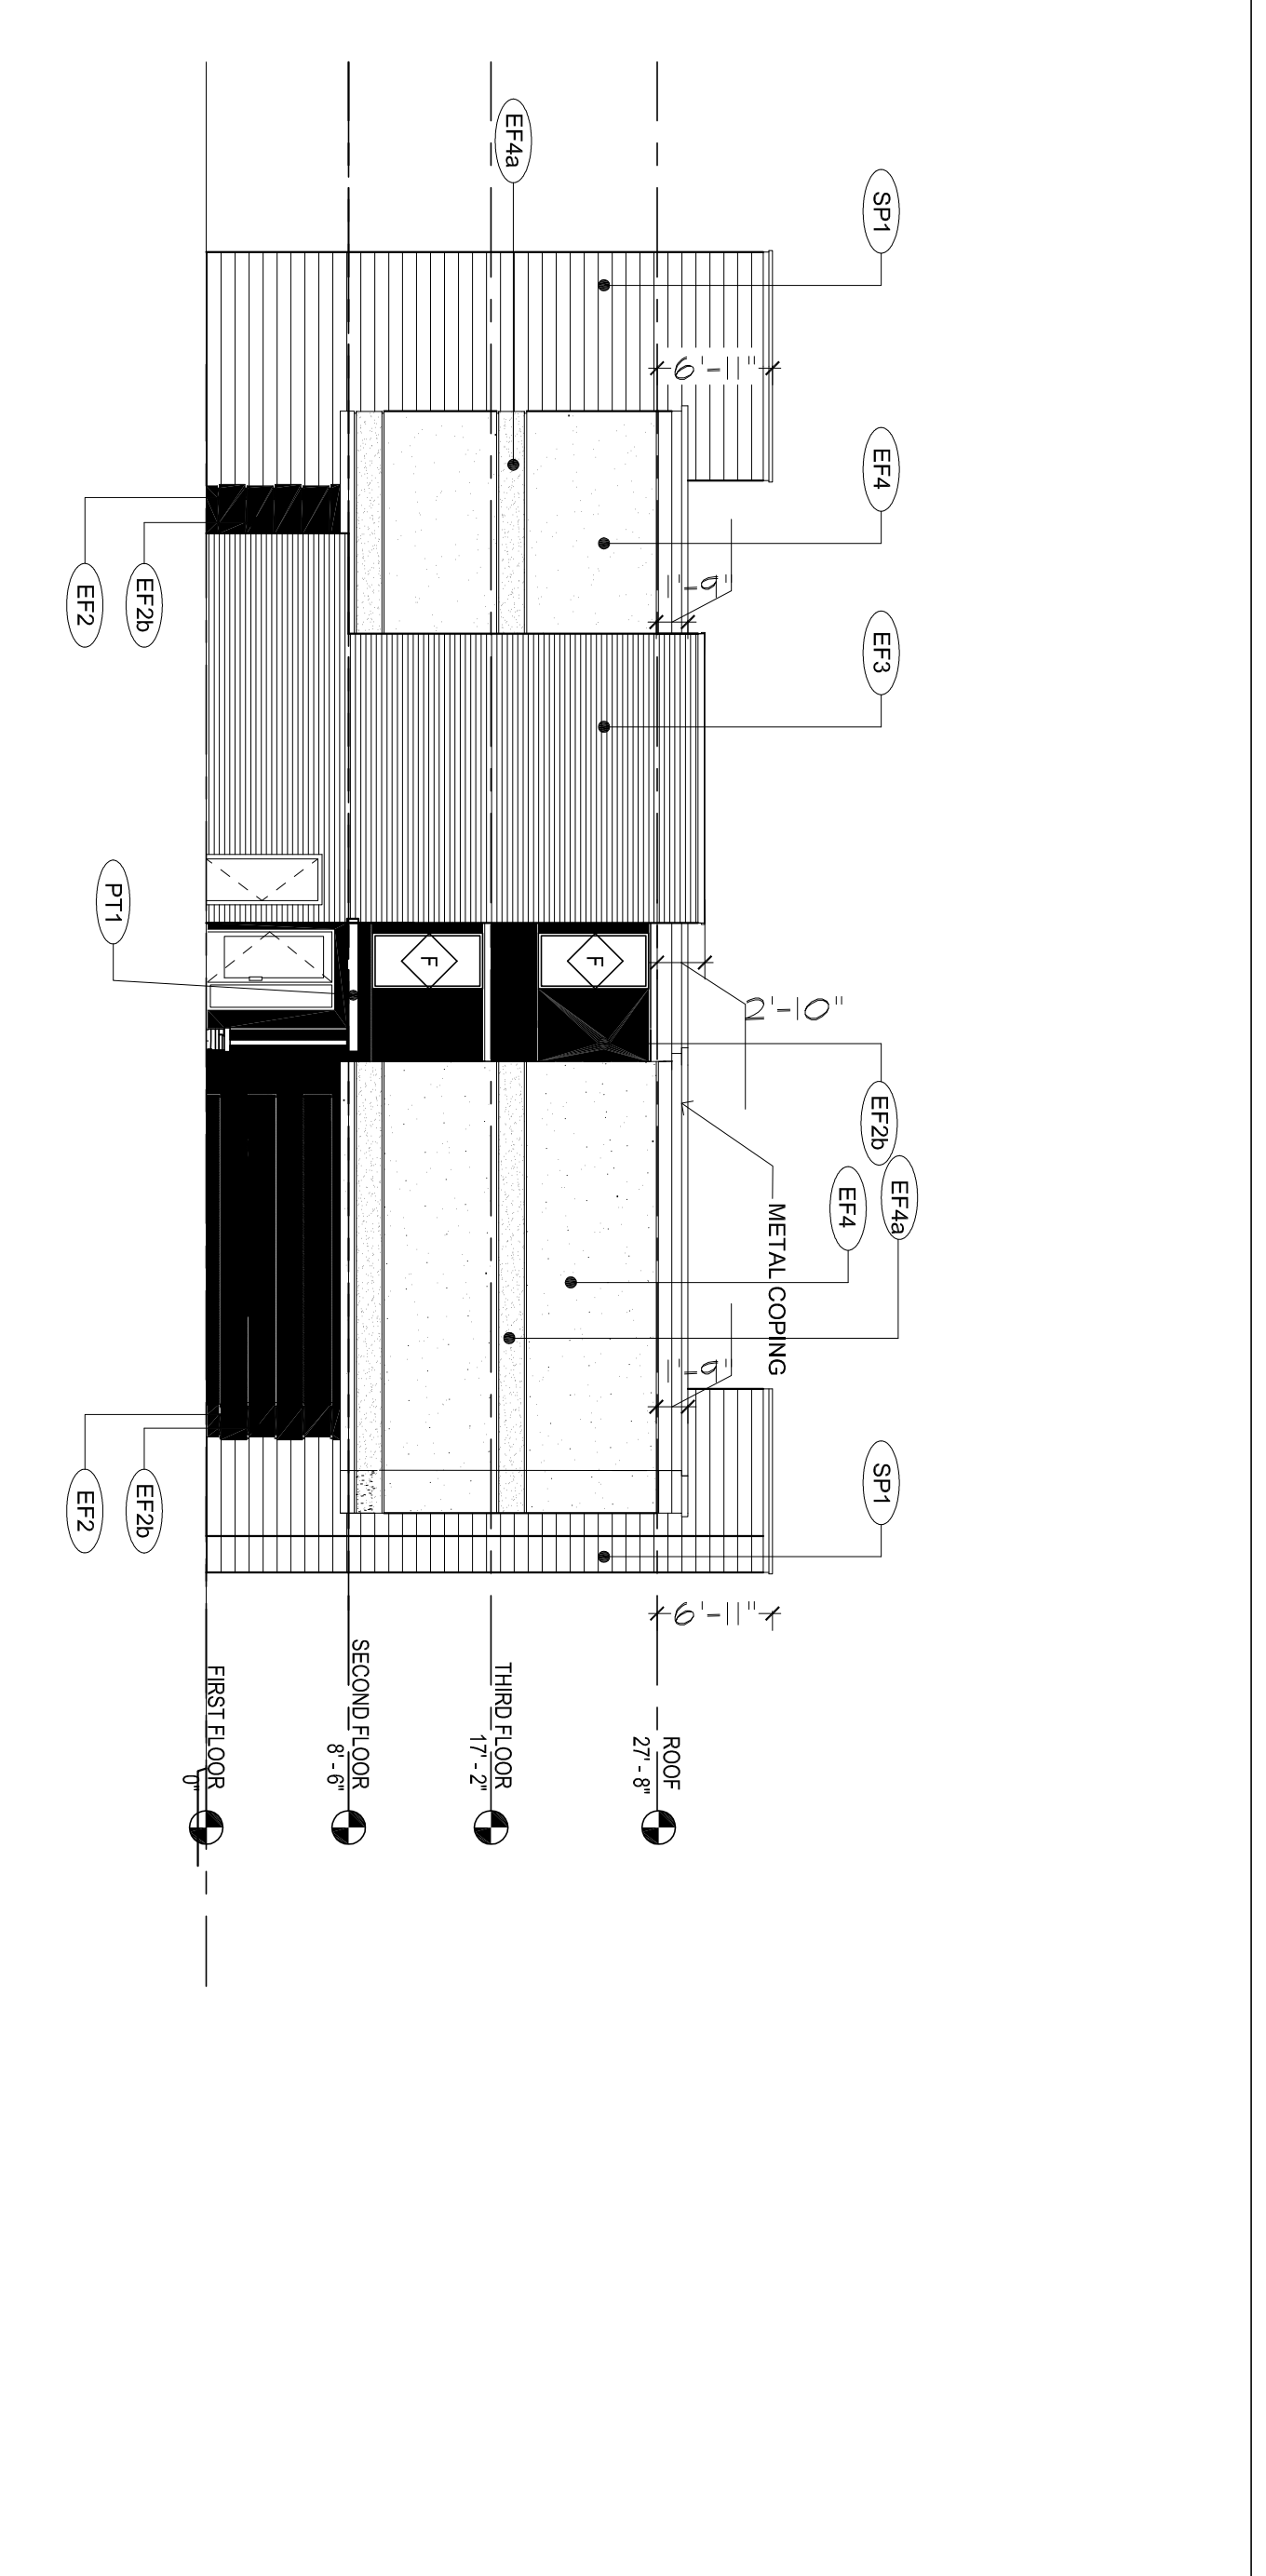

11A SOUTH ELEVATION  
SCALE 3/32"=1'-0"

- EF1 PEARLESSENT ACCENT EIFS FINISH
- EF2 DARK EIFS FINISH COLOR
- EF3 ACCENT EIFS COLOR
- EF4 DARK EIFS FINISH COLOR - TEXTURE
- EF5 STAR TOWER EIFS COLOR
- EF6 MAIN BUILDING EIFS COLOR
- EF7 ACCENT EIFS COLOR
- EF8 CULTURED STONE
- EF9 COPING
- EF10 EXTERIOR ACCENT FINISH
- EF11 -EXTERIOR BOARD SINGING
- EF12 -EXTERIOR PLAM (OPTIONAL)
- EF13 PAINT COLOR - ALUM. ROOF SHAPE
- EF14 CANOPY & OTHER METAL CORNICES, FASONS, ETC.
- EF15 PT1
- EF16 ST1
- EF17 ST2
- EF18 SP1
- EF19 EF20
- EF21 EF22
- EF23 EF24
- EF25 EF26
- EF27 EF28
- EF29 EF30
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- EF83 EF84
- EF85 EF86
- EF87 EF88
- EF89 EF90
- EF91 EF92
- EF93 EF94
- EF95 EF96
- EF97 EF98
- EF99 EF100

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3	12/22/2015	100% REVIEW SET

PROJECT NAME:	
PROJECT NUMBER:	15180
DRAWING NAME:	
SHEET NAME:	ELEVATION
DRAWN BY:	BBC
CHECKED BY:	BBC
DATE:	12-22-15
SCALE:	AS NOTED
DRAWING NUMBER:	A200

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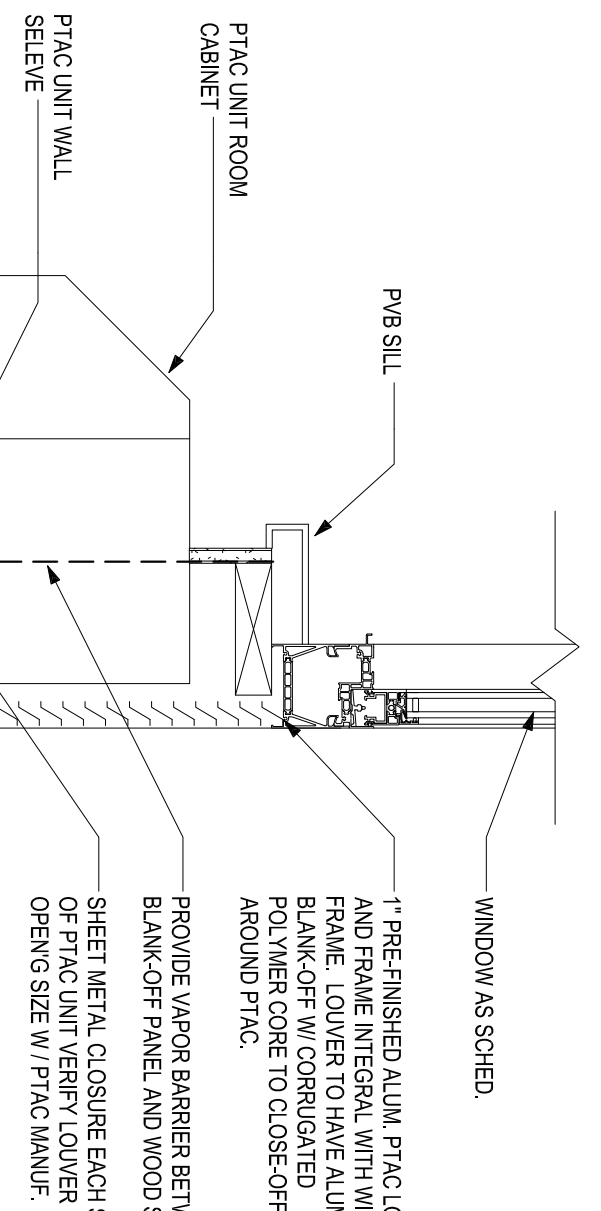
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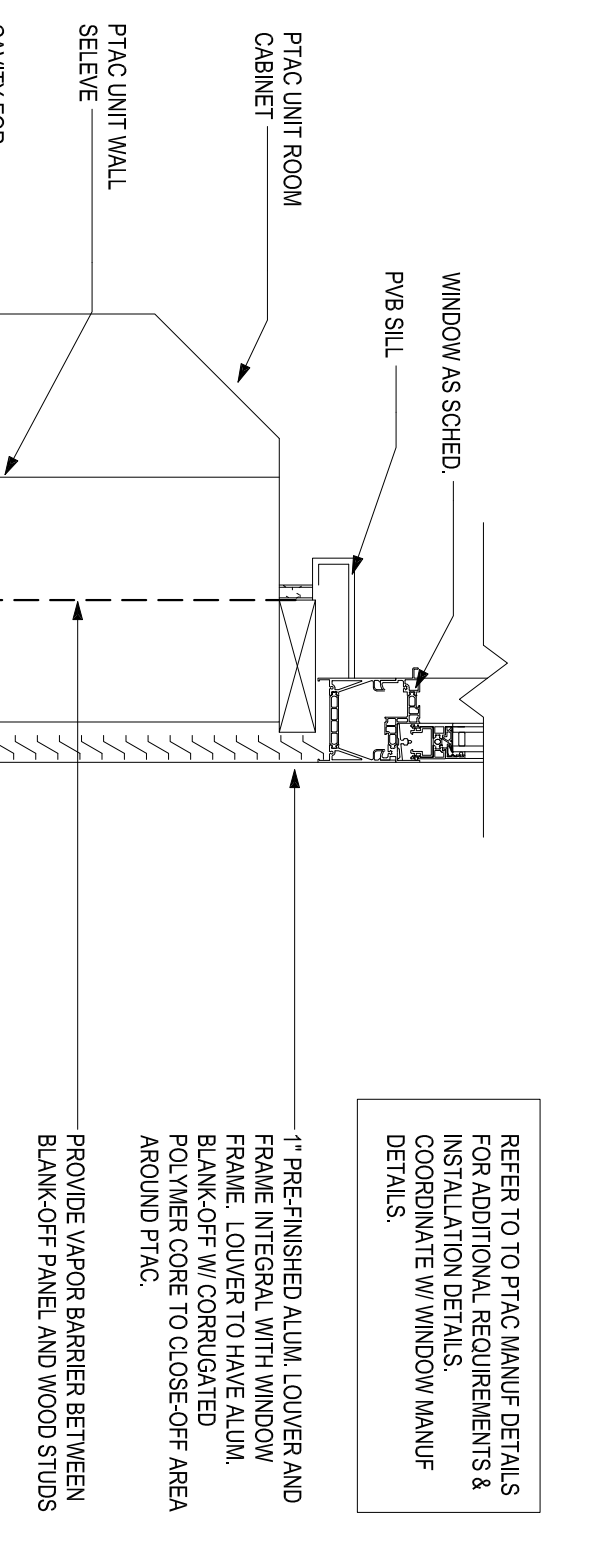
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3	12/22/2015	100% REVIEW SET

PROJECT NAME:  
 ELEVATION DETAILS


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 CHECKED BY: BBC  
 DATE: 12-22-15  
 SCALE: AS NOTED  
 DRAWING NUMBER  
**A201**




**5B**  
**PTAC @ FIRST FLOOR**  
 SCALE 1-1/2"=1'-0"




**3B**  
**PTAC @ EIFS**  
 SCALE 1-1/2"=1'-0"

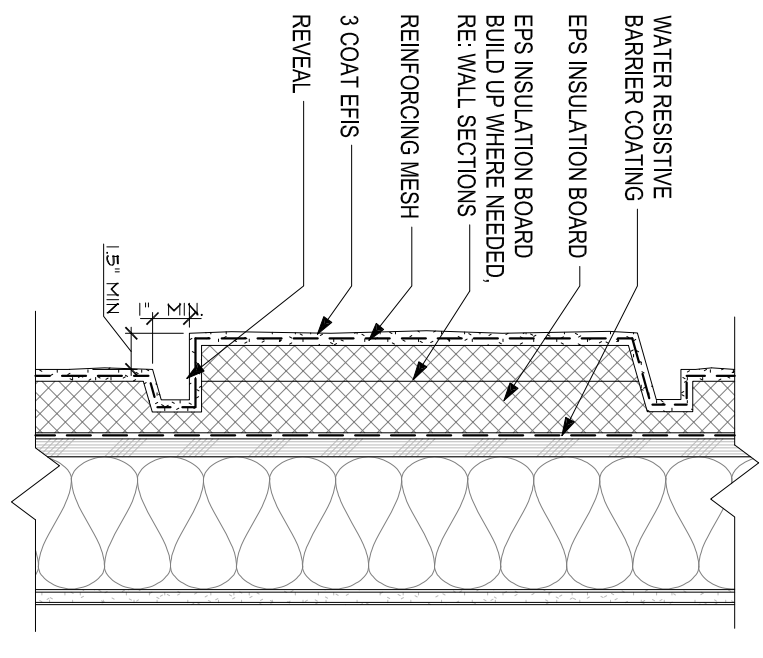

**3A**  
**EIFS RUSTICATION**  
 SCALE 1-1/2"=1'-0"

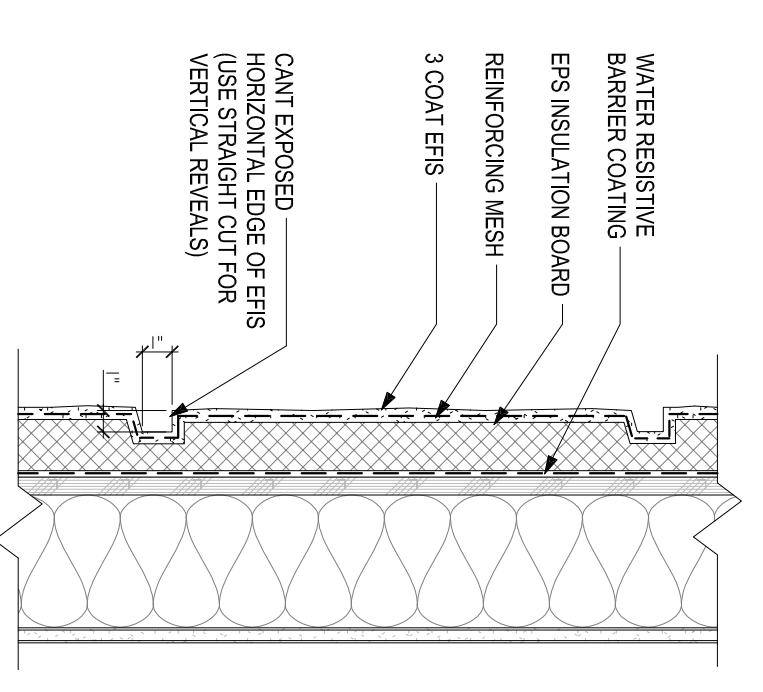

**4A**  
**EIFS DETAILS**  
 SCALE 3"=1'-0"

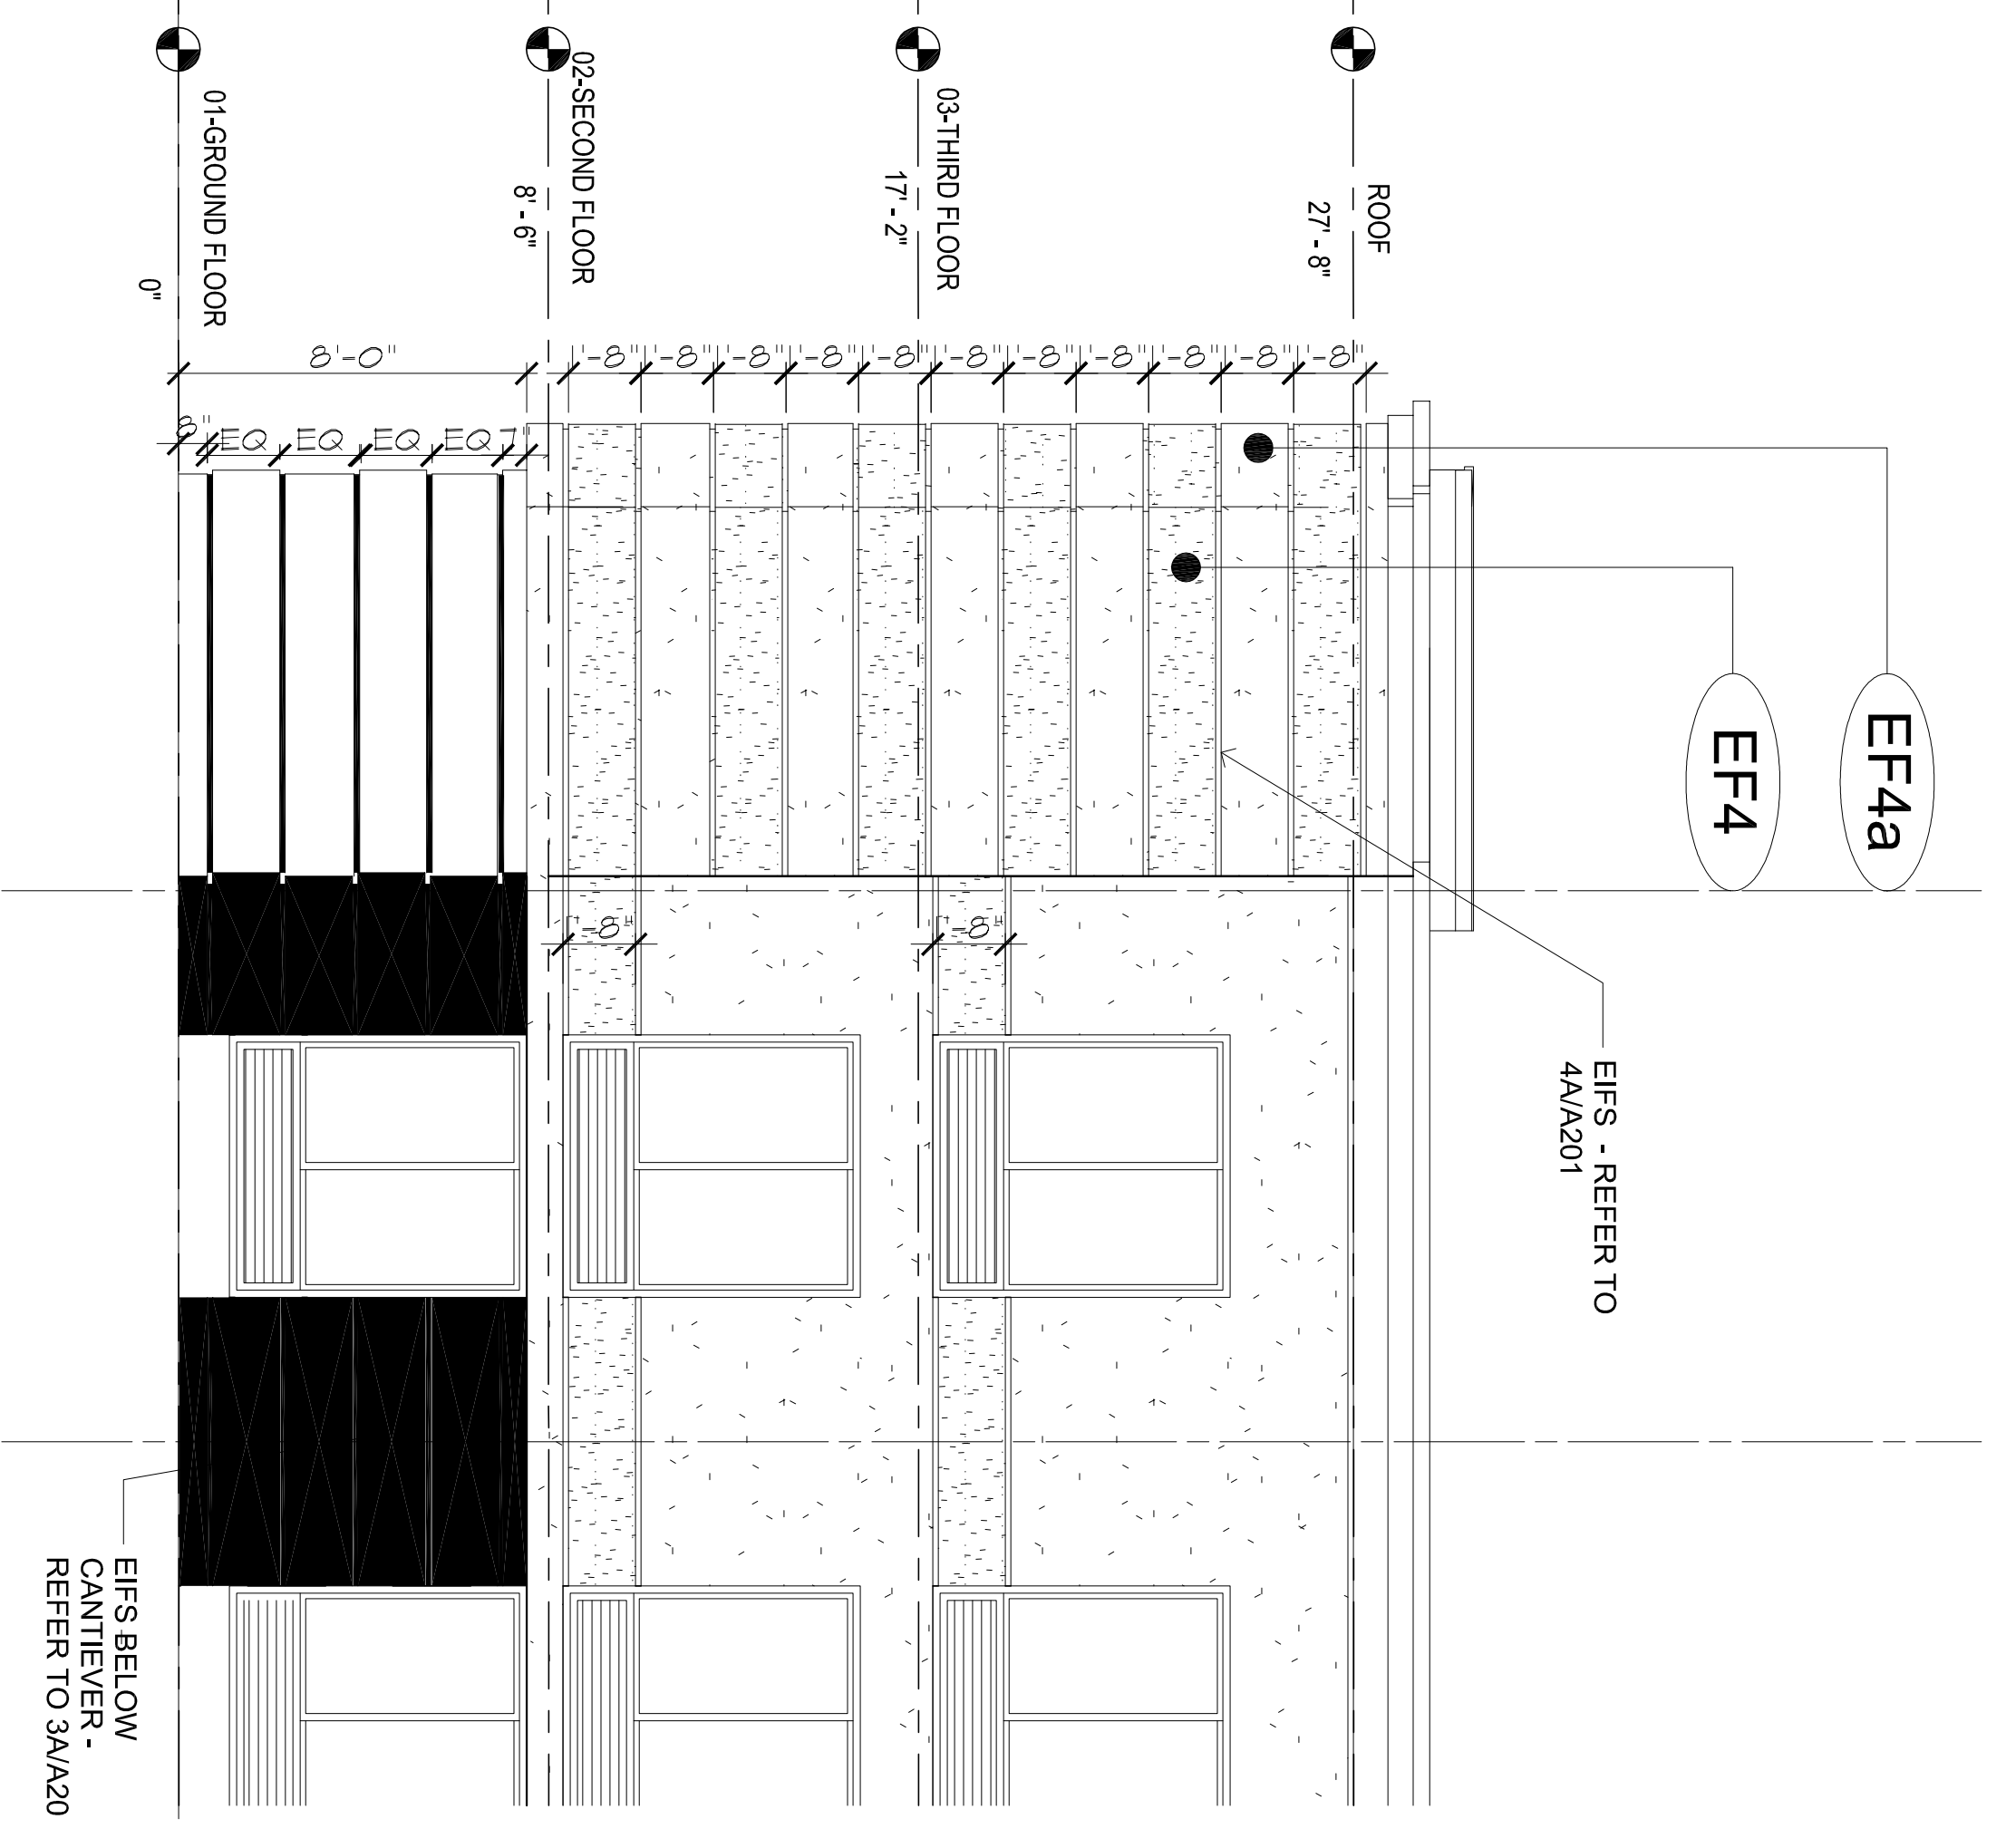

**1A**  
**ELEVATION DETAILS**  
 SCALE 1/4"=1'-0"

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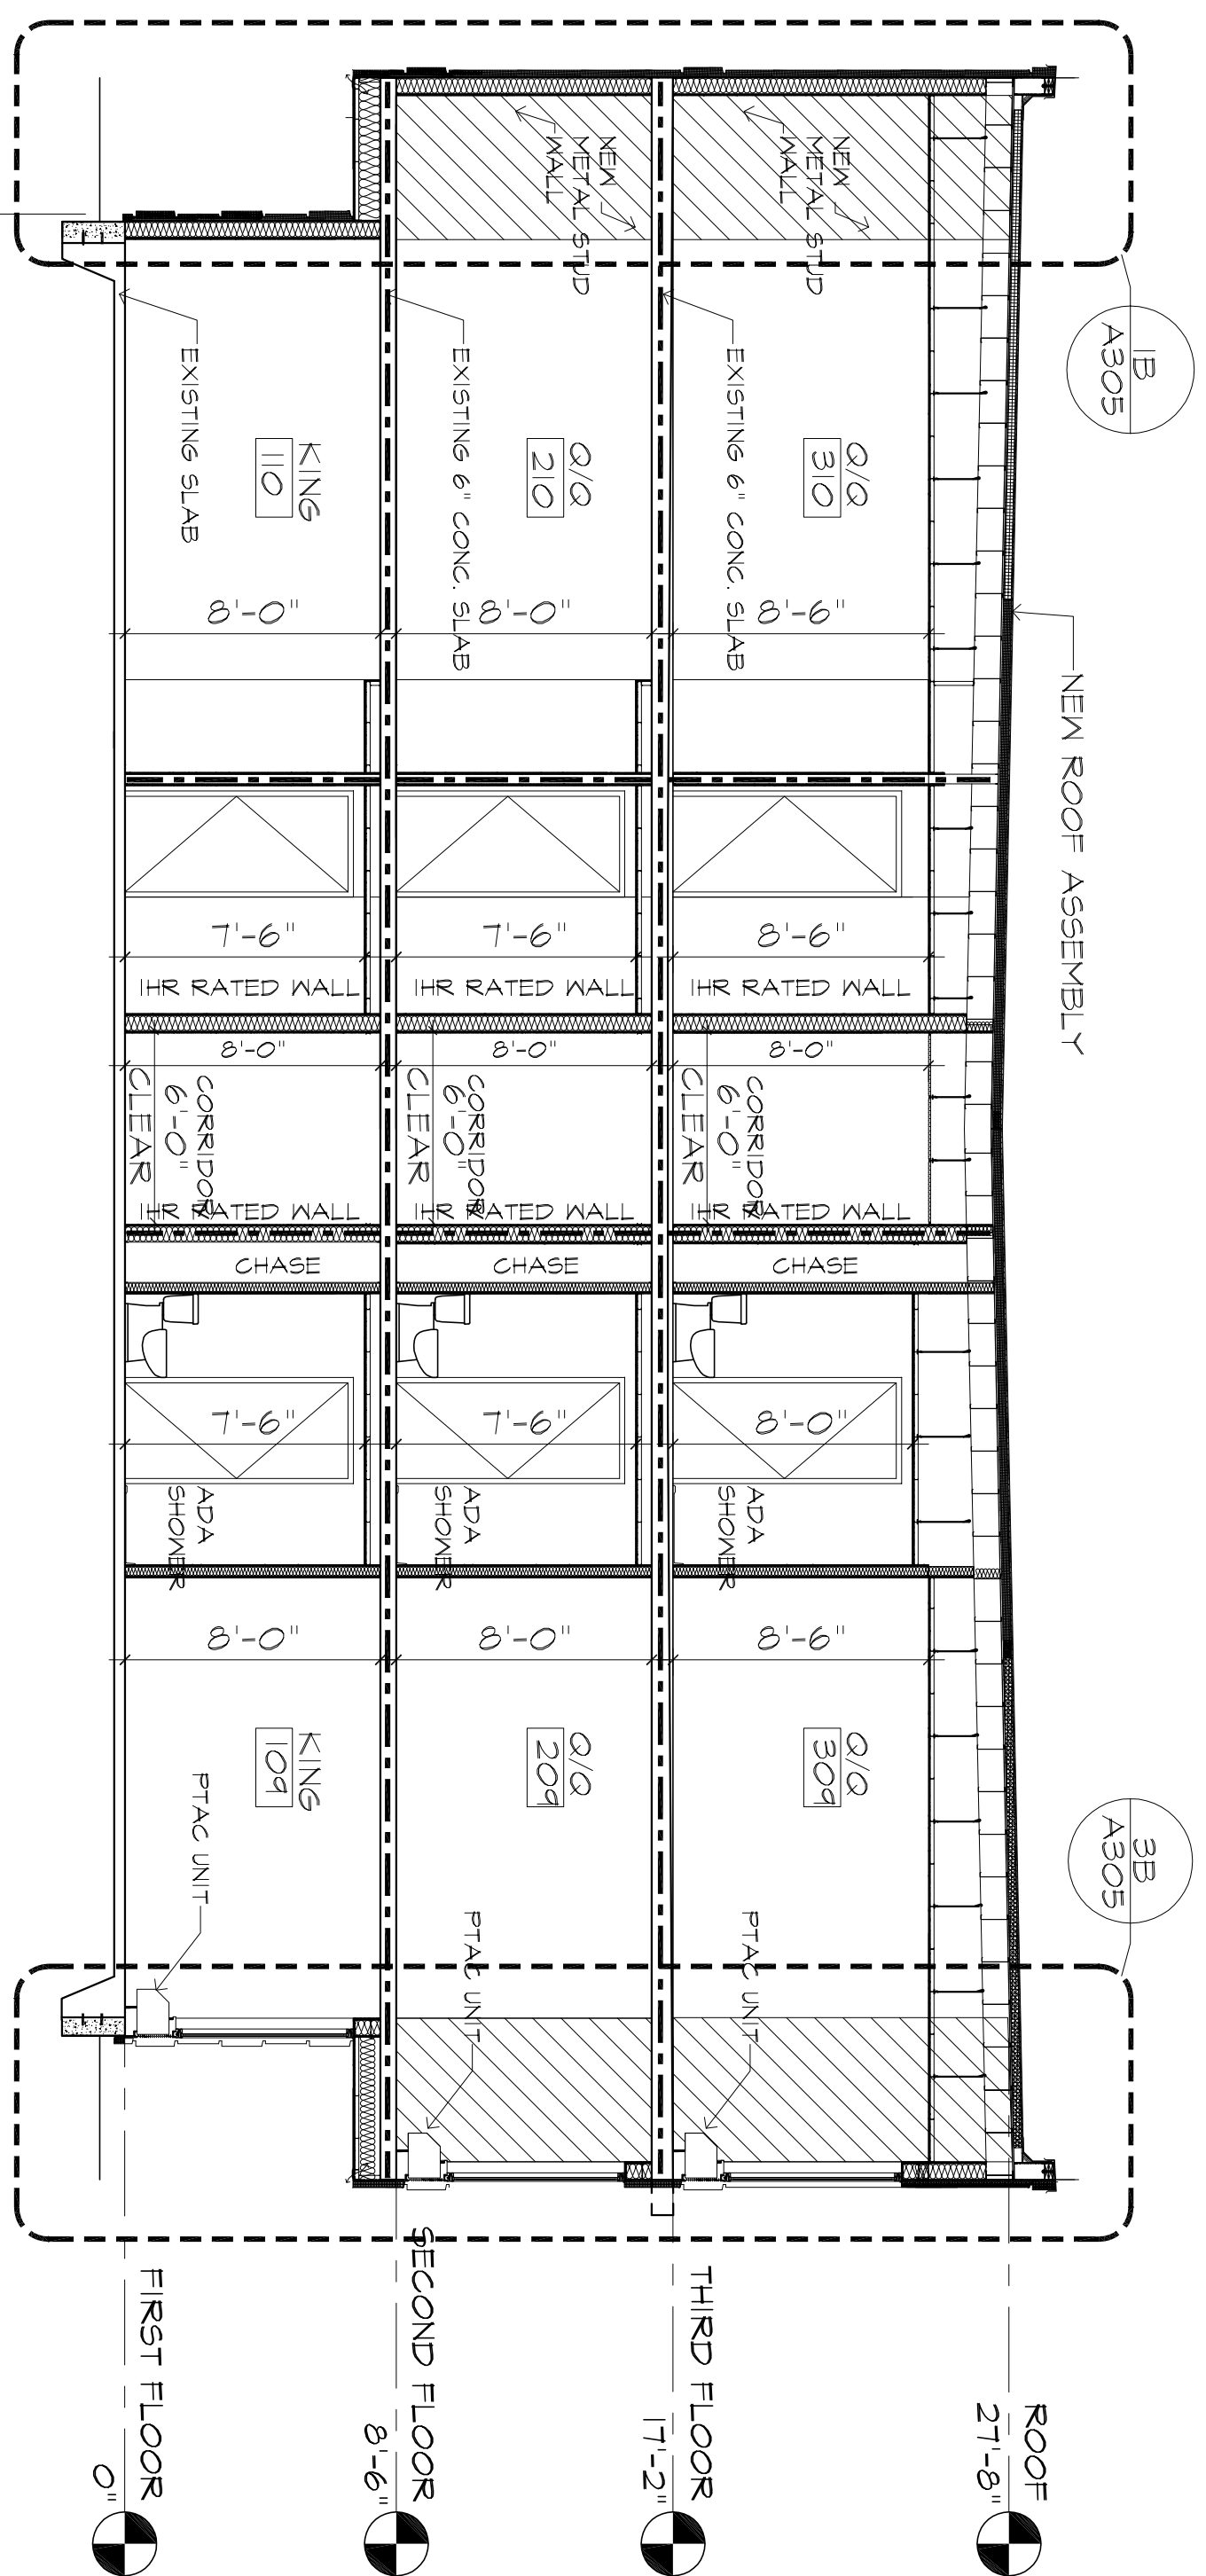
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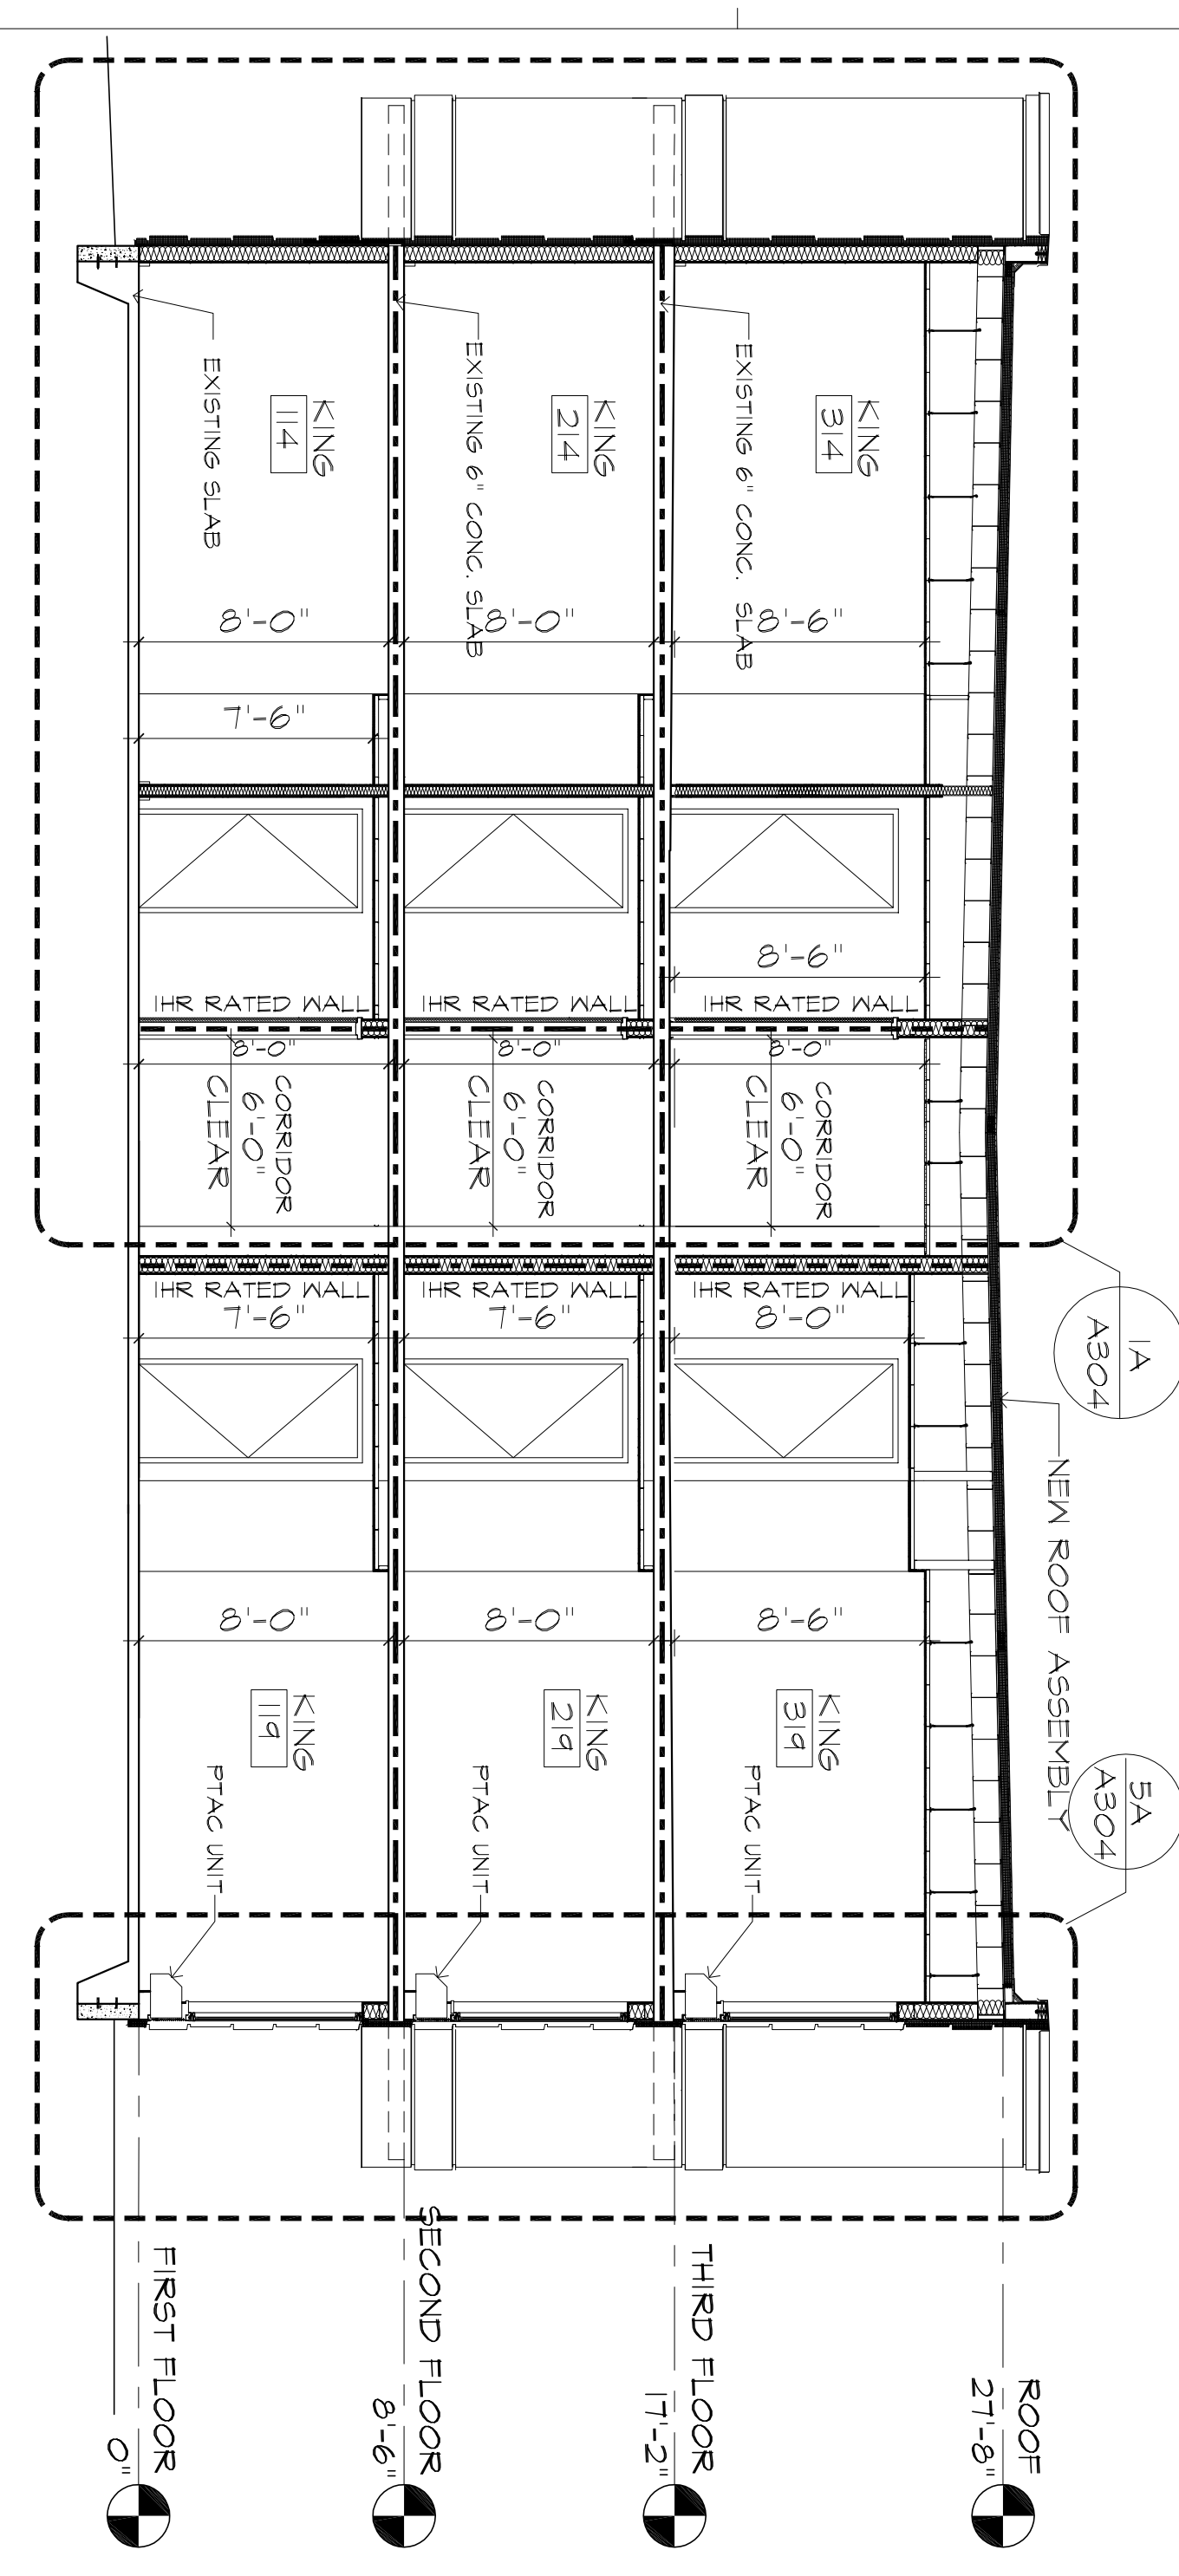
ISSUES & REVISIONS	
NO.	DATE DESCRIPTION
1	06/21/2015 30% REVIEW SET
2	11/22/2015 50% REVIEW SET
3	12/22/2015 100% REVIEW SET

PROJECT NUMBER:	15180
DRAWING NAME:	BUILDING SECTIONS
SHEET NAME:	BUILDING SECTIONS
DRAWN BY:	BBC
CHECKED BY:	BBC
DATE:	12-22-15
SCALE:	AS NOTED
DRAWING NUMBER:	



A301



4A BUILDING SECTION @ GUESTROOM  
 SCALE 3/16"=1'-0"



1A BUILDING SECTION @ GUESTROOM  
 SCALE 3/16"=1'-0"

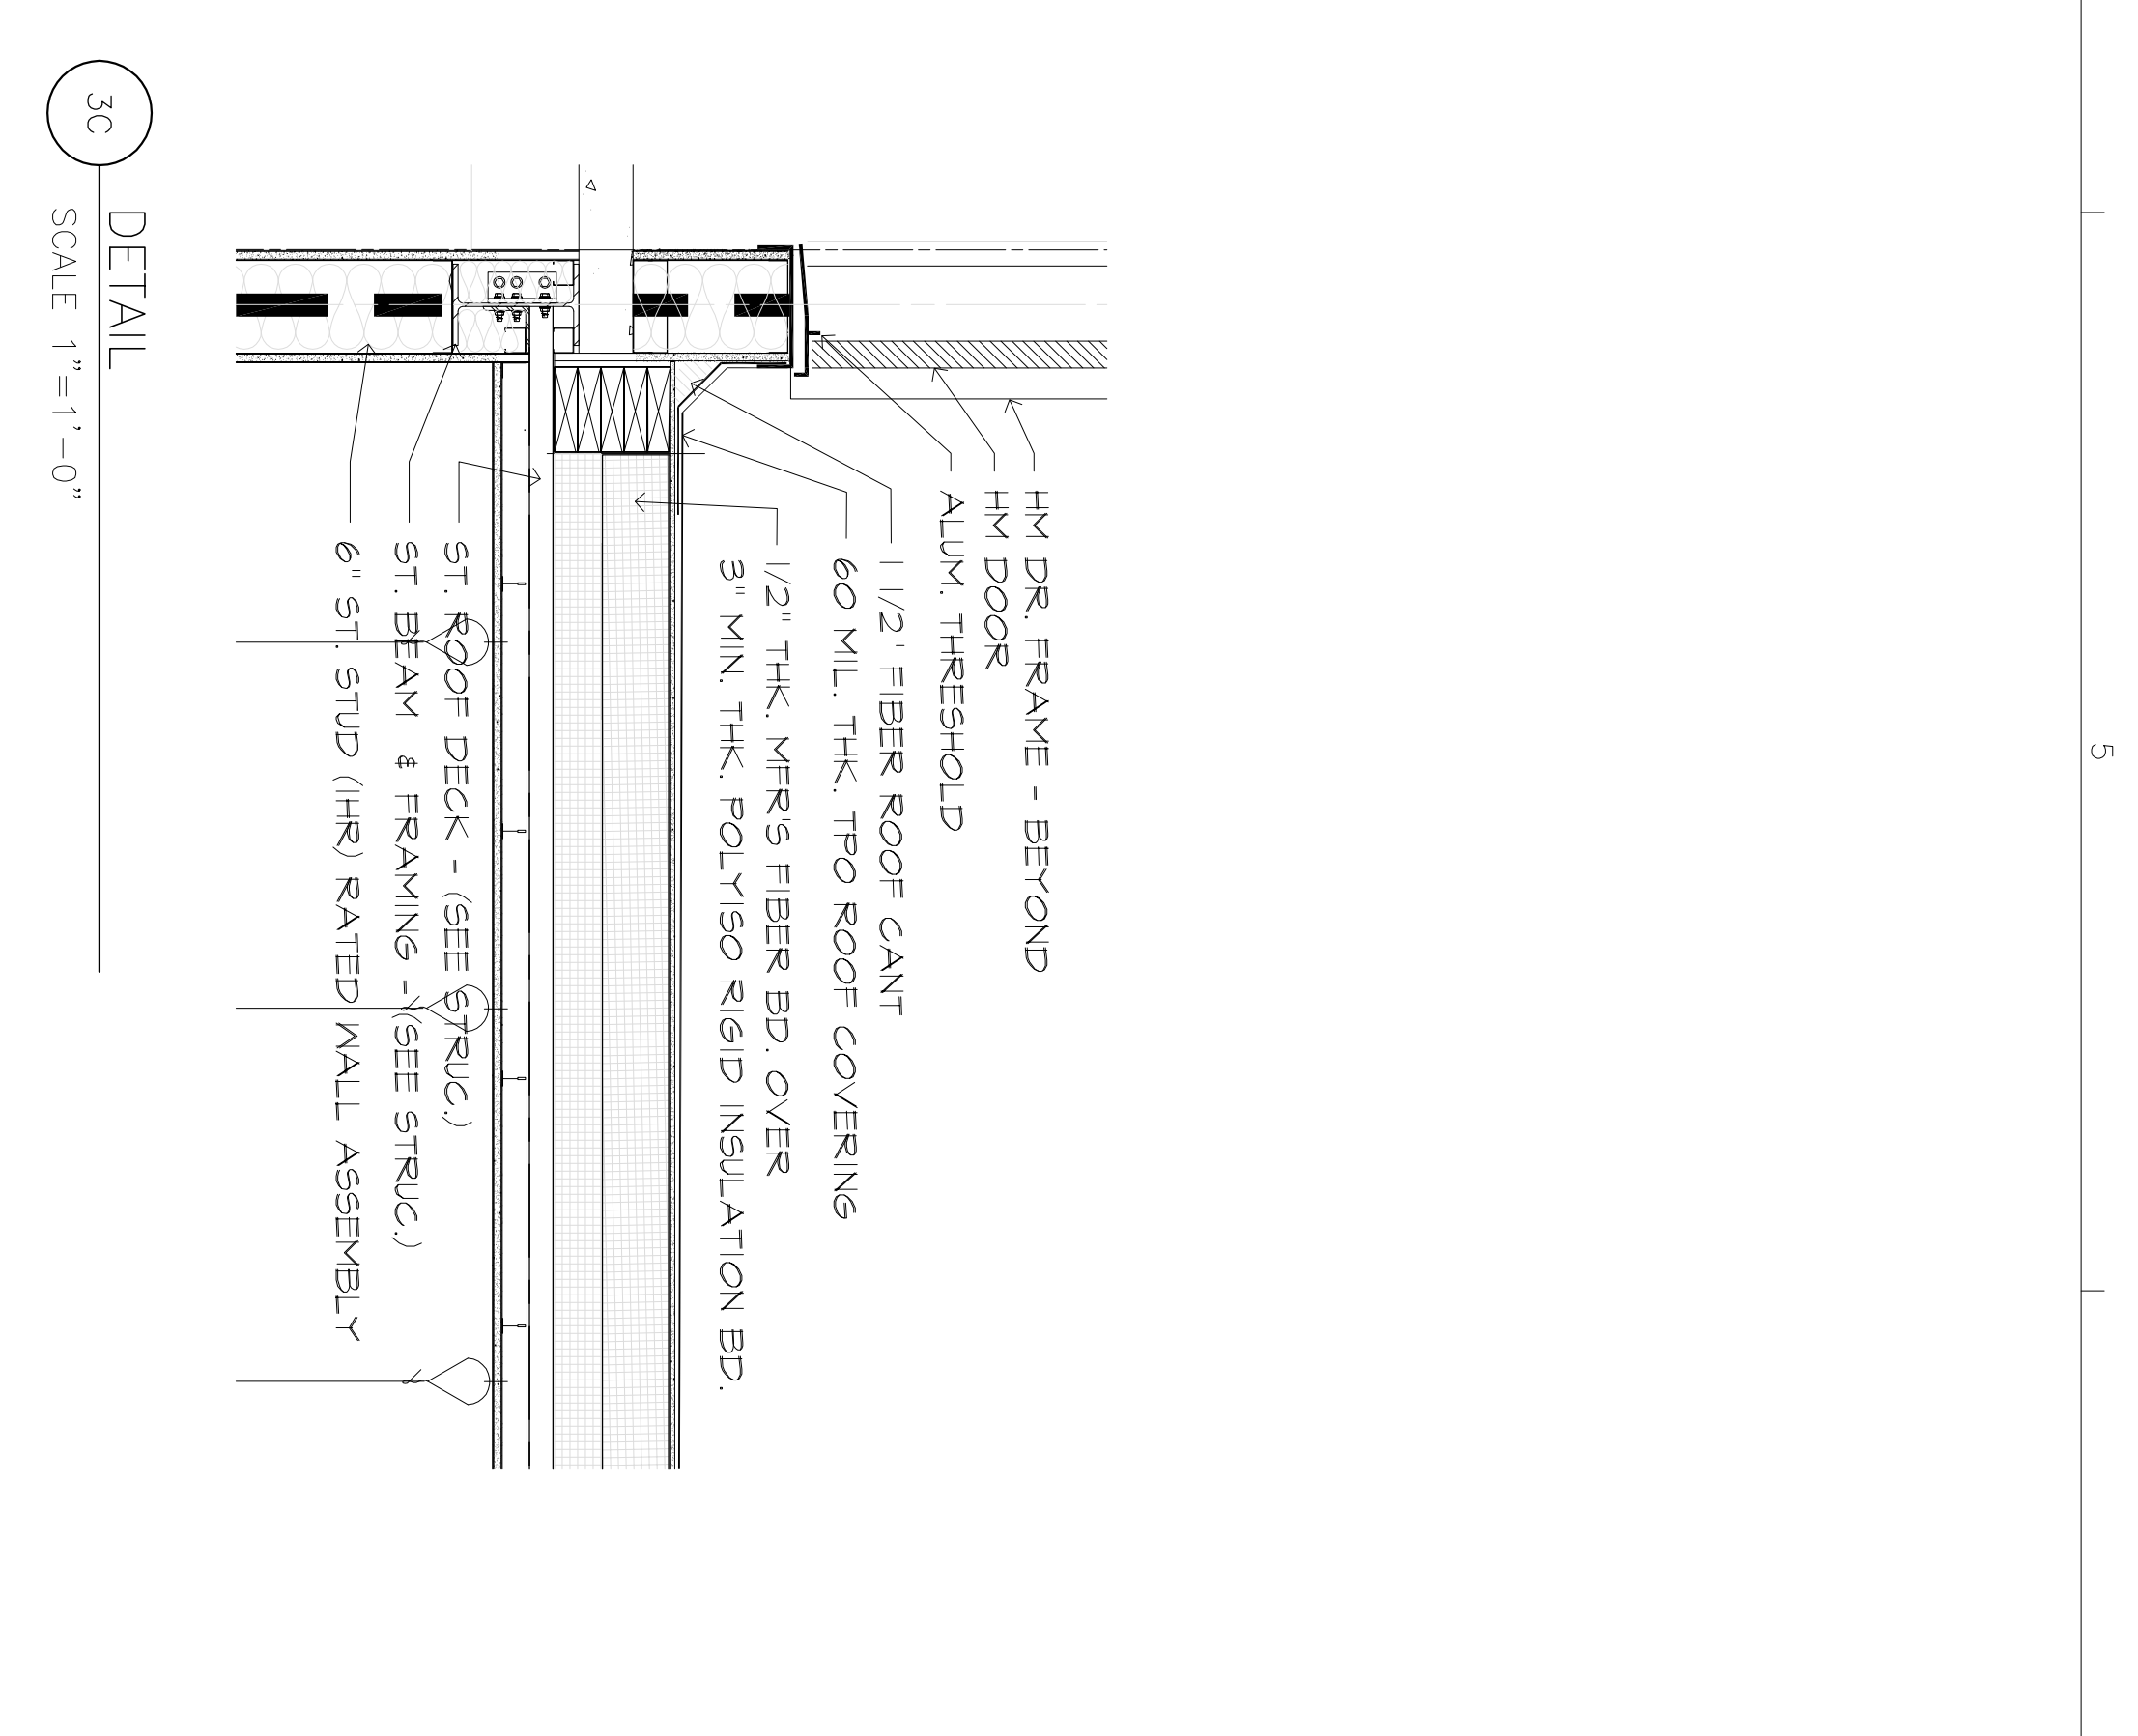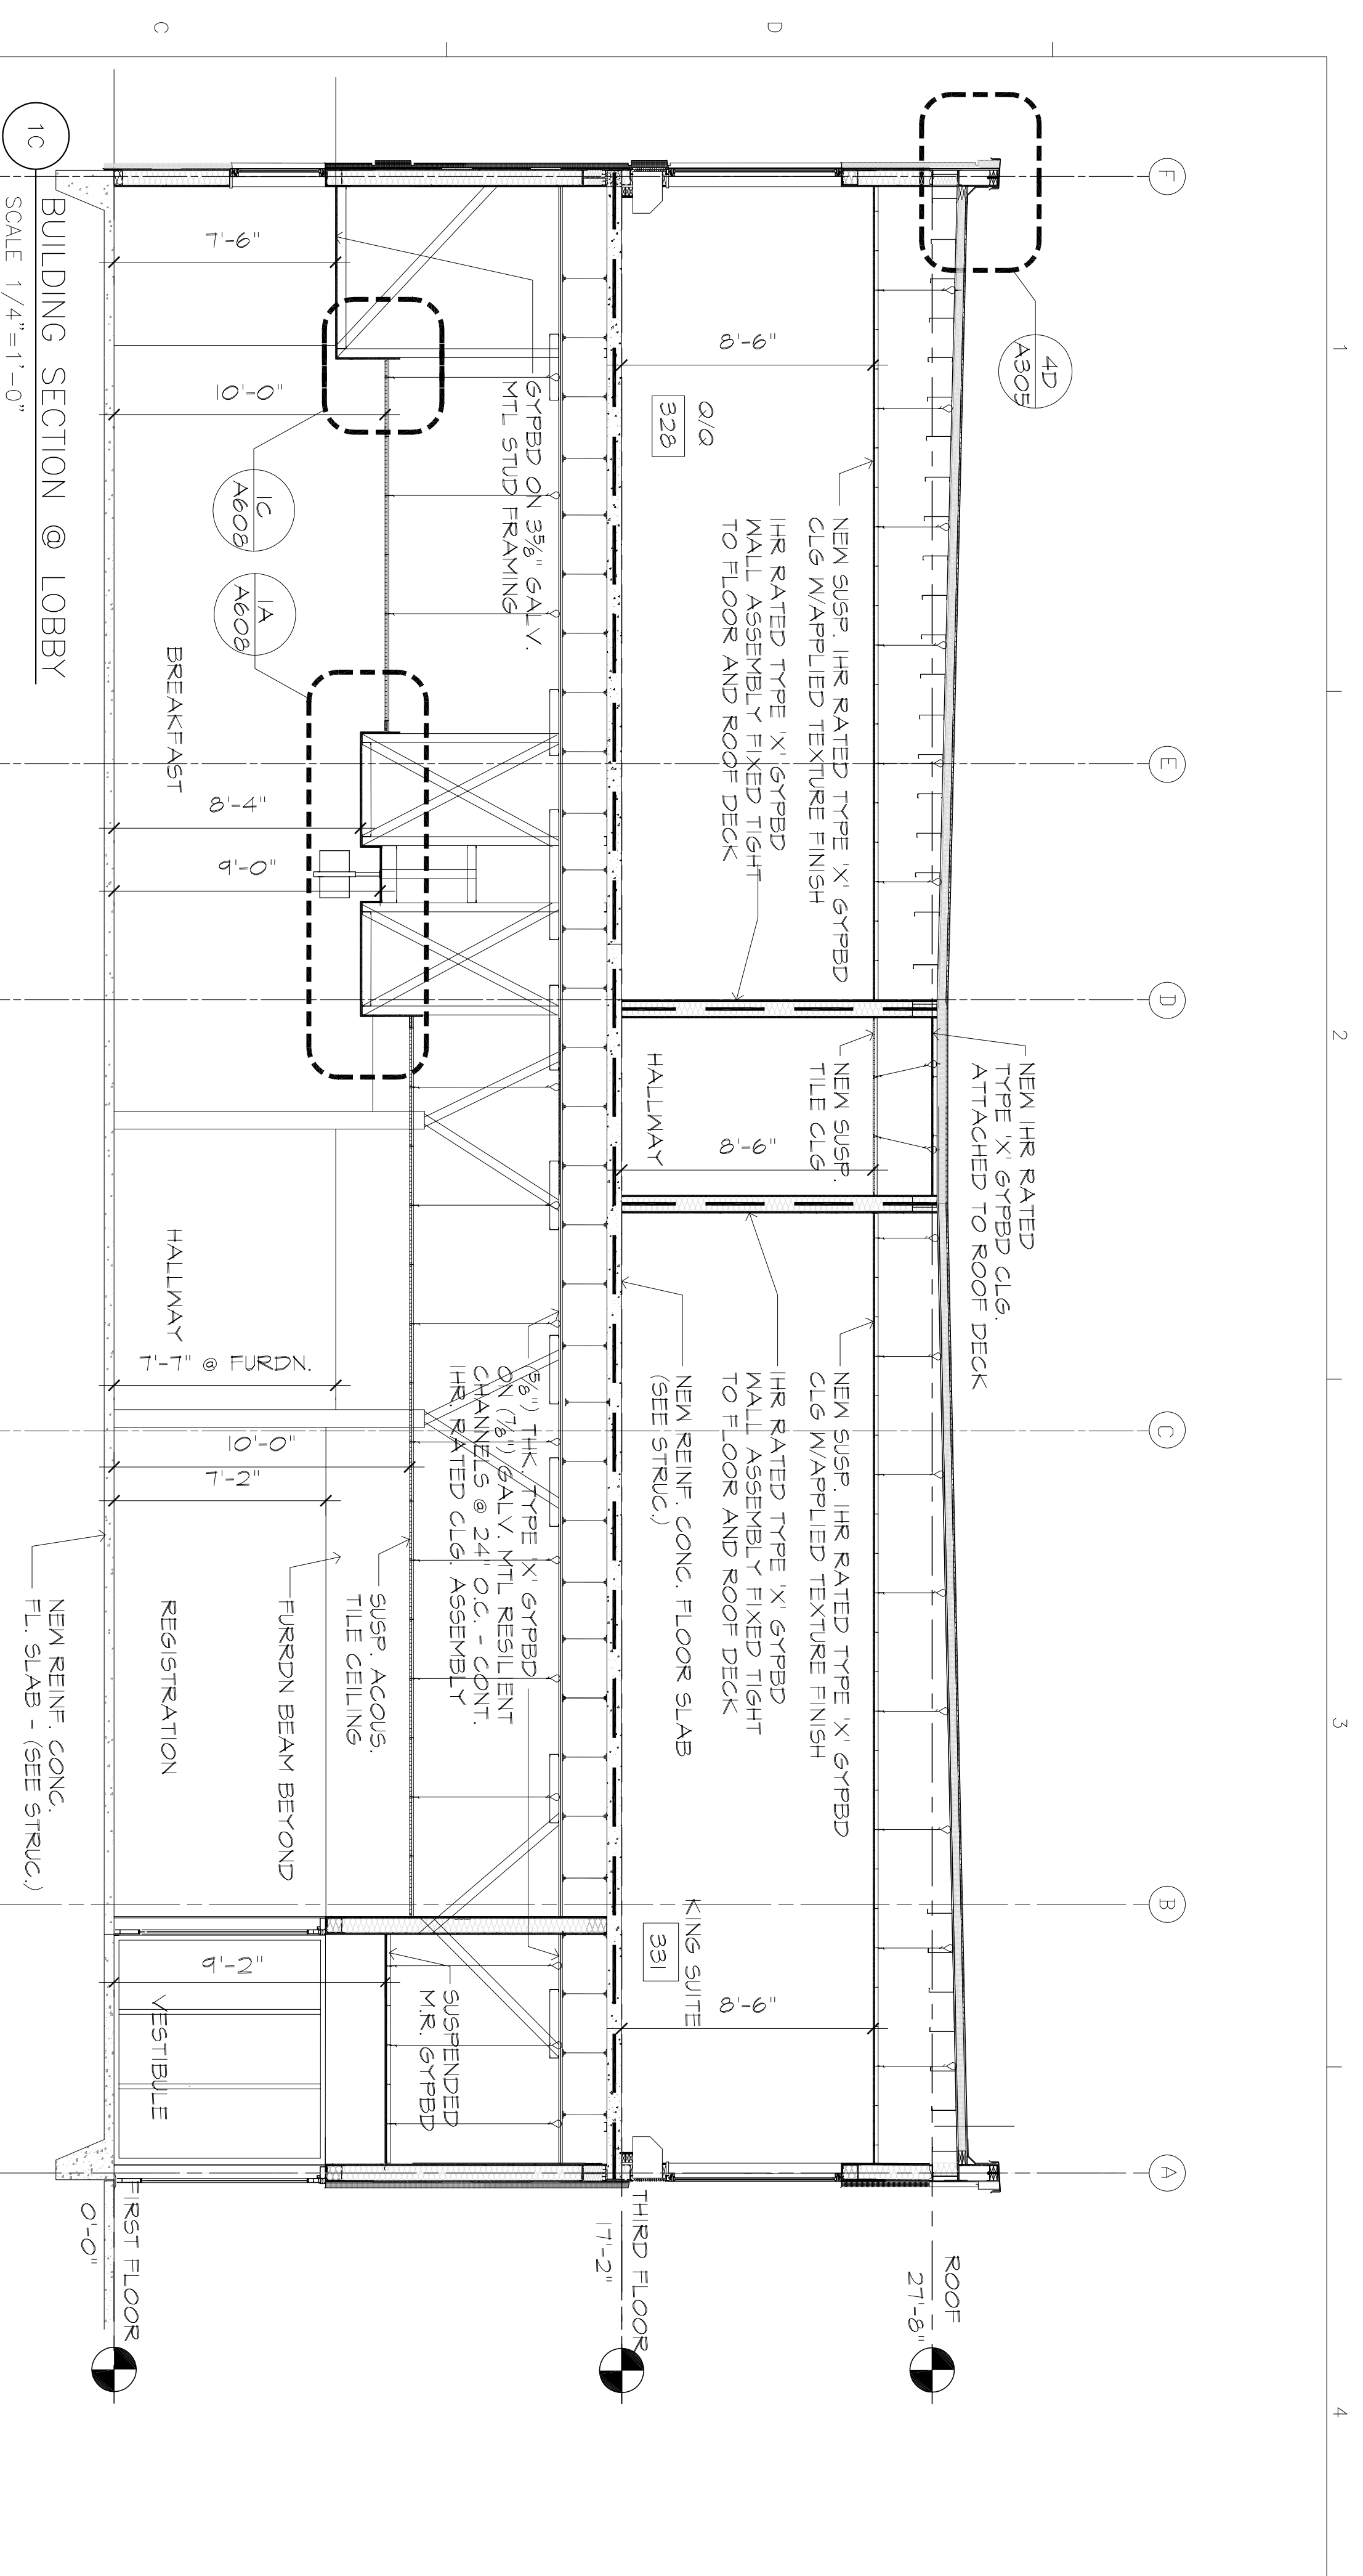

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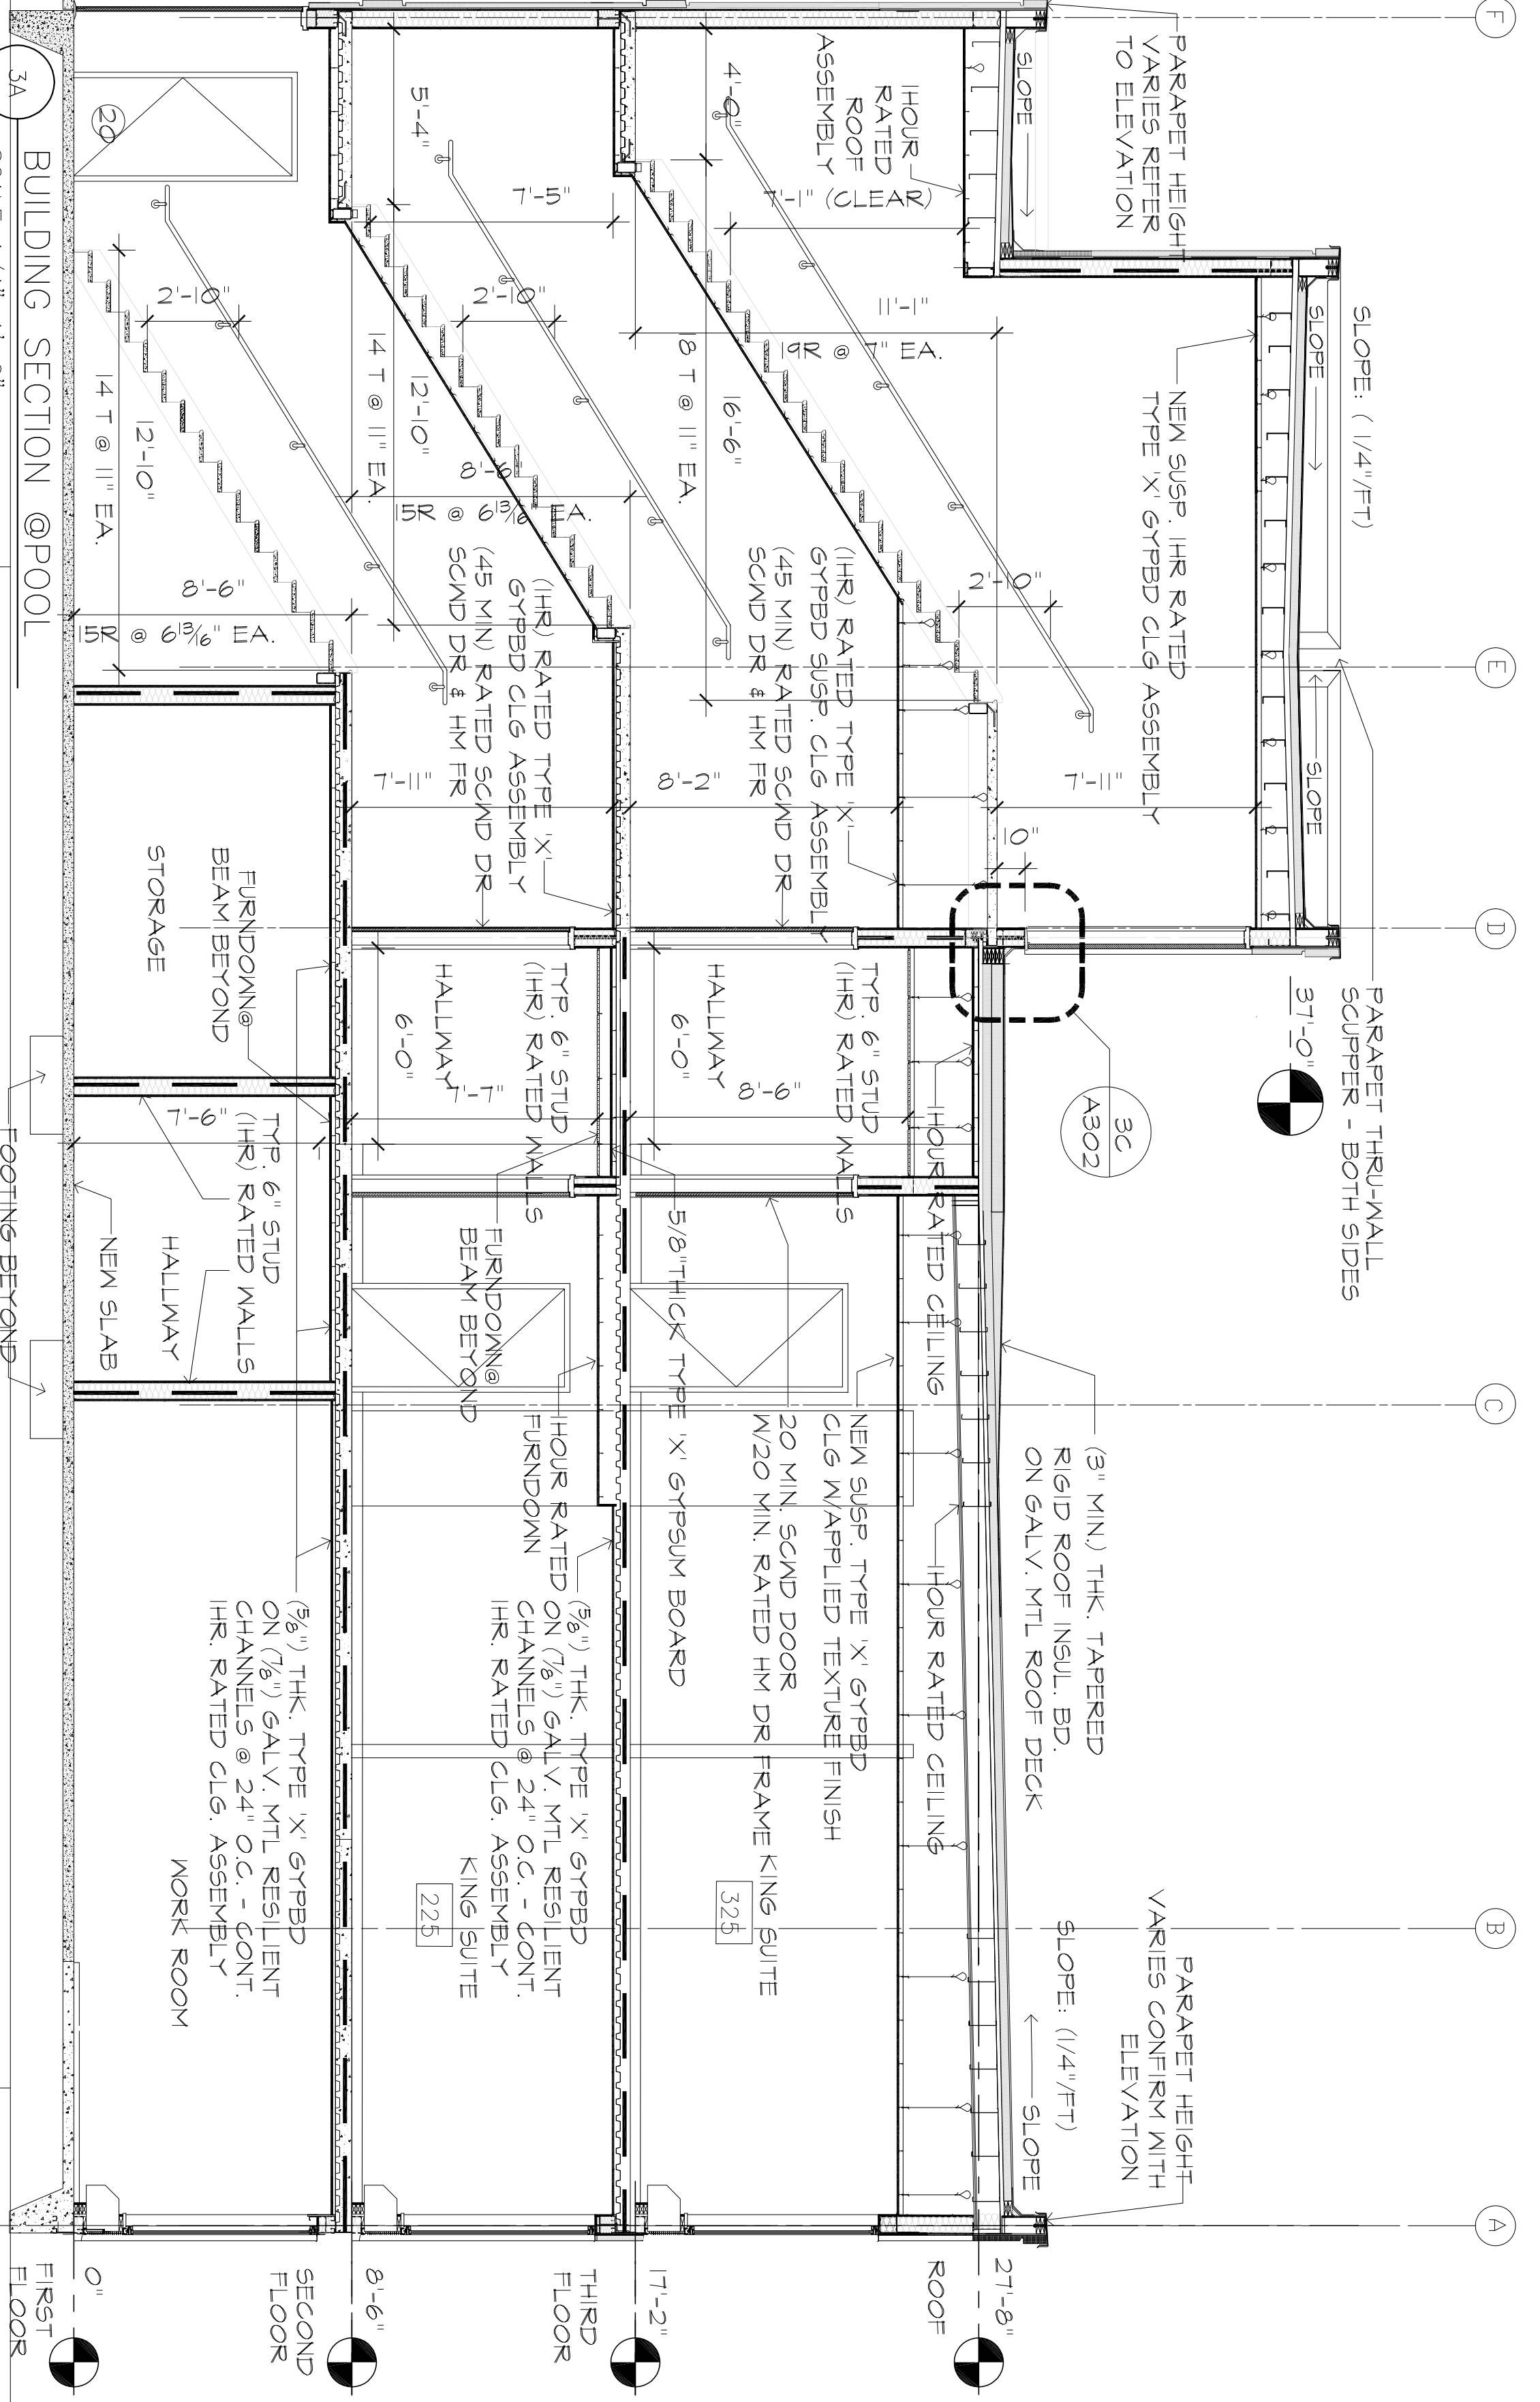
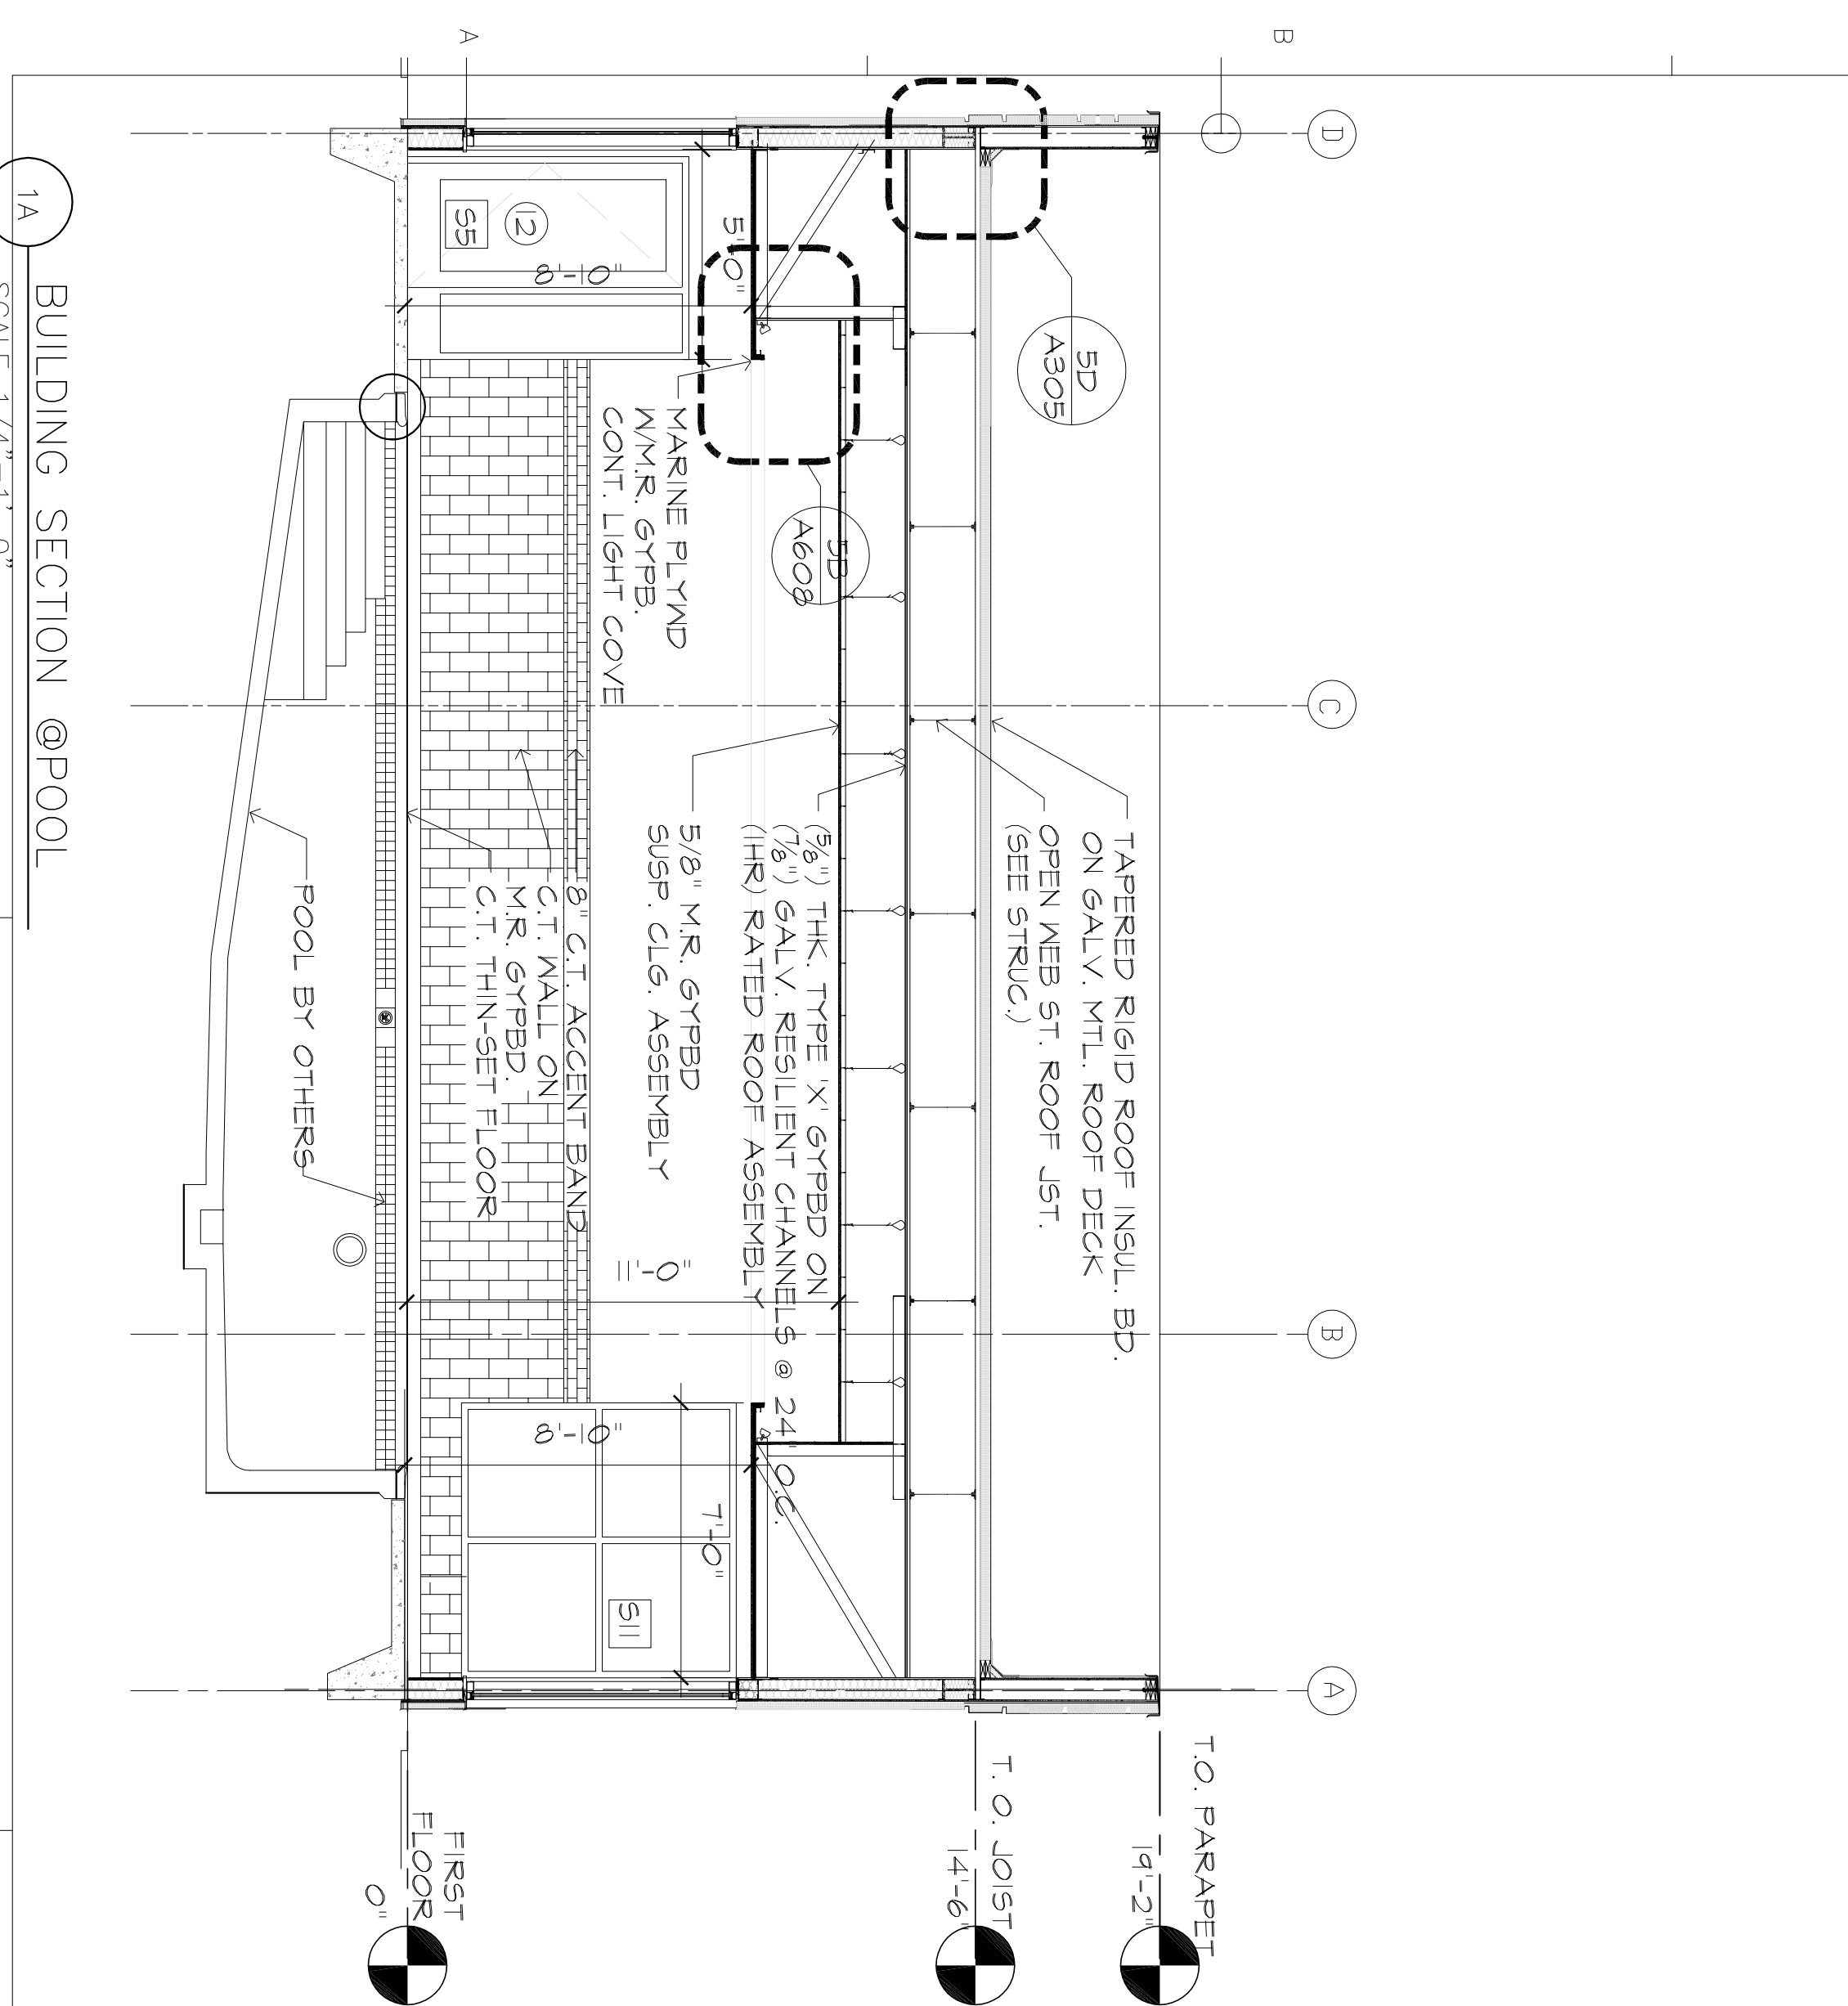
100% REVIEW SET  
 CONSTRUCTION

ISSUES & REVISIONS

NO.	DATE	DESCRIPTION
1	09/22/15	30% REVIEW SET
2	11/22/15	50% REVIEW SET
3	12/22/15	100% REVIEW SET

PROJECT NAME:  
 BUILDING SECTIONS

DRAWN BY: BNC  
 CHECKED BY: BBC  
 DATE: 12-22-15  
 SCALE: AS NOTED  
 DRAWING NUMBER: A302



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ISSUES & REVISIONS

NO.	DATE	DESCRIPTION
1	09/22/15	30% REVIEW SET
2	11/22/15	50% REVIEW SET
3	12/22/15	100% REVIEW SET

PROJECT NAME:  
 BUILDING SECTIONS

DRAWN BY: BNC  
 CHECKED BY: BBC  
 DATE: 12-22-15  
 SCALE: AS NOTED  
 DRAWING NUMBER: A302

1A SCALE 1/4"=1'-0"  
 1C SCALE 1/4"=1'-0"  
 3A SCALE 1/4"=1'-0"  
 3C SCALE 1"=1'-0"

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3	12/22/2015	100% REVIEW SET

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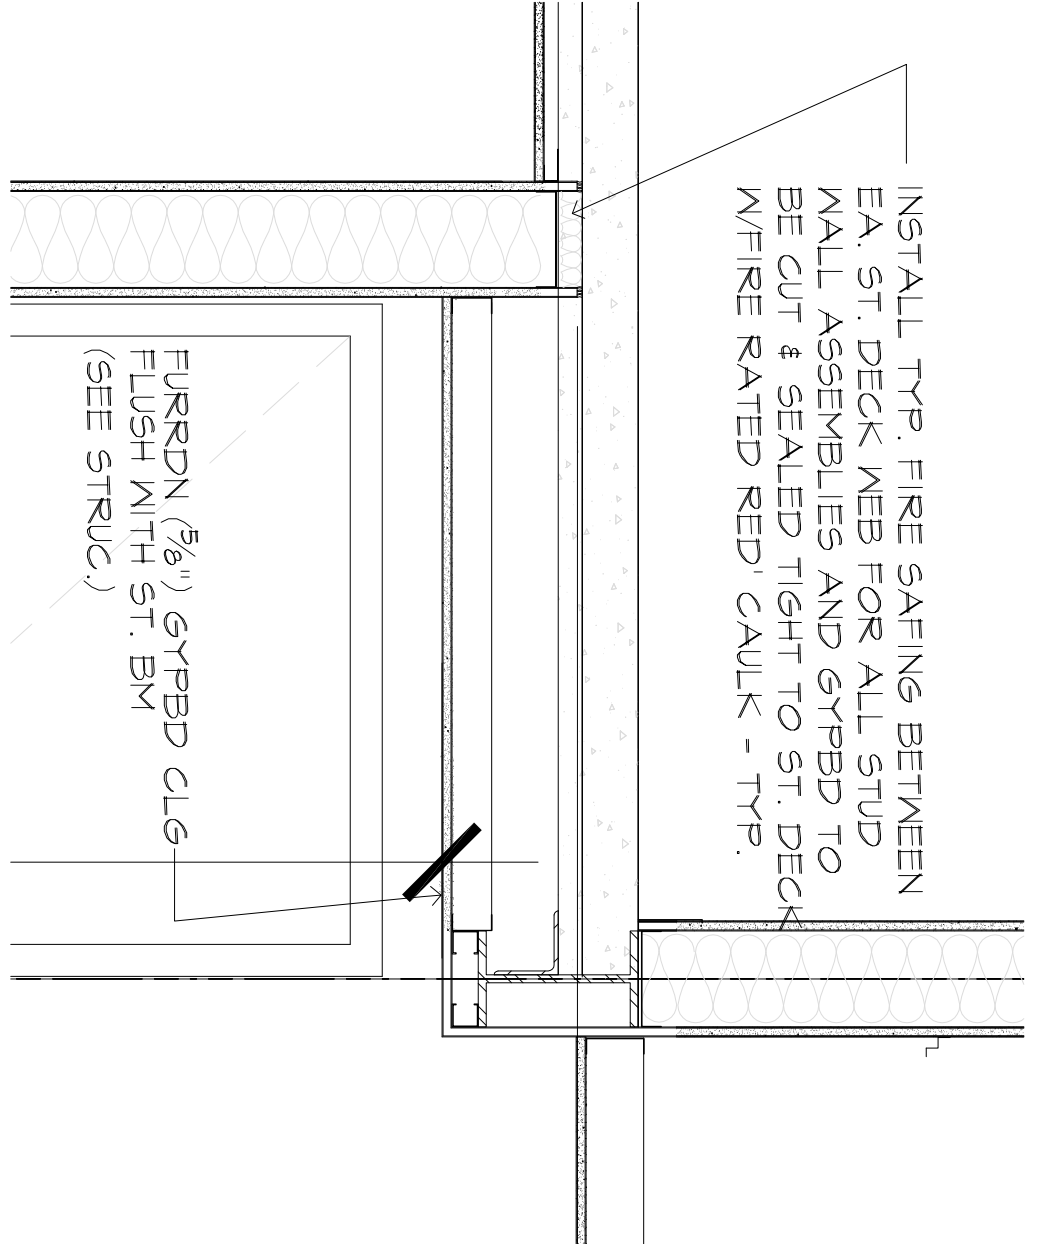
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PROJECT NUMBER: 15180


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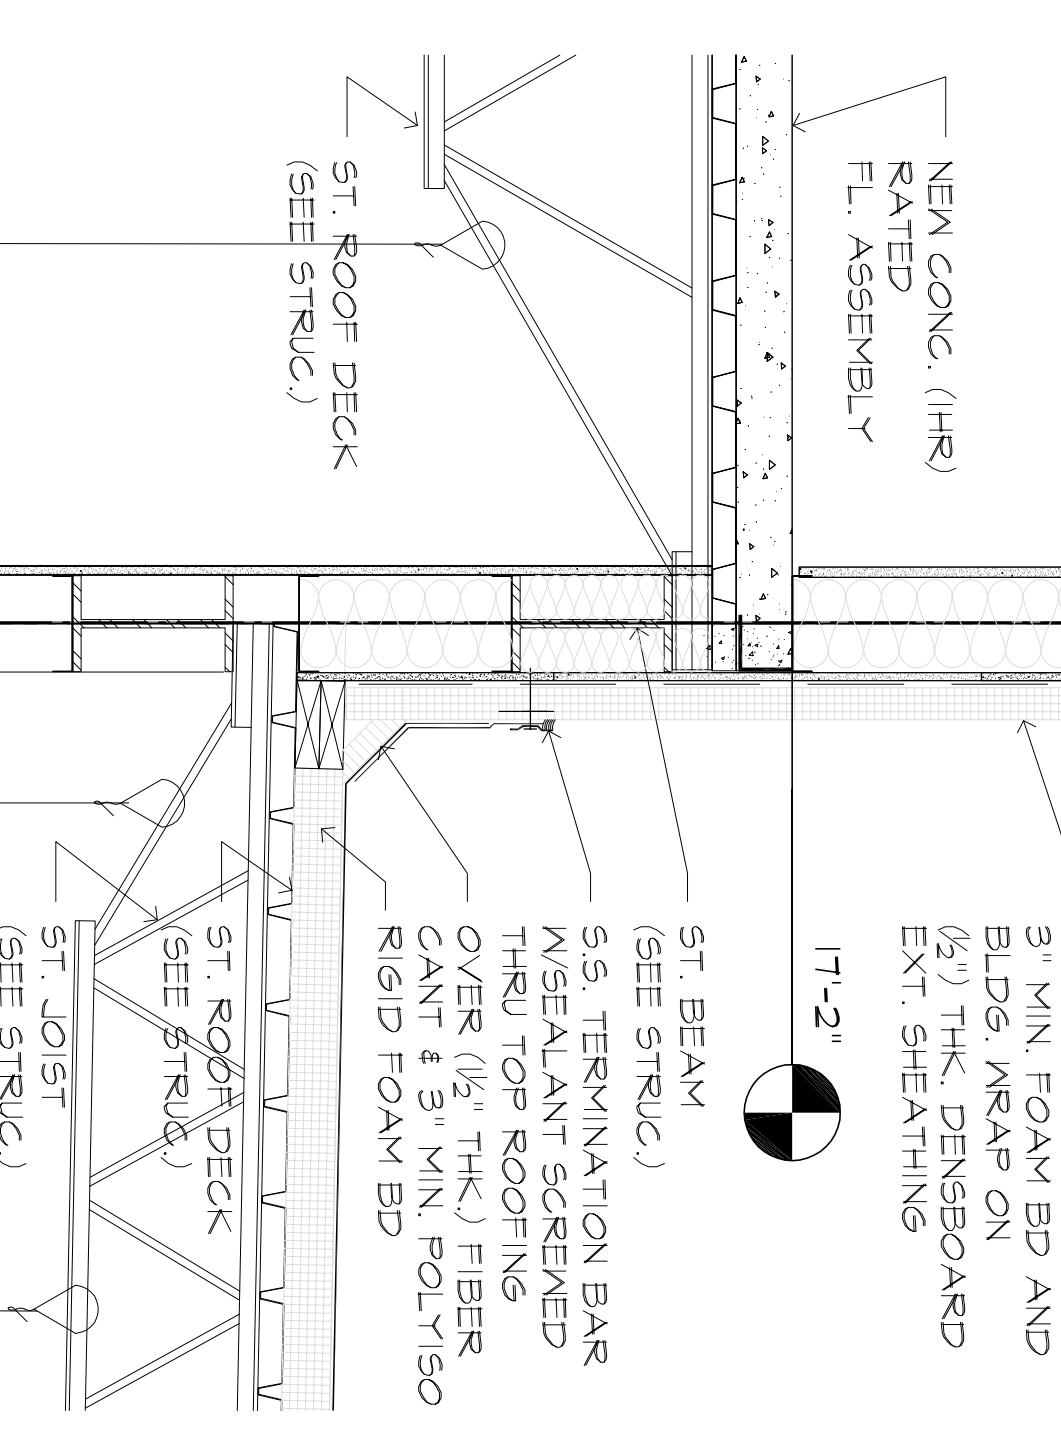
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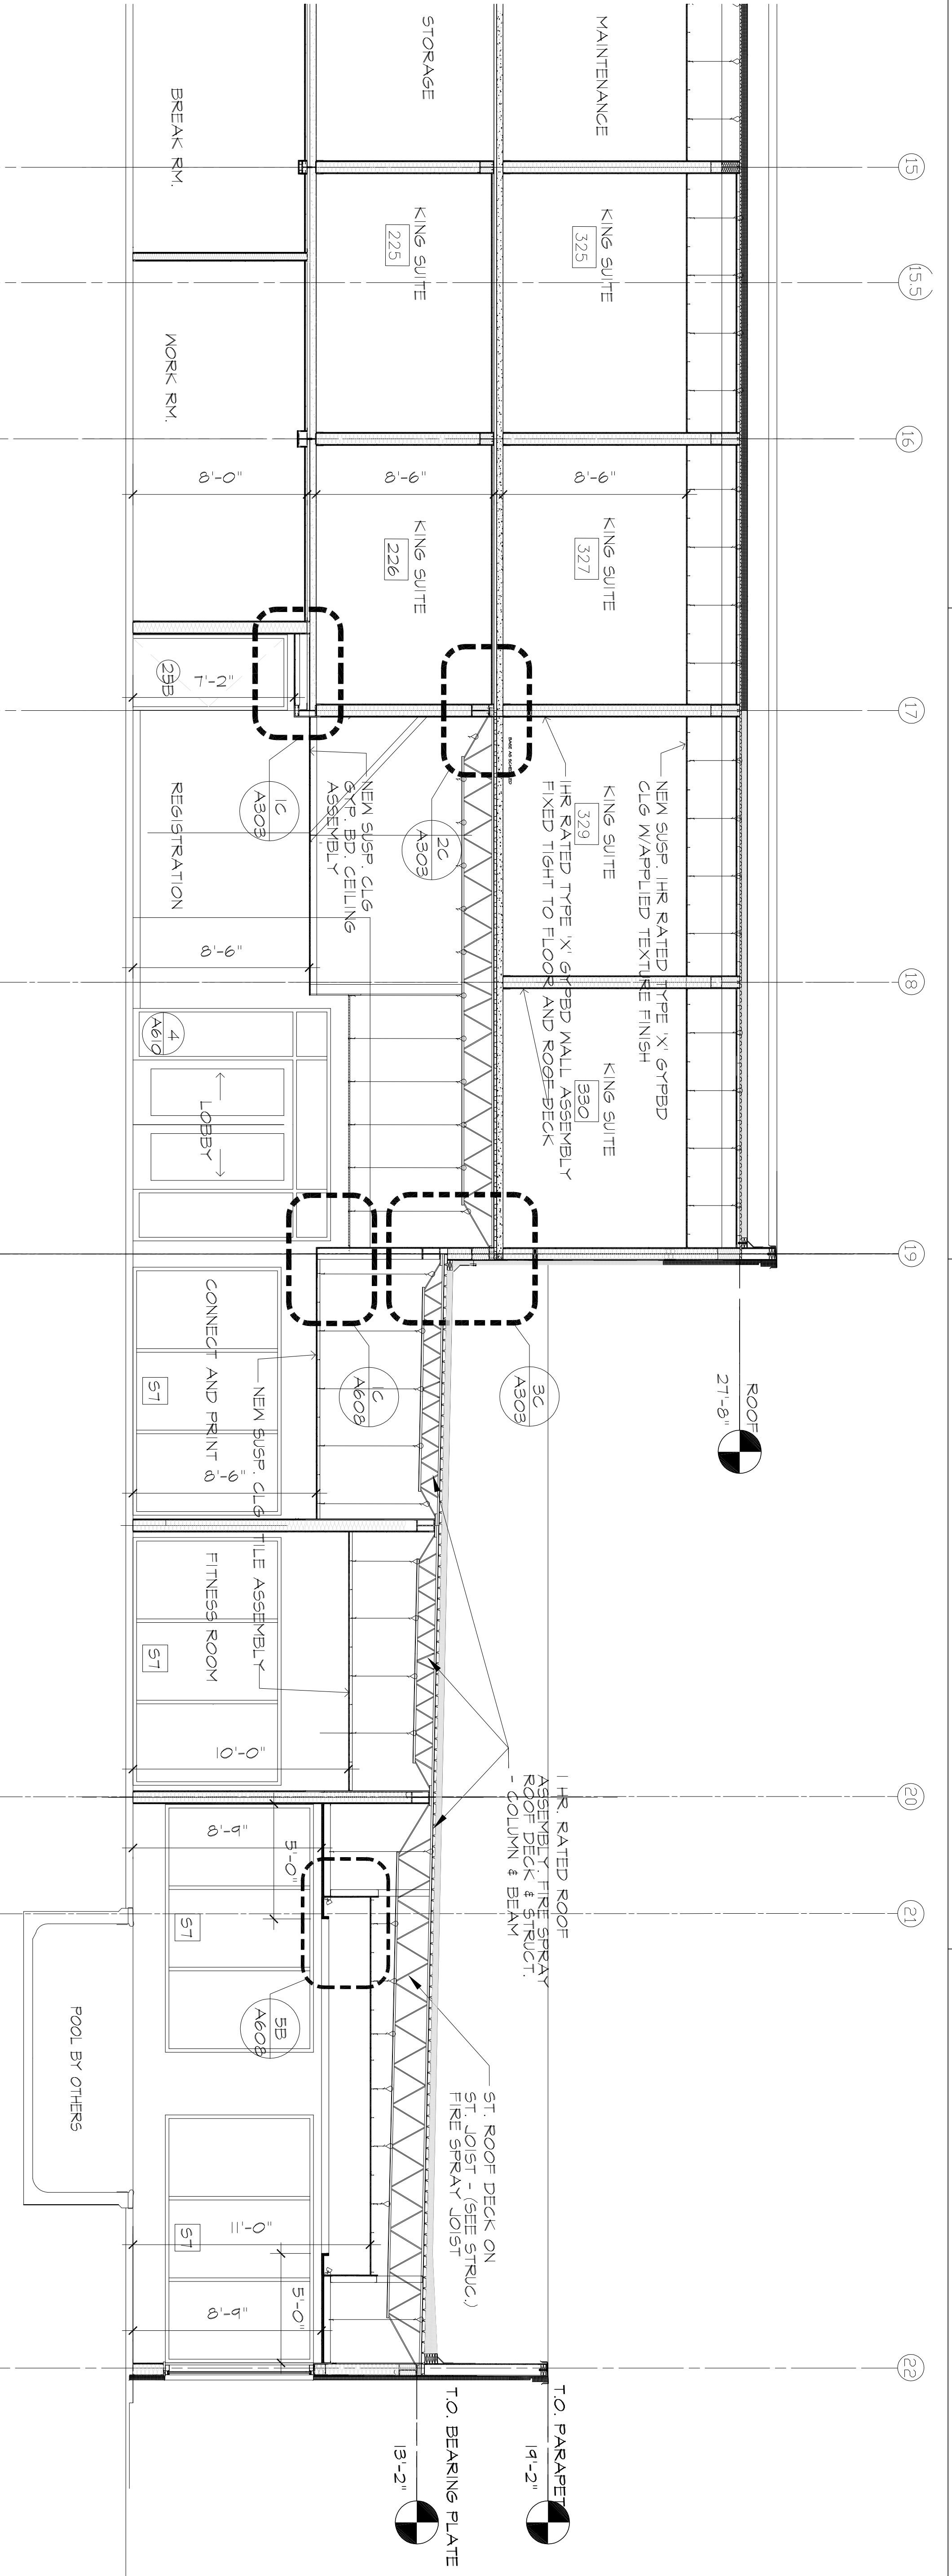
1C DETAIL  
 SCALE 1"=1'-0"



2C DETAIL  
 SCALE 1"=1'-0"



3C DETAIL  
 SCALE 1"=1'-0"

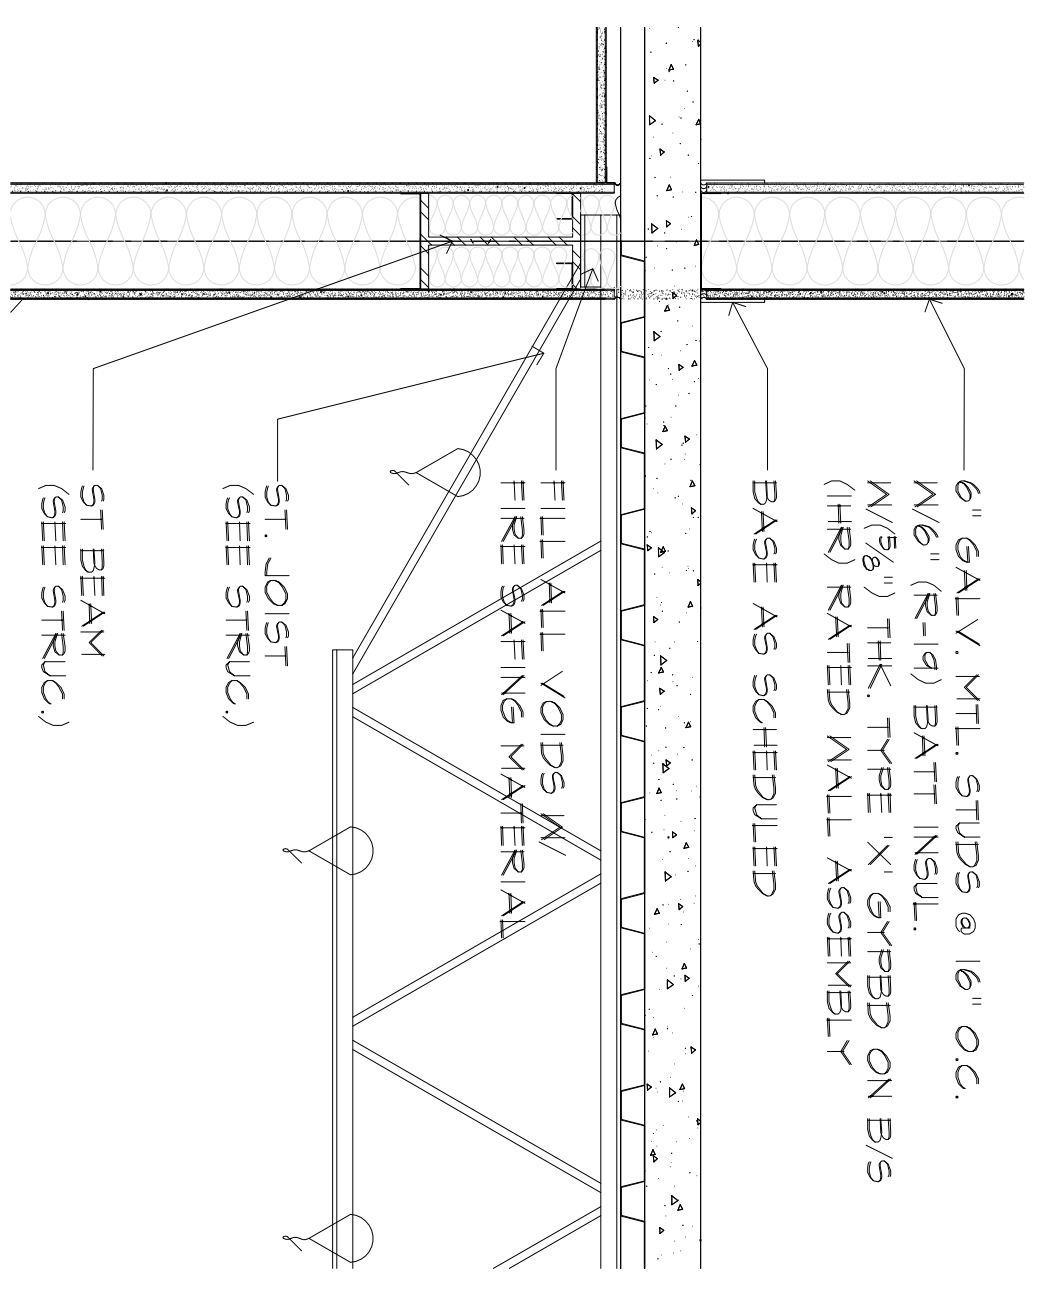

1A BUILDING SECTION @ LOBBY  
 SCALE 1/4"=1'-0"

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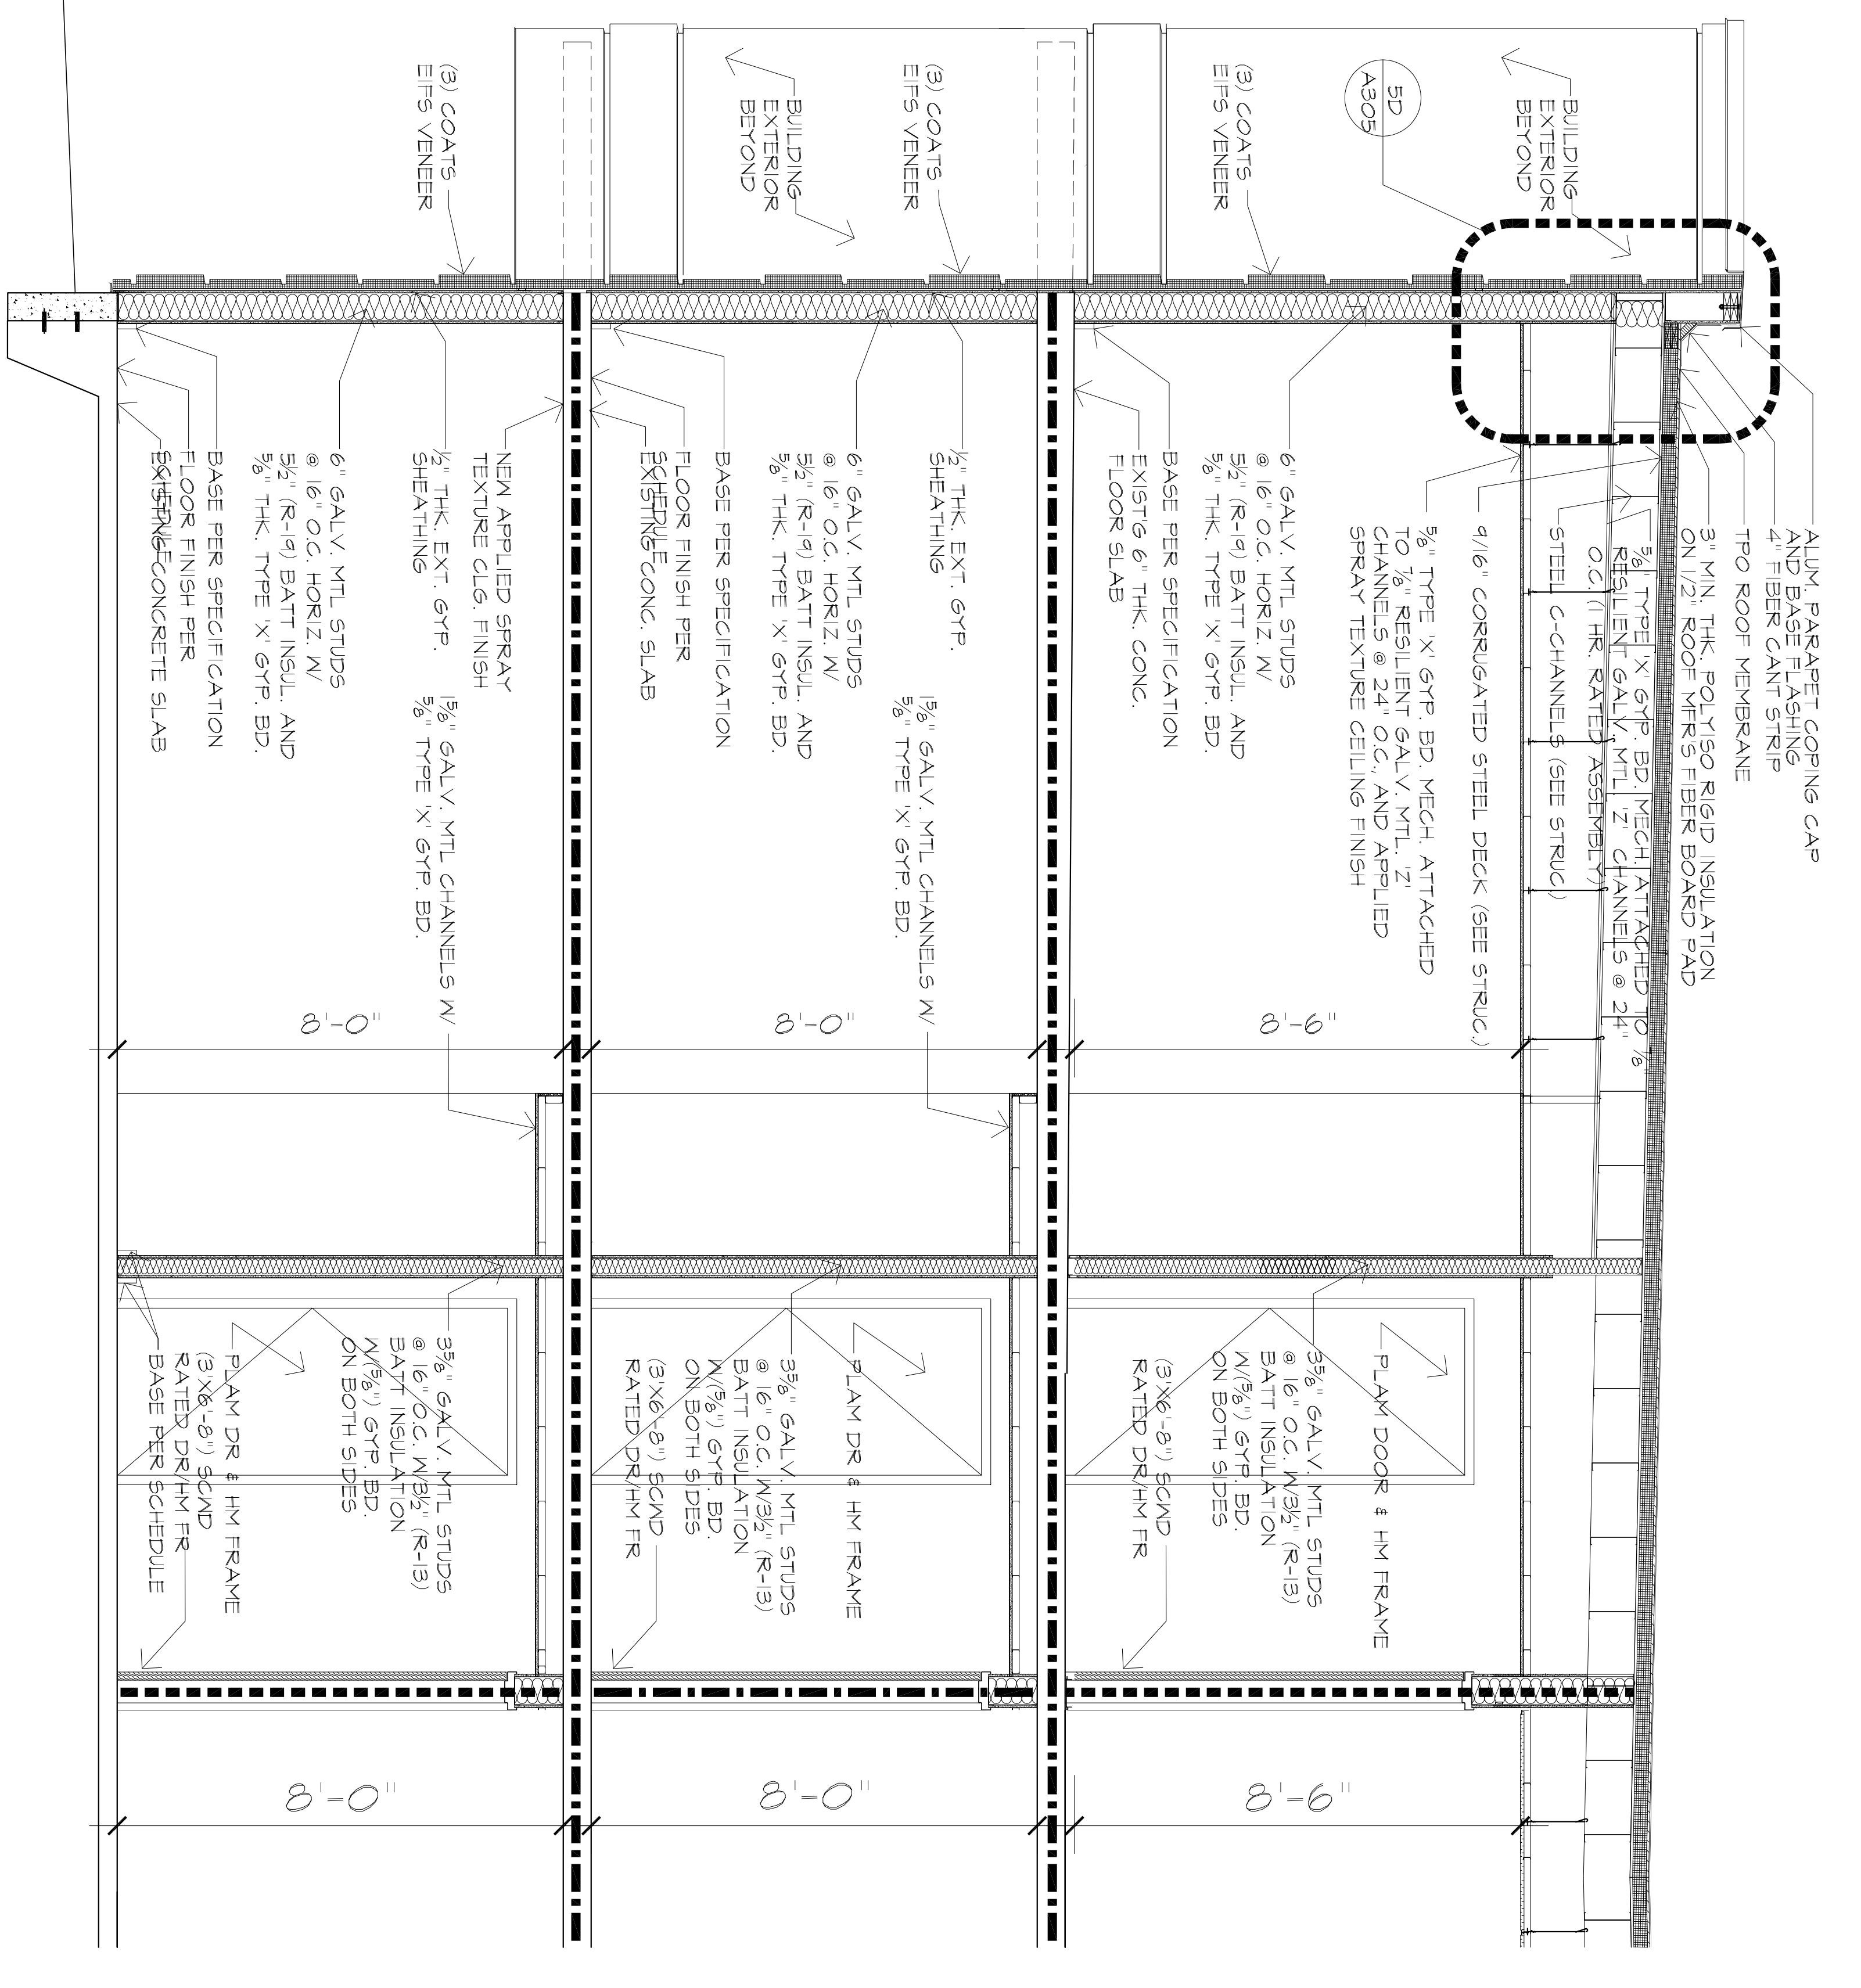
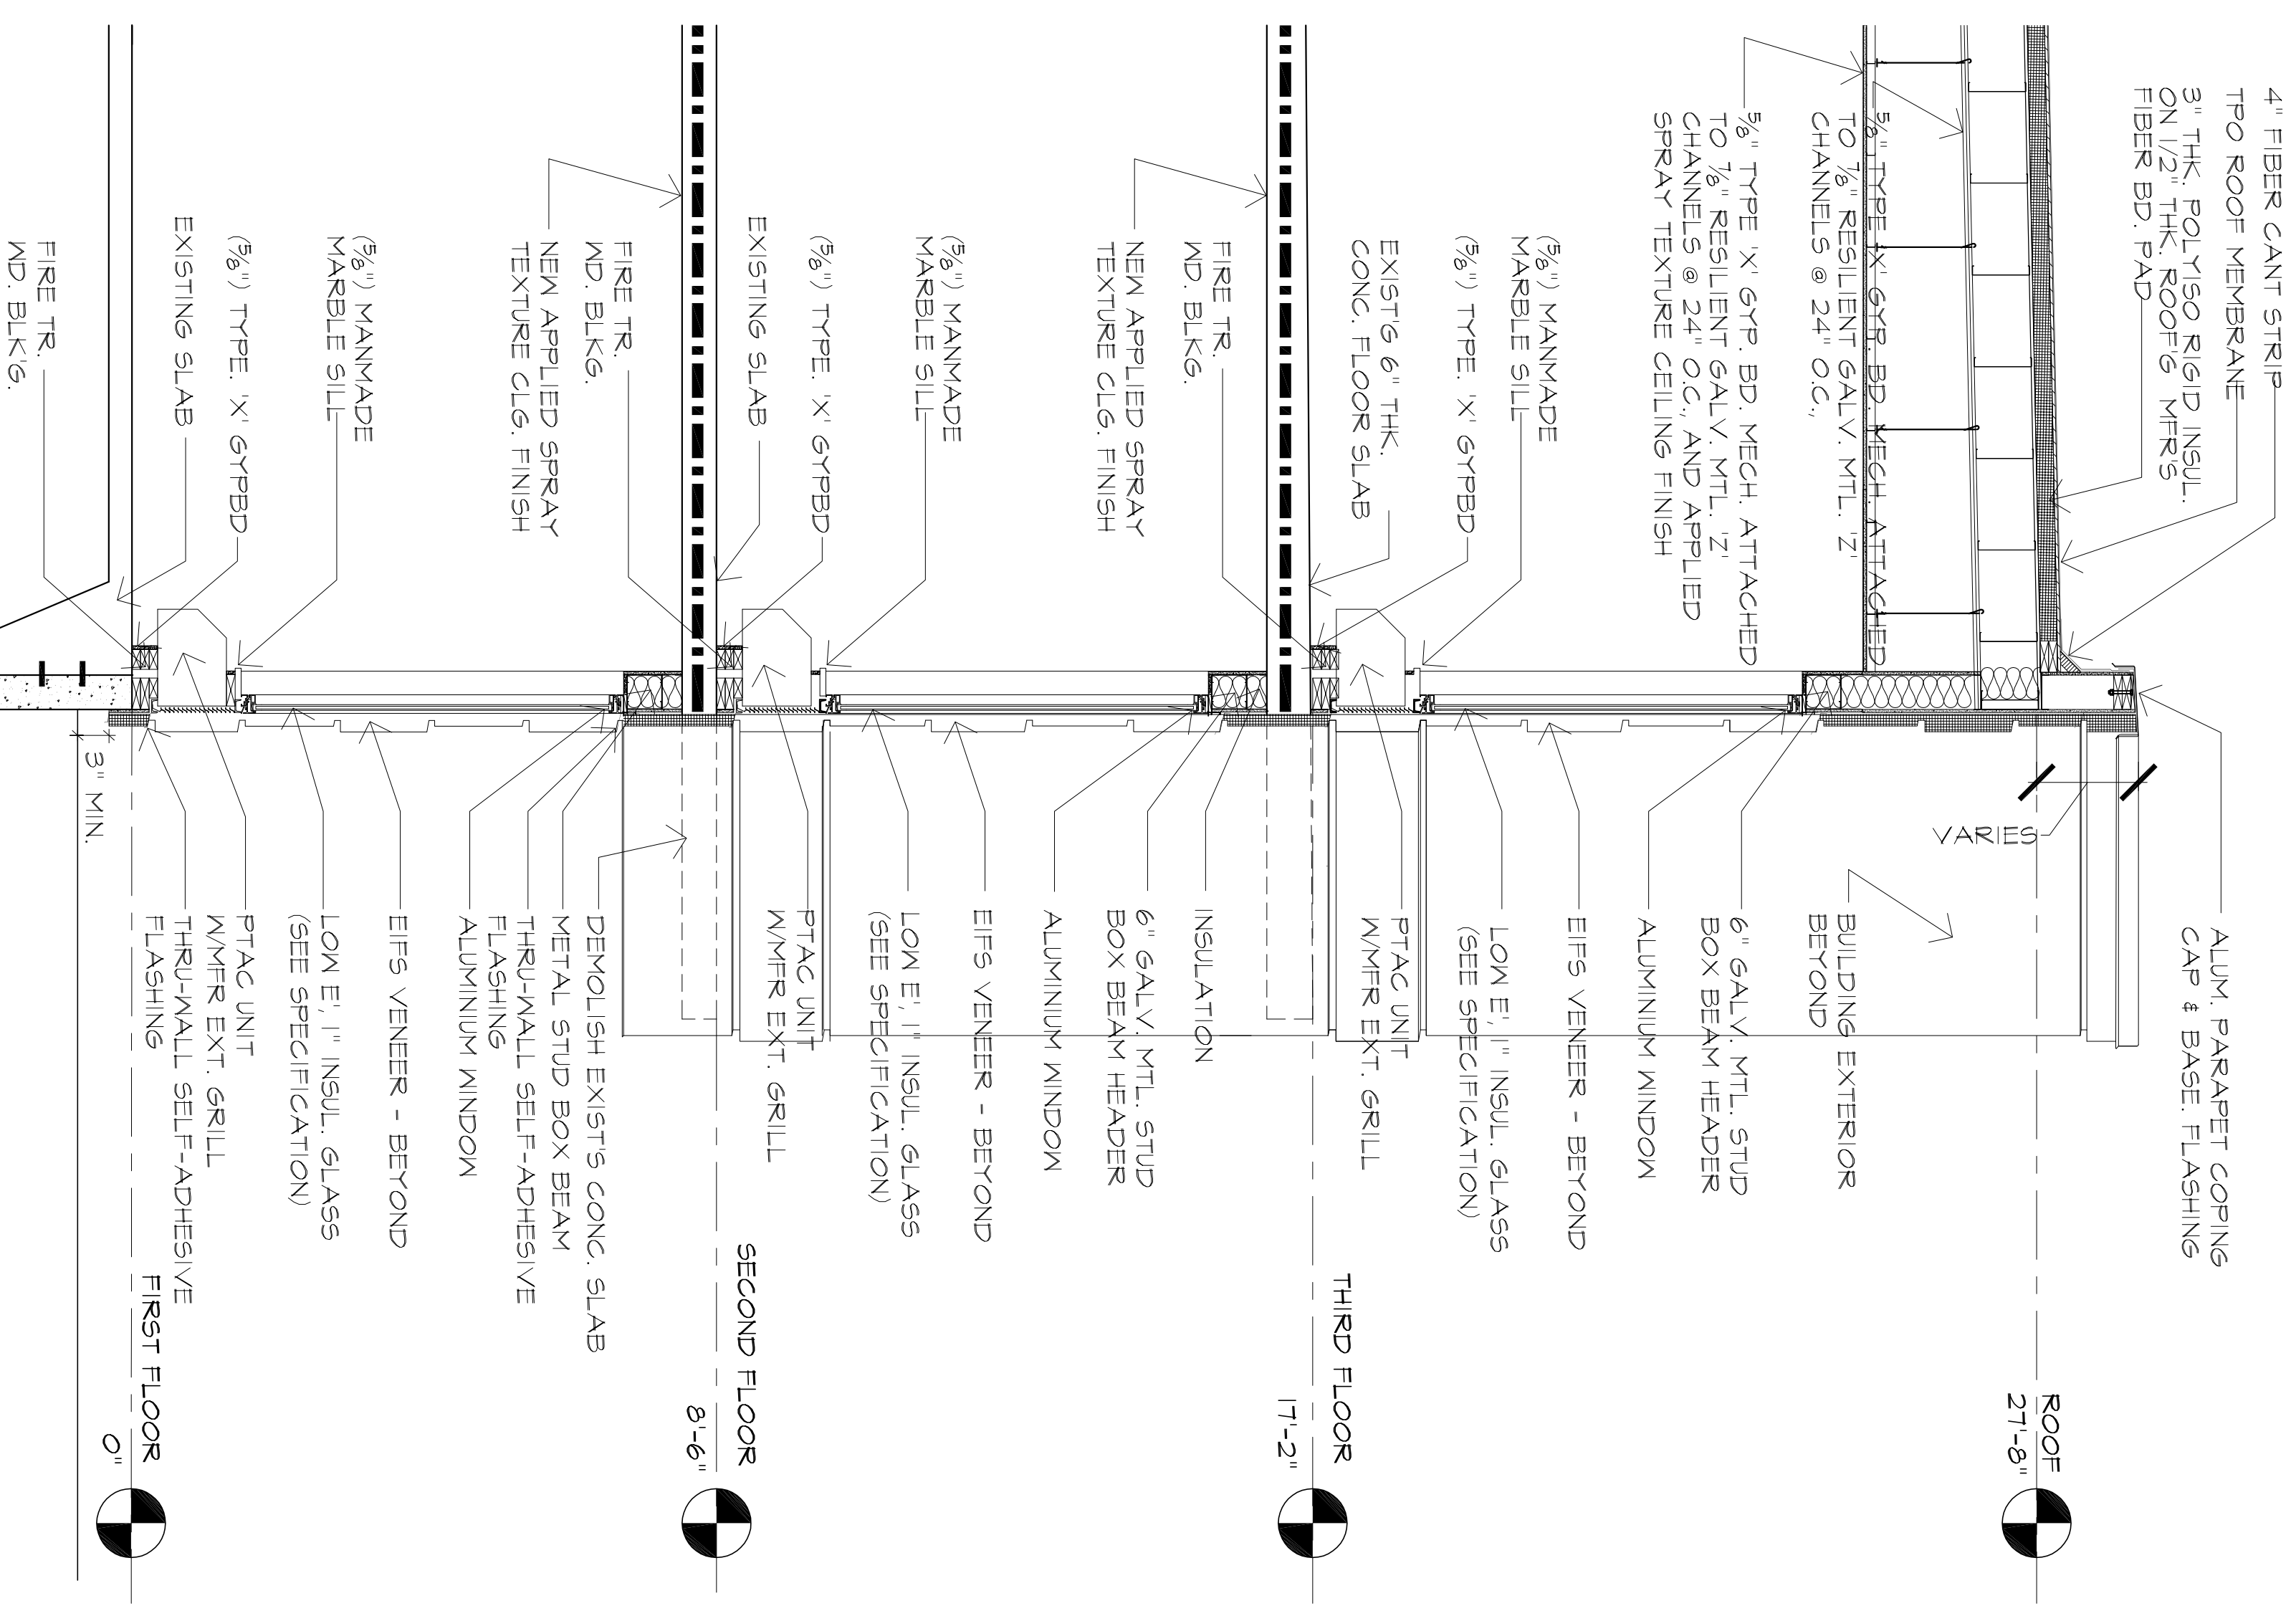
NO.	DATE	DESCRIPTION
1	08/20/14	CODE SUBMITTAL

ISSUES & REVISIONS

NO.	DATE	DESCRIPTION

PROJECT NAME:  
 SHEET NAME:  
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DRAWN BY: NK  
 CHECKED BY: BRC/ANK  
 DATE: 7-30-14  
 SCALE: AS NOTED  
 DRAWING NUMBER: A304



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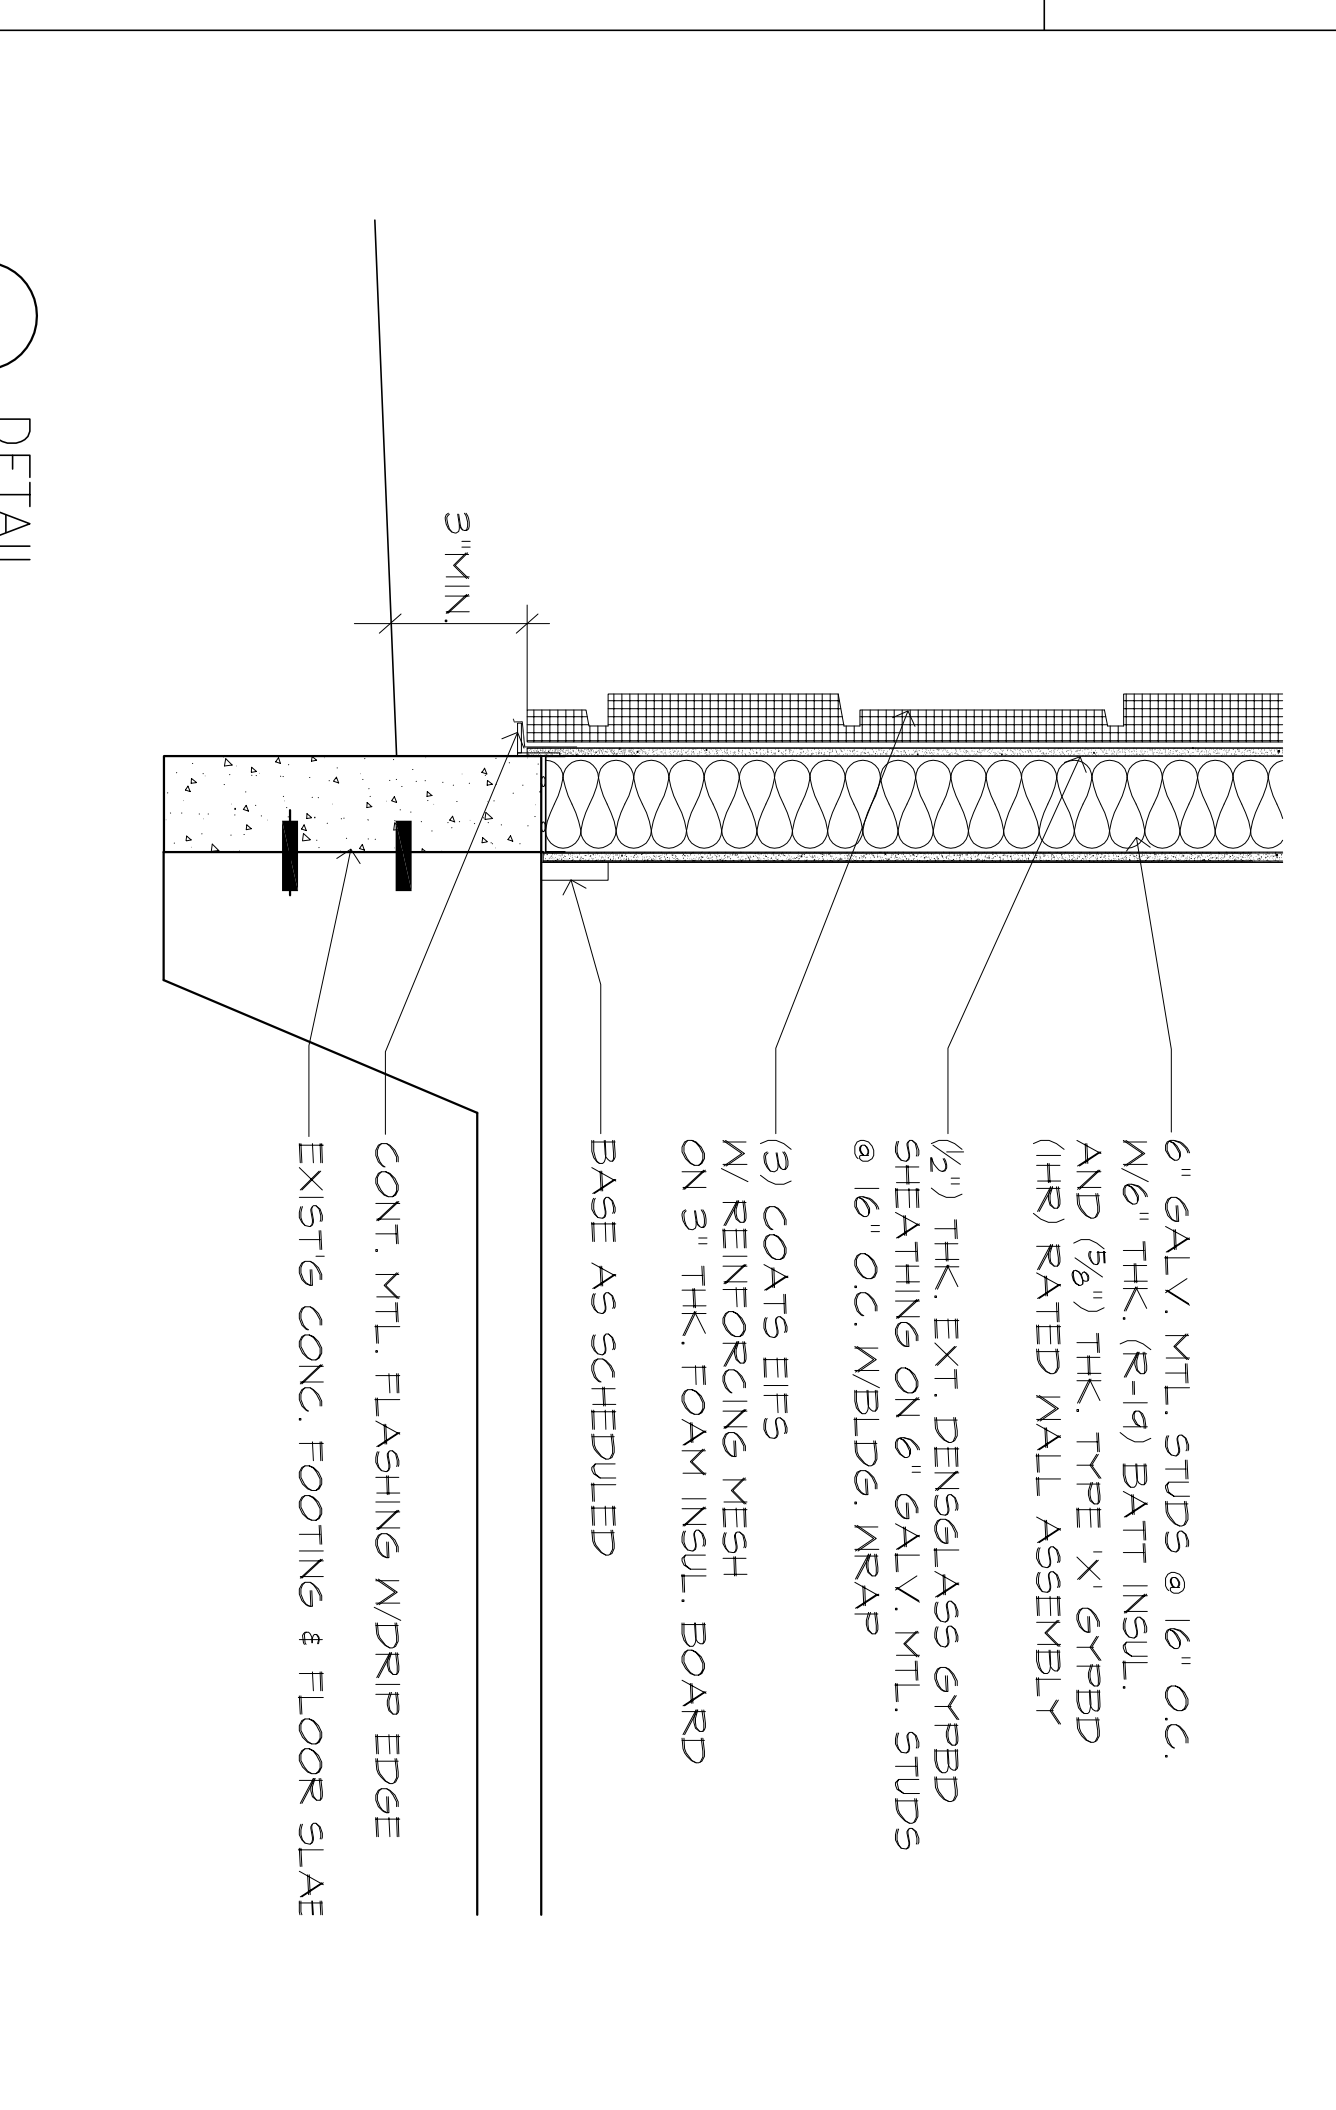
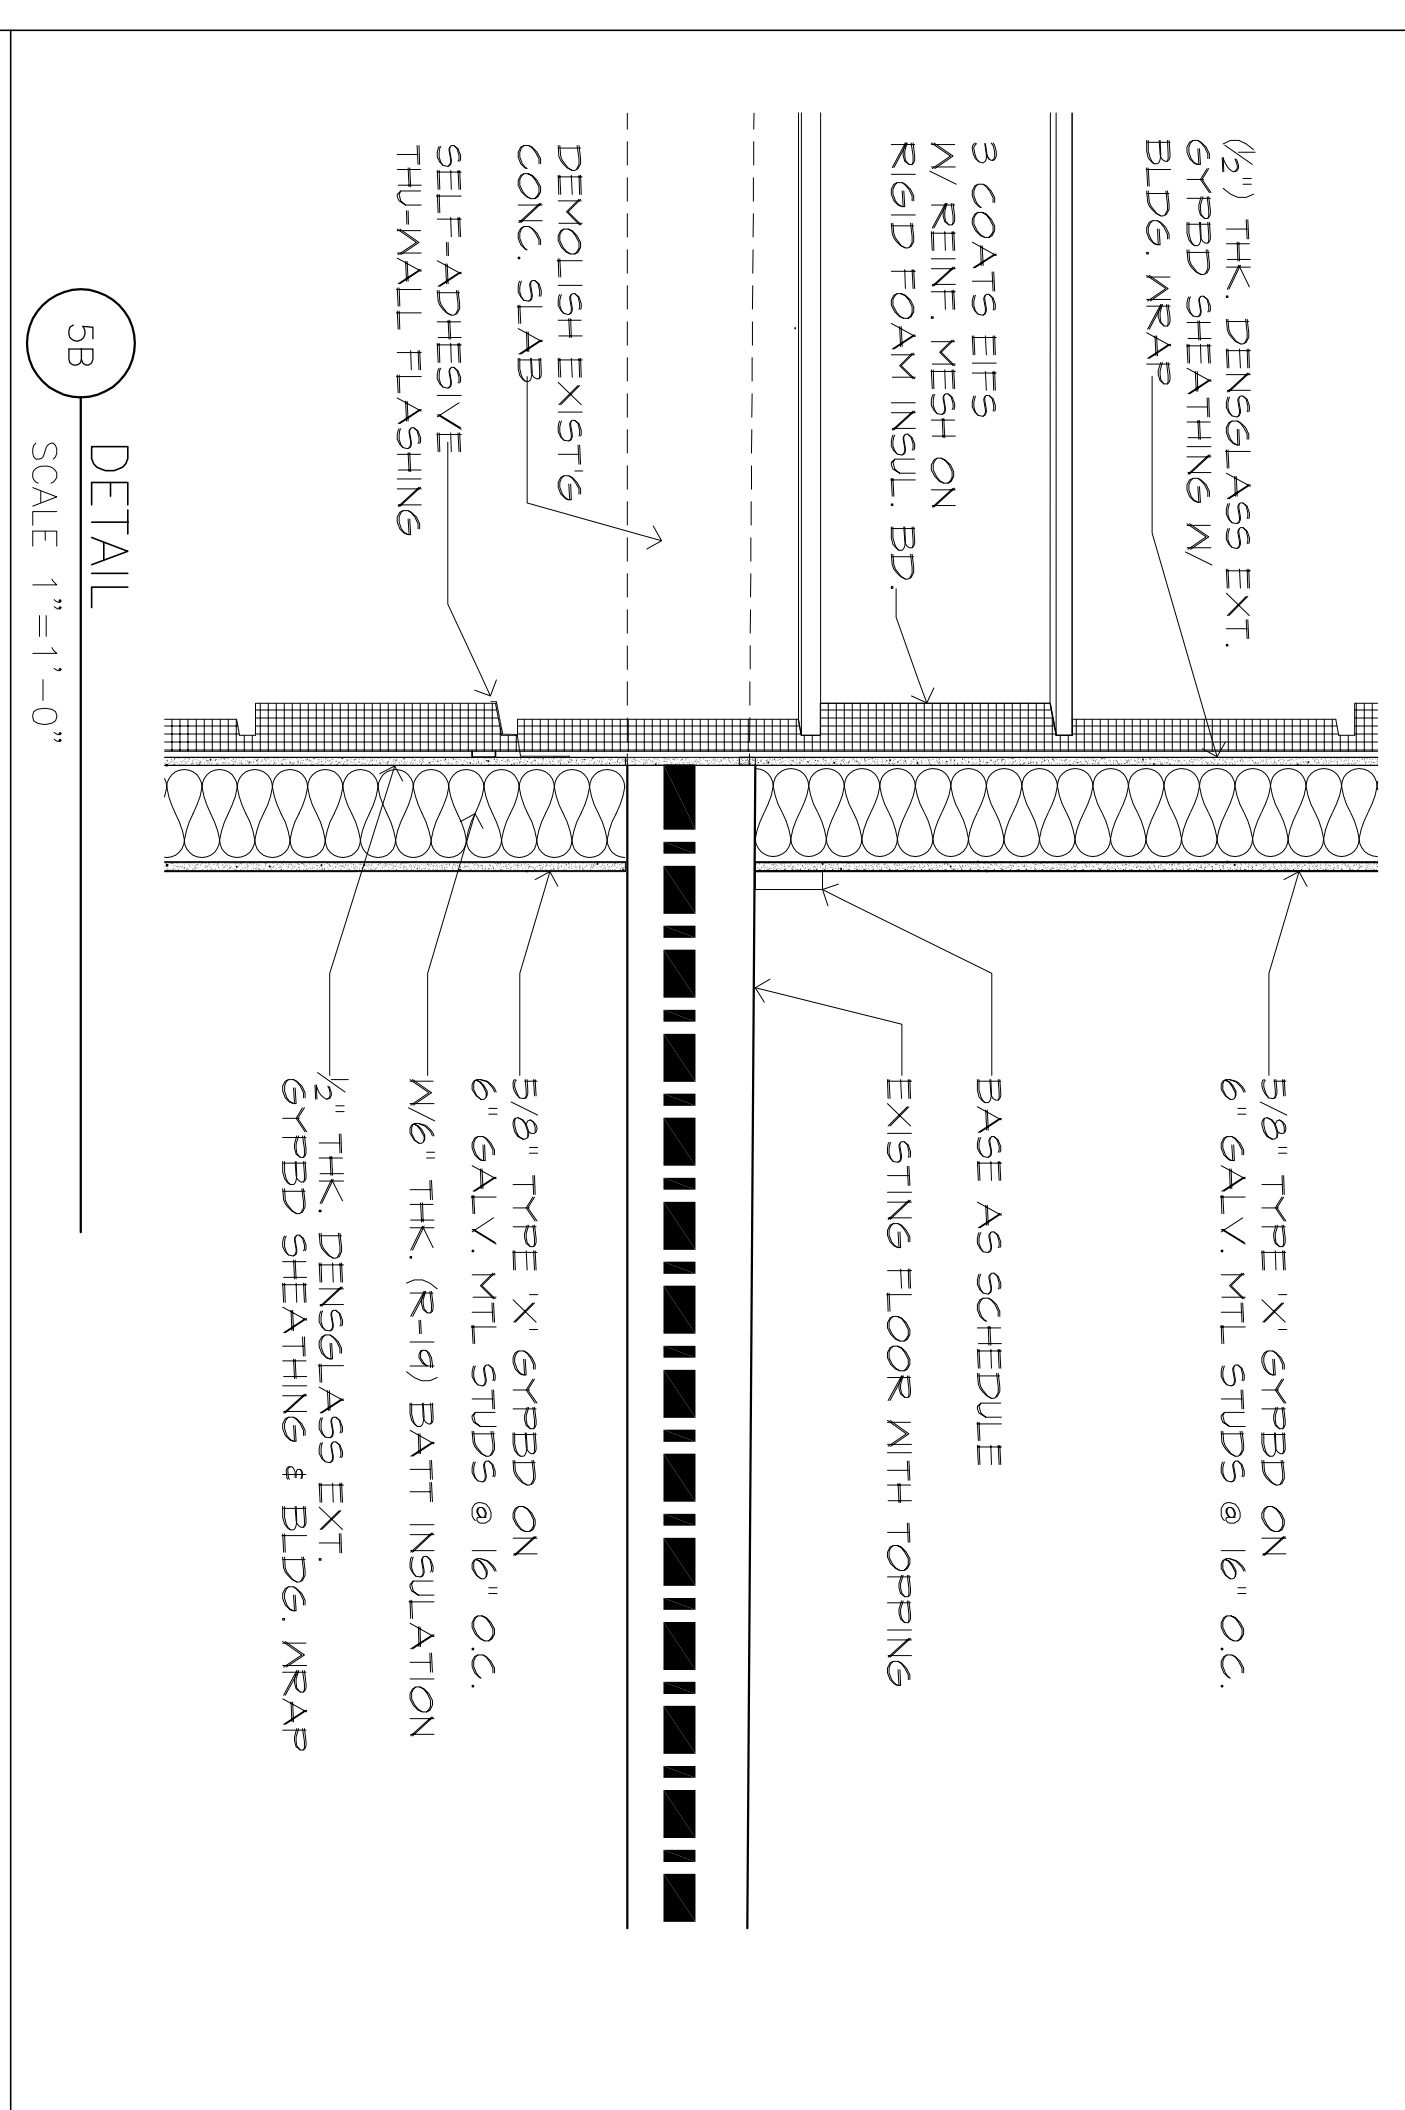
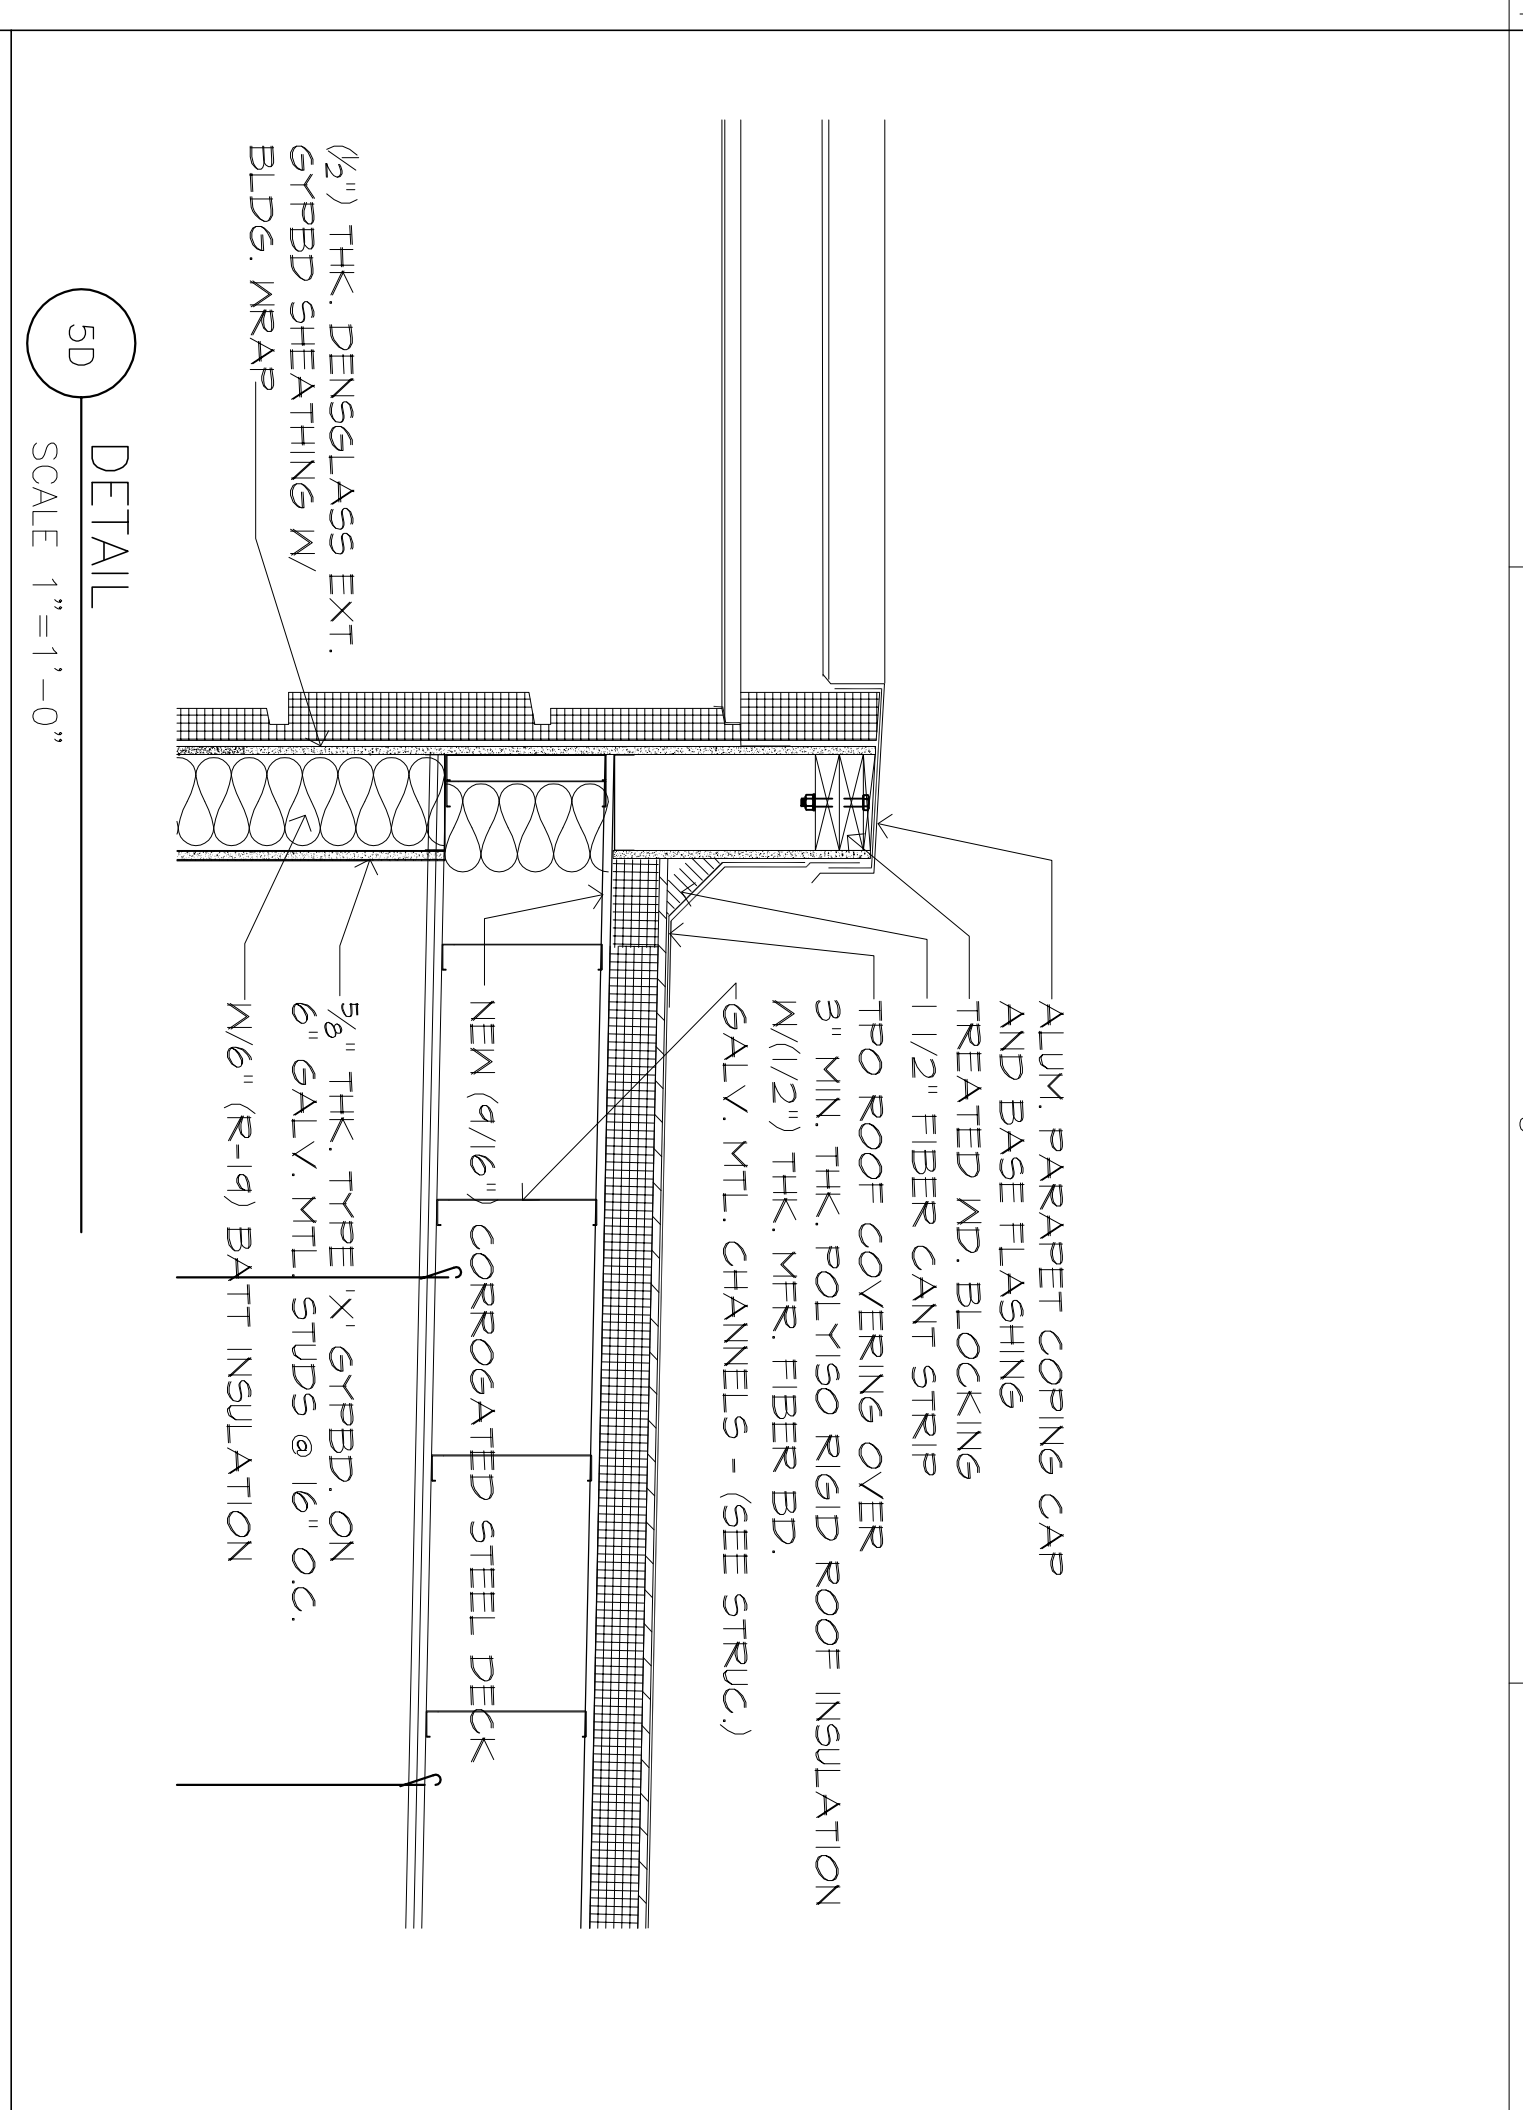
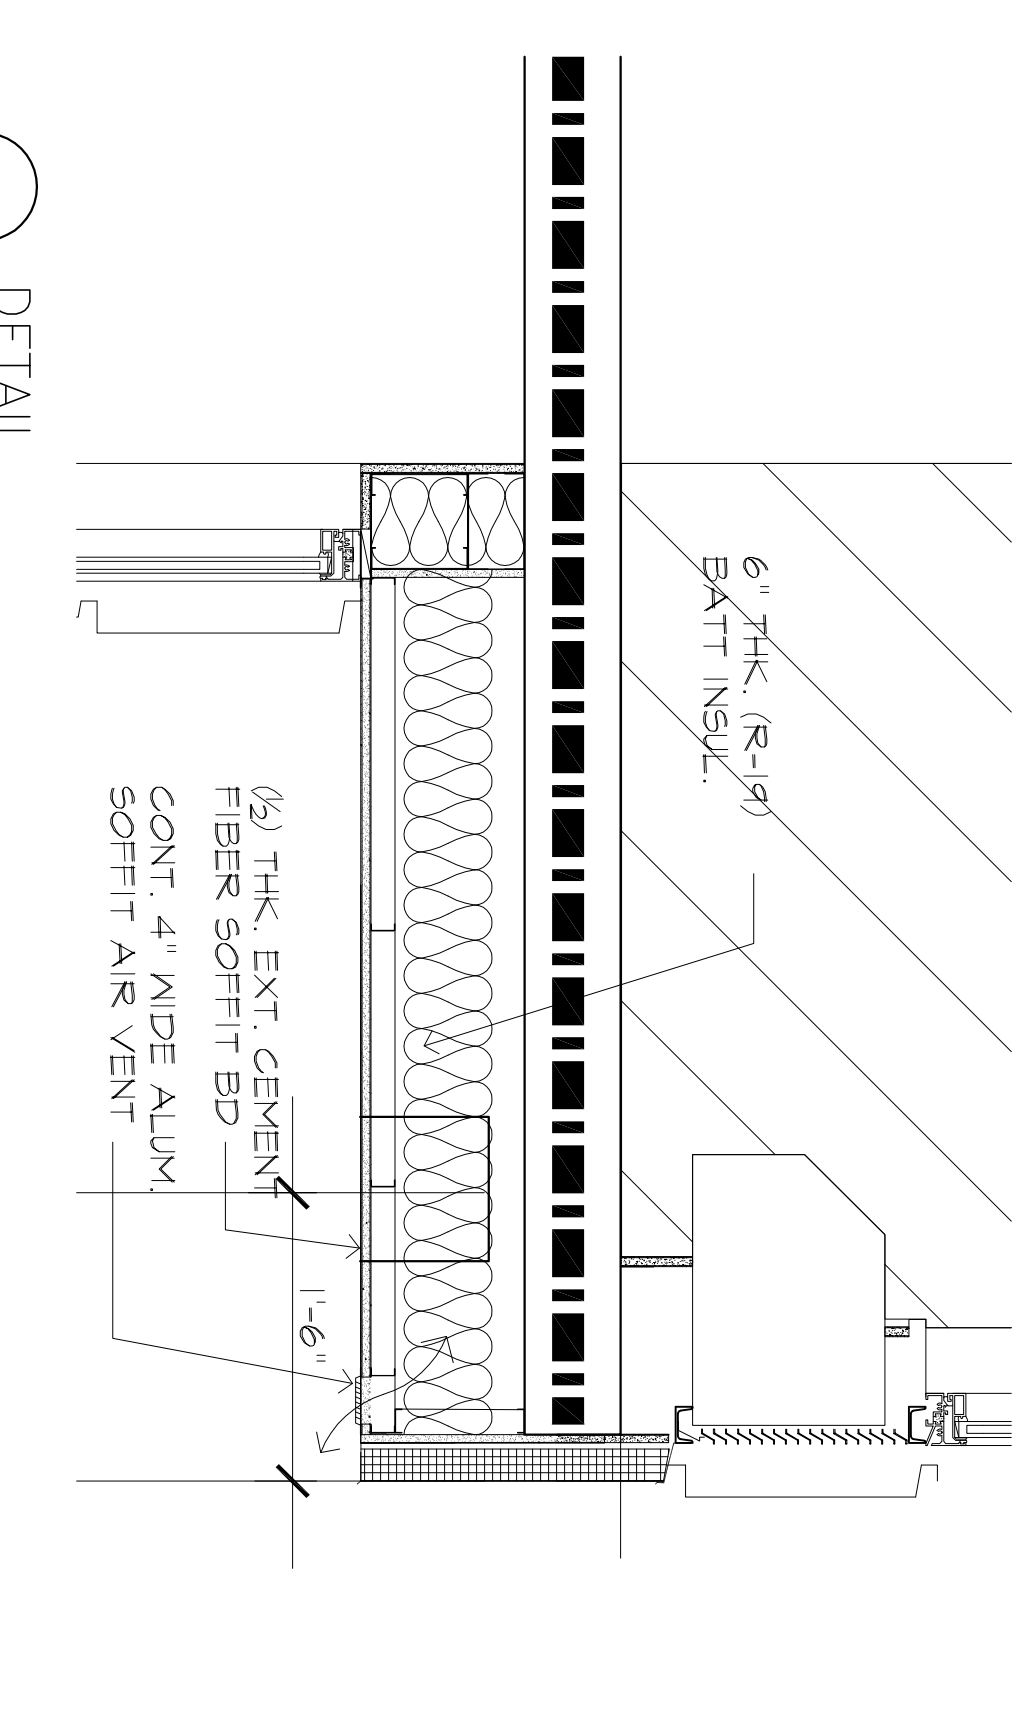
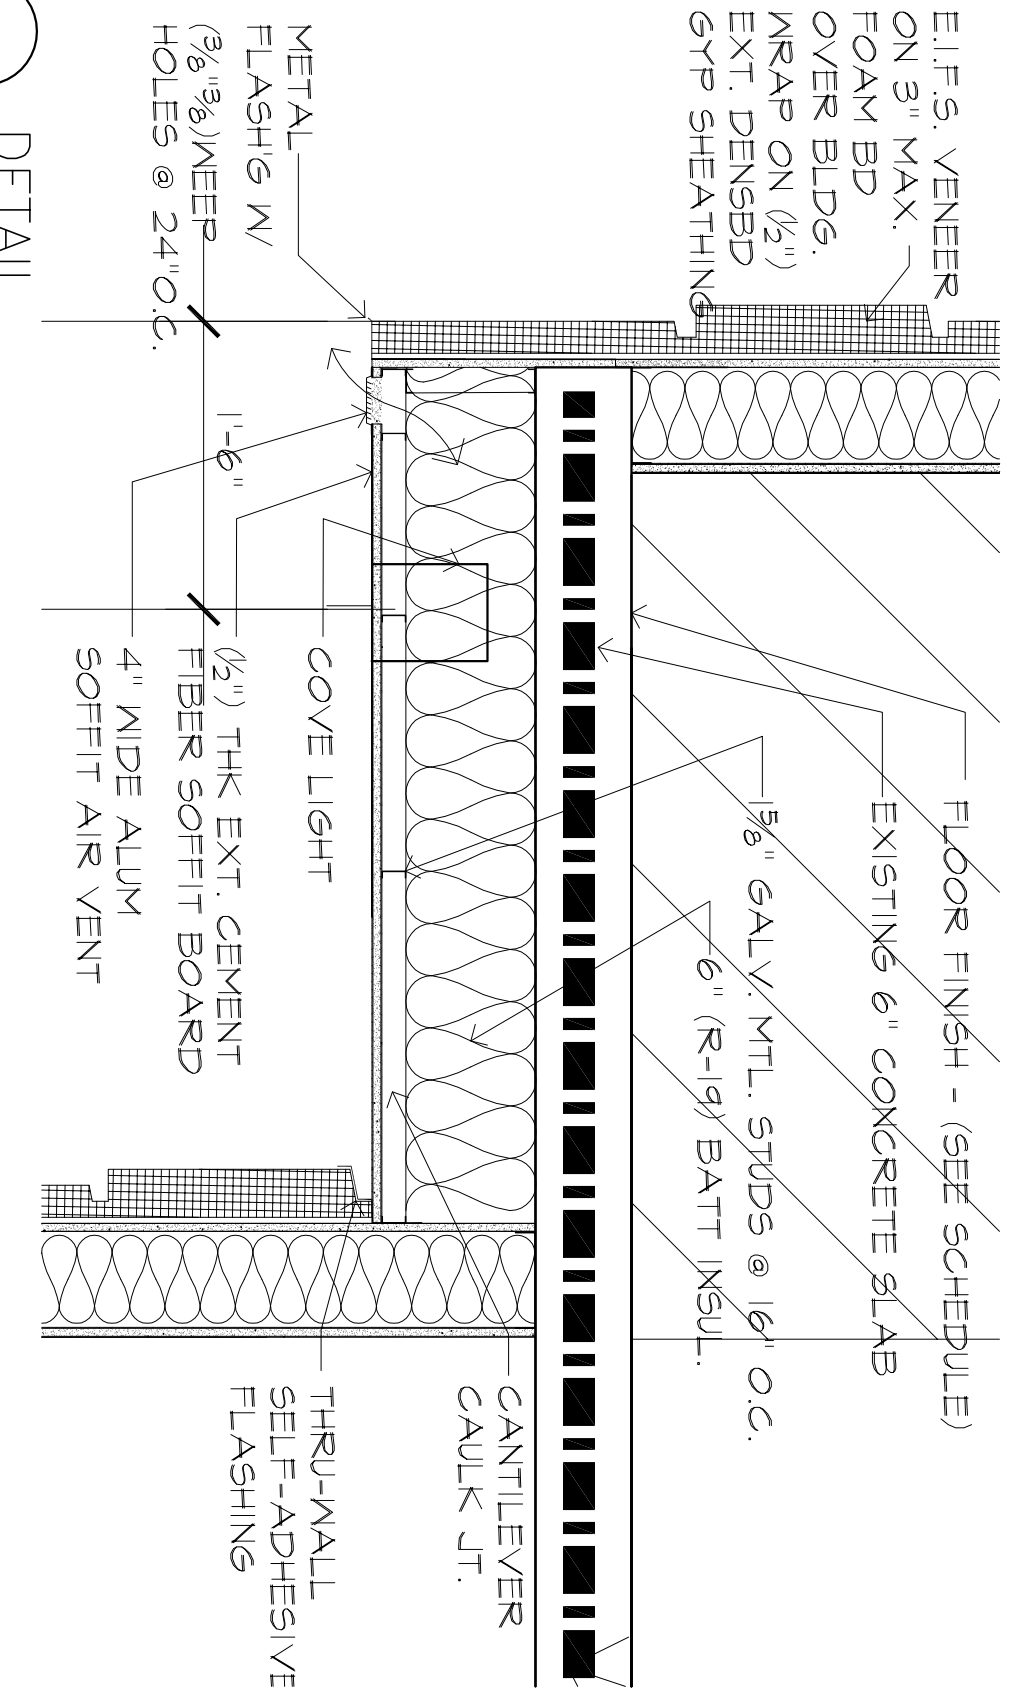
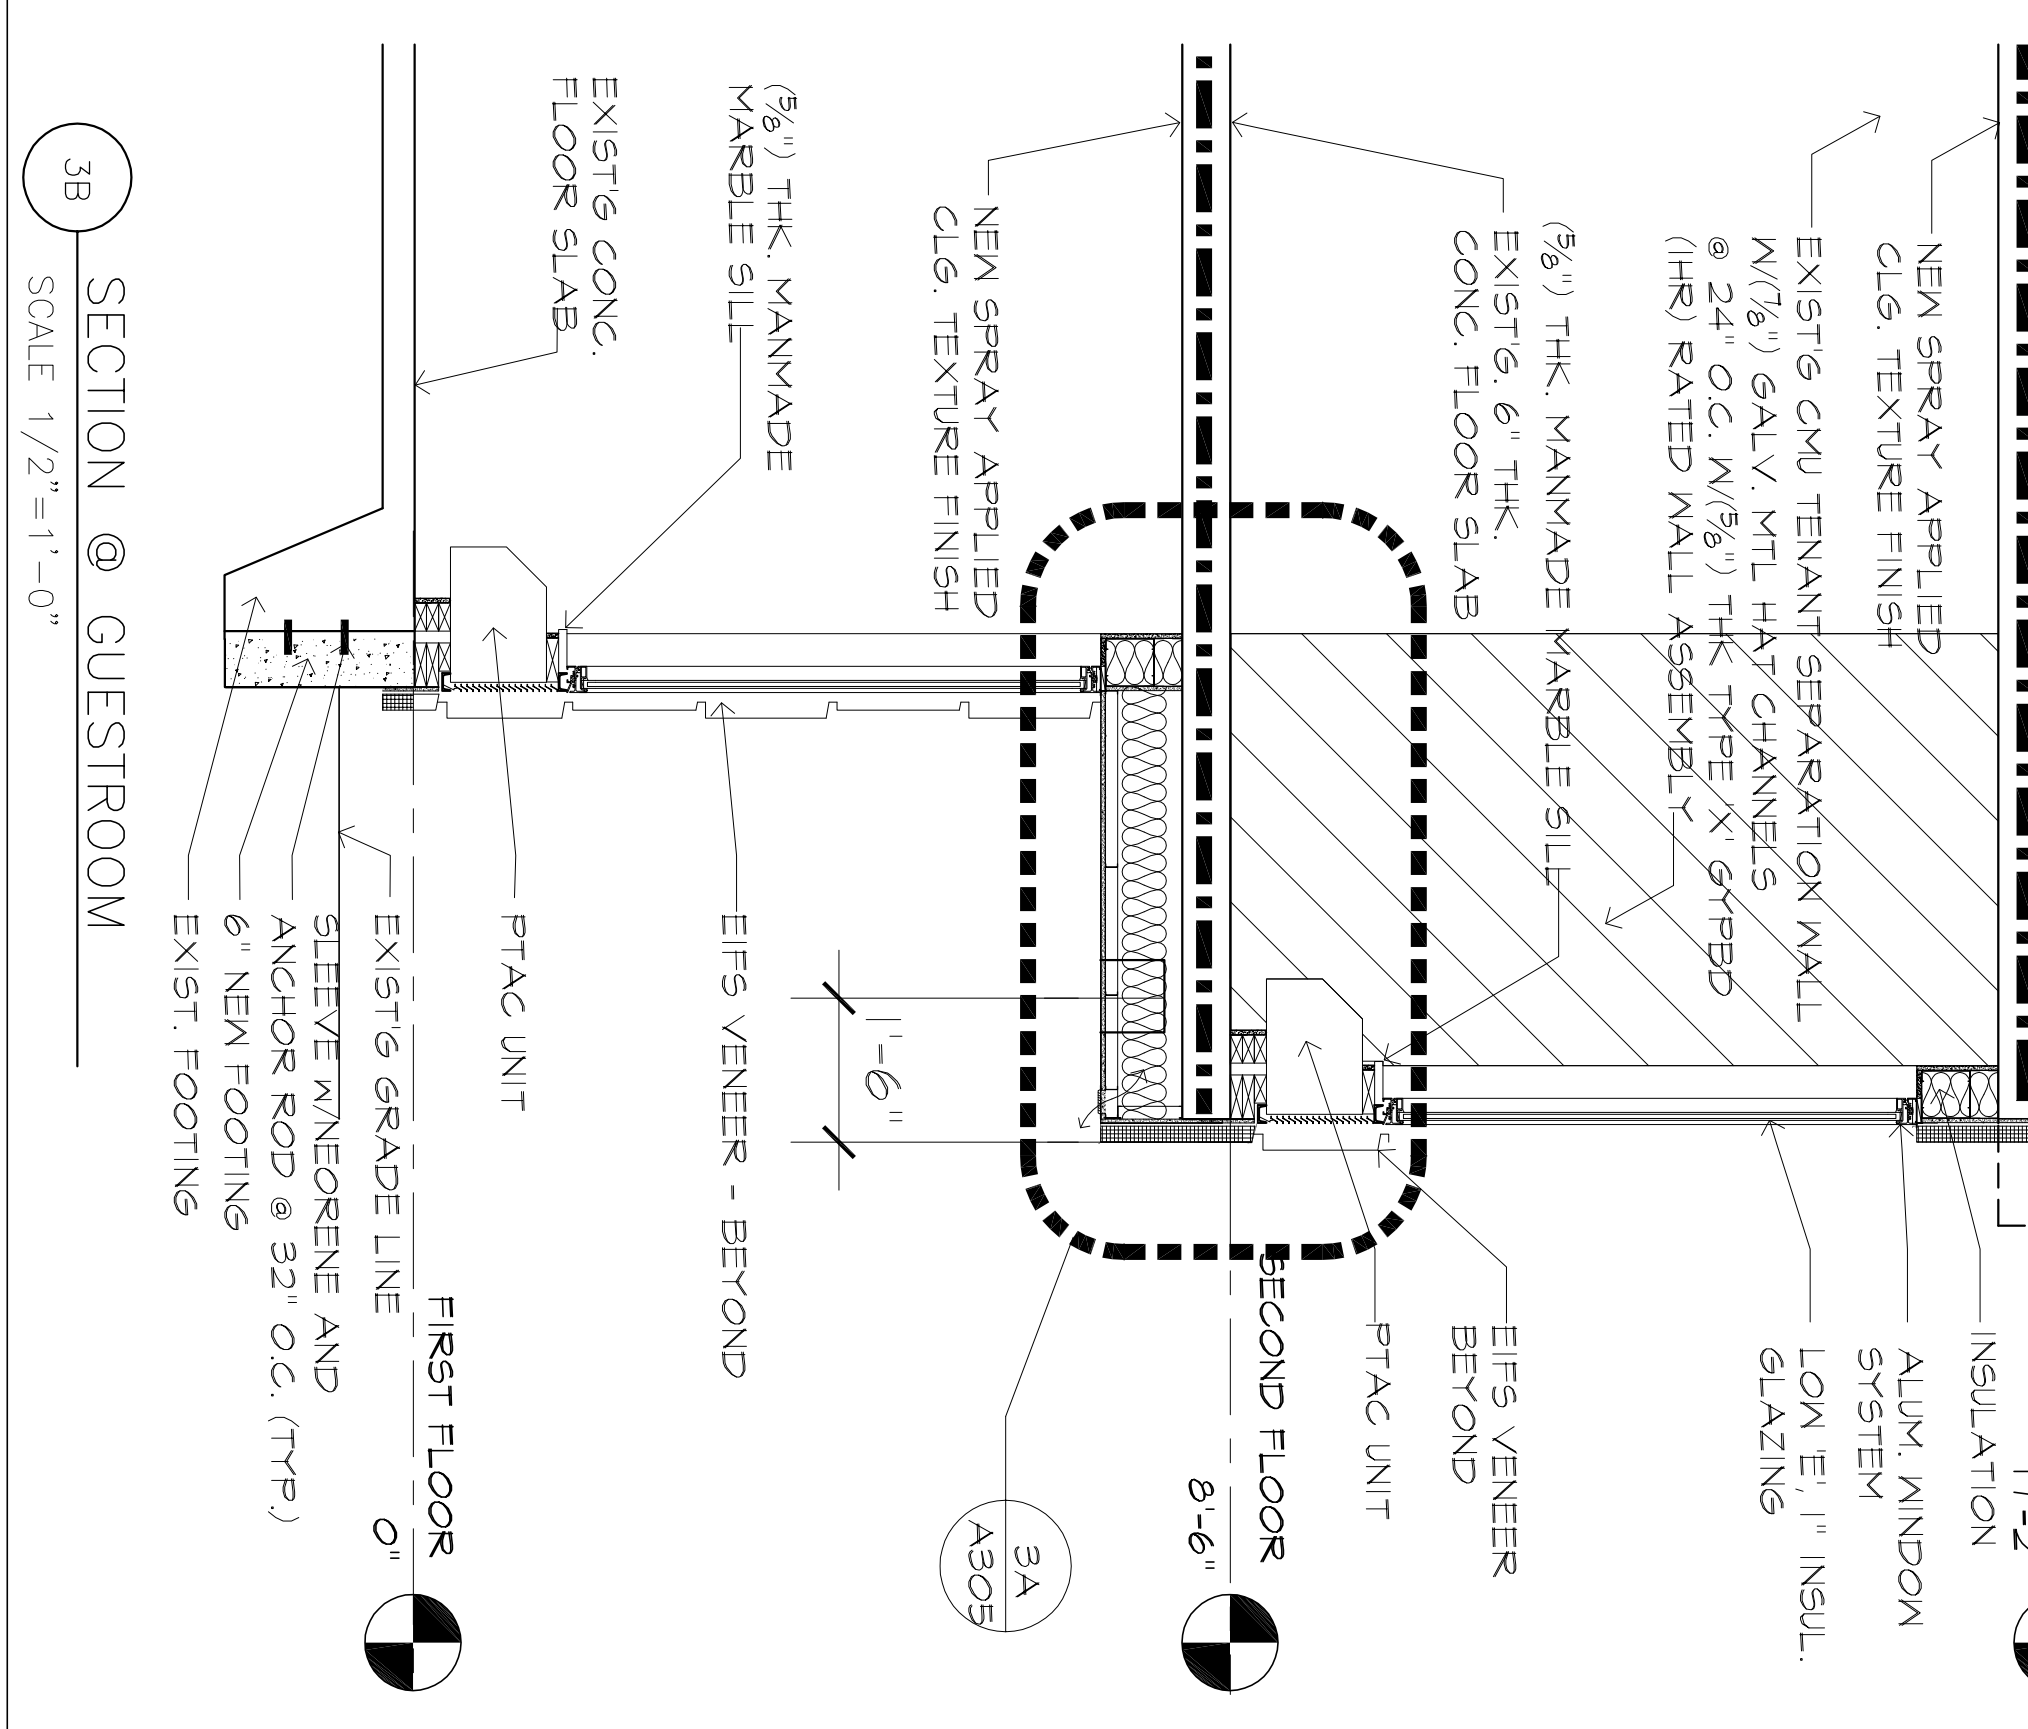
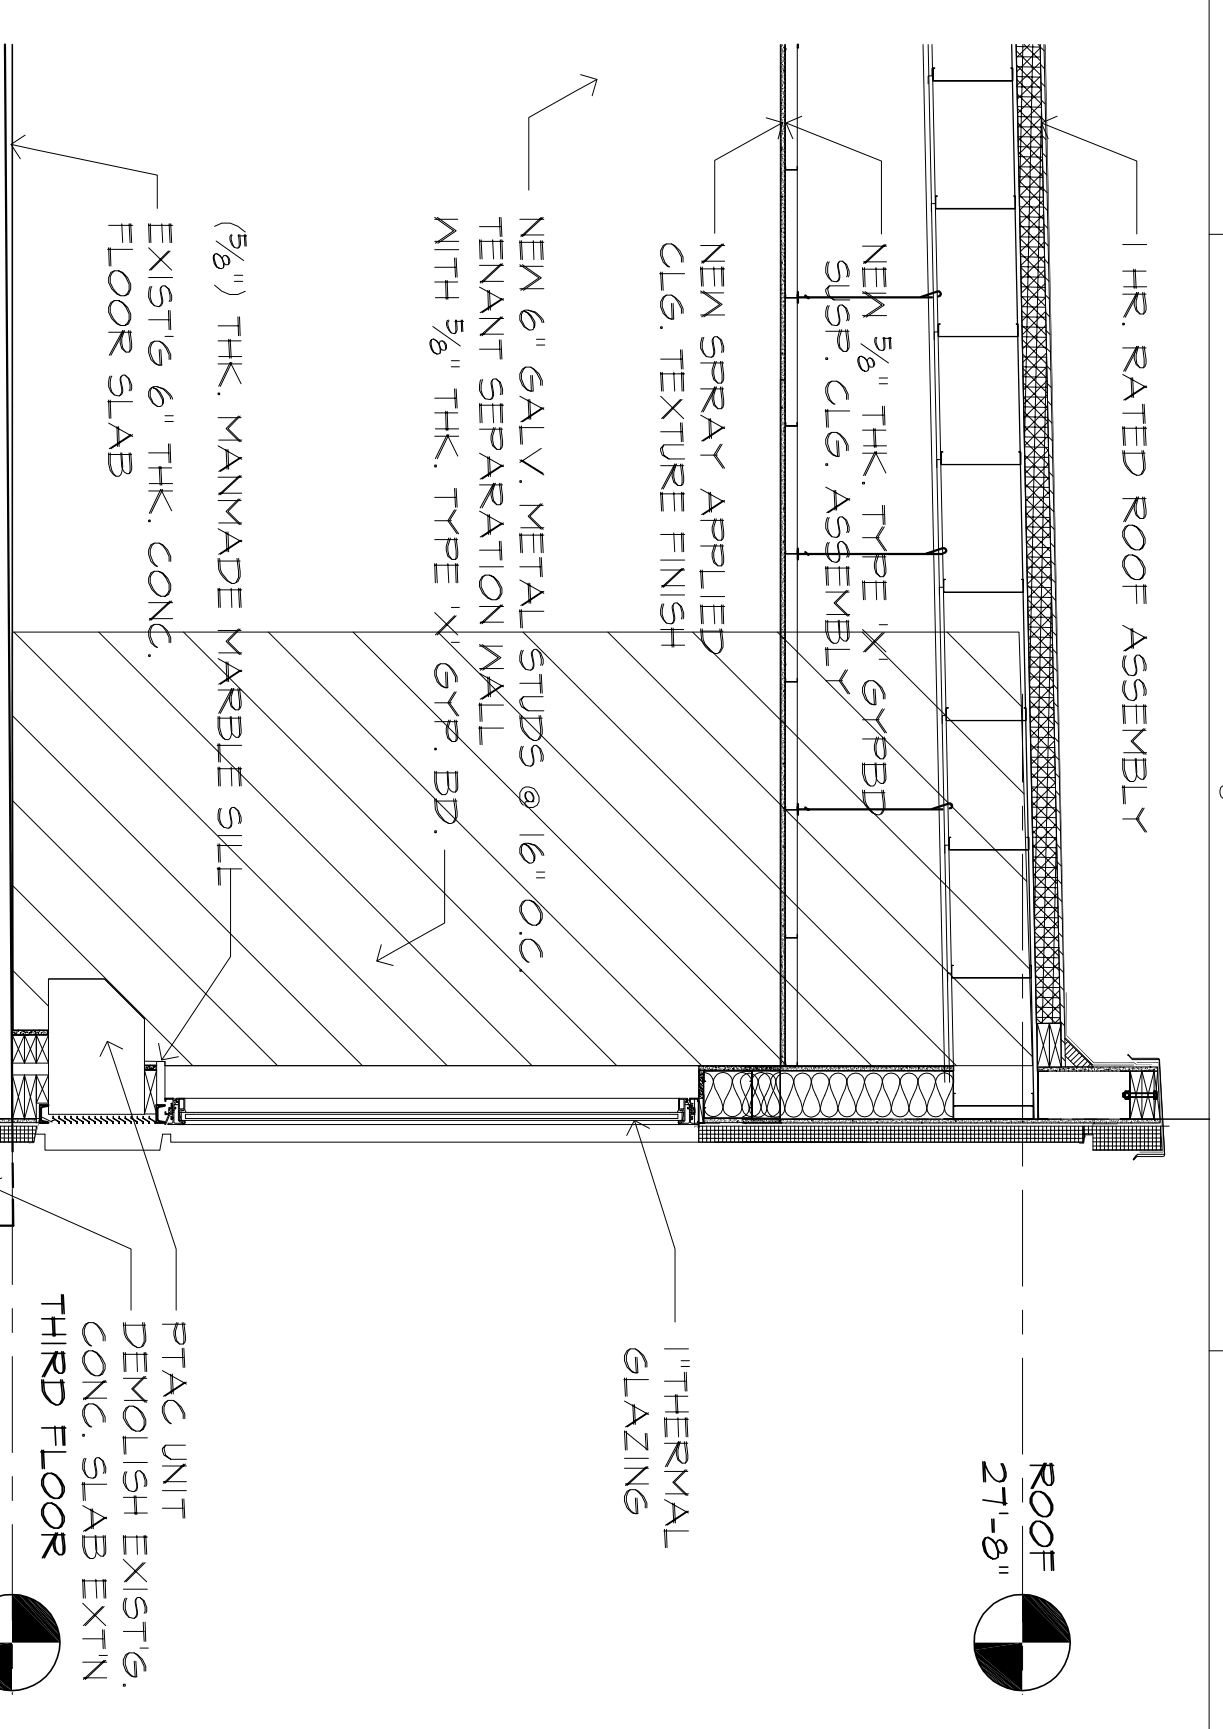
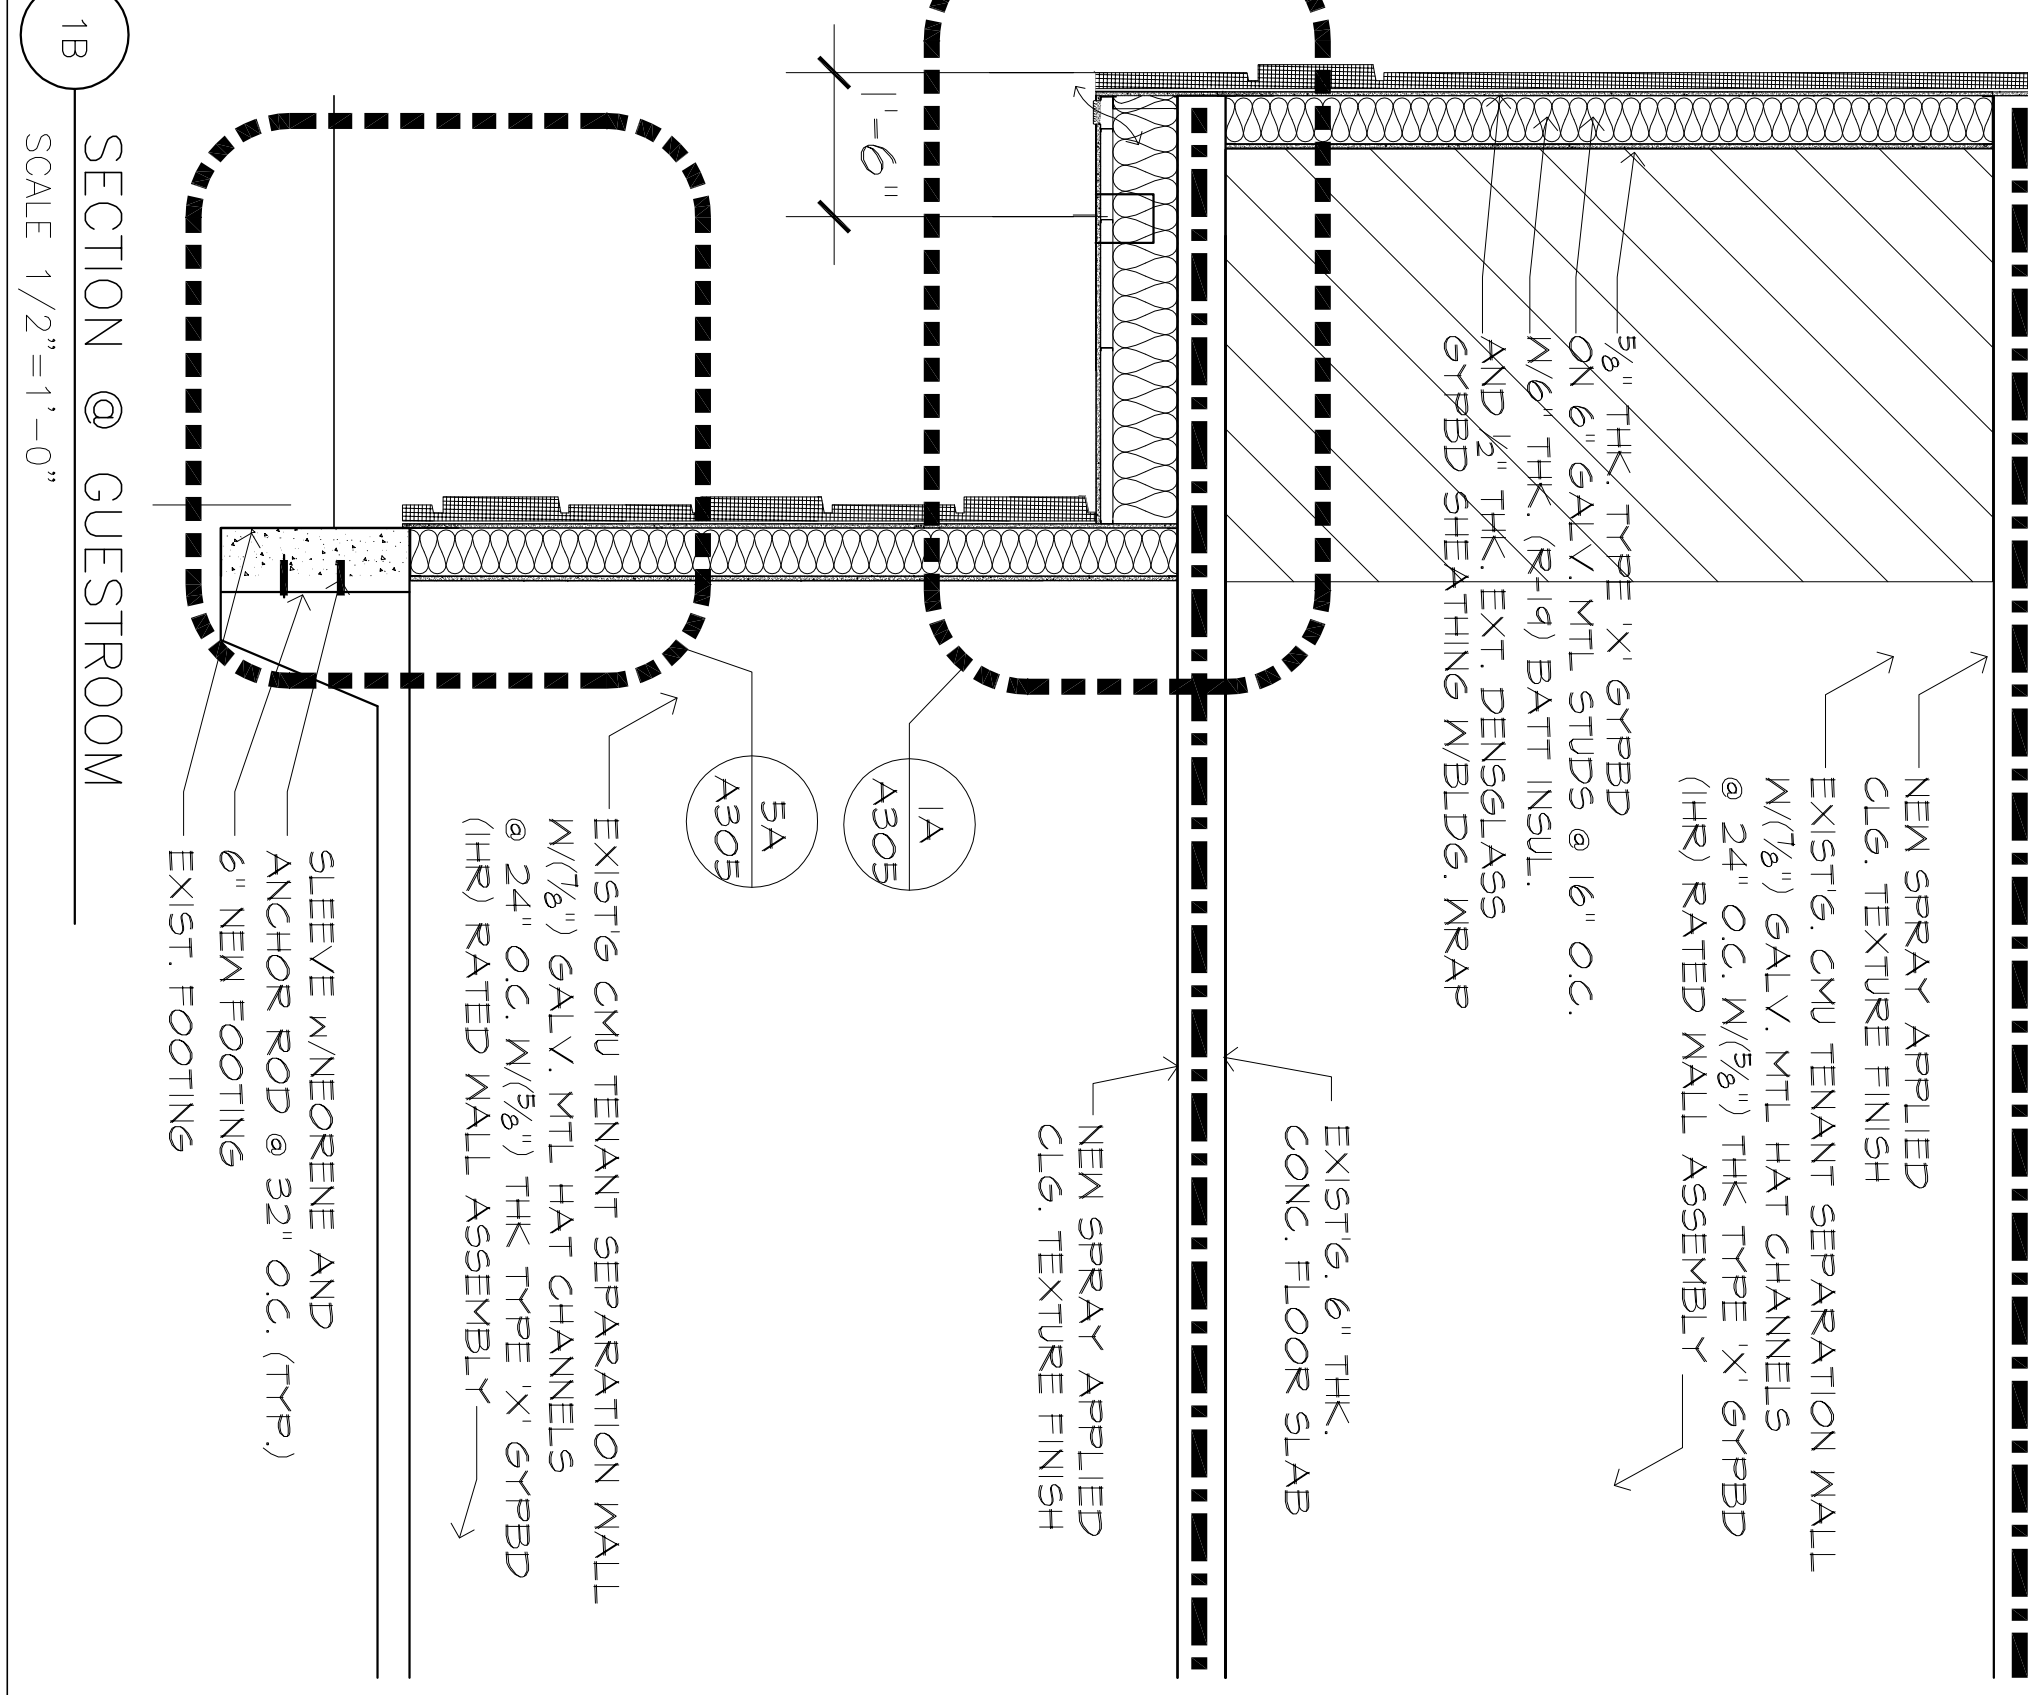
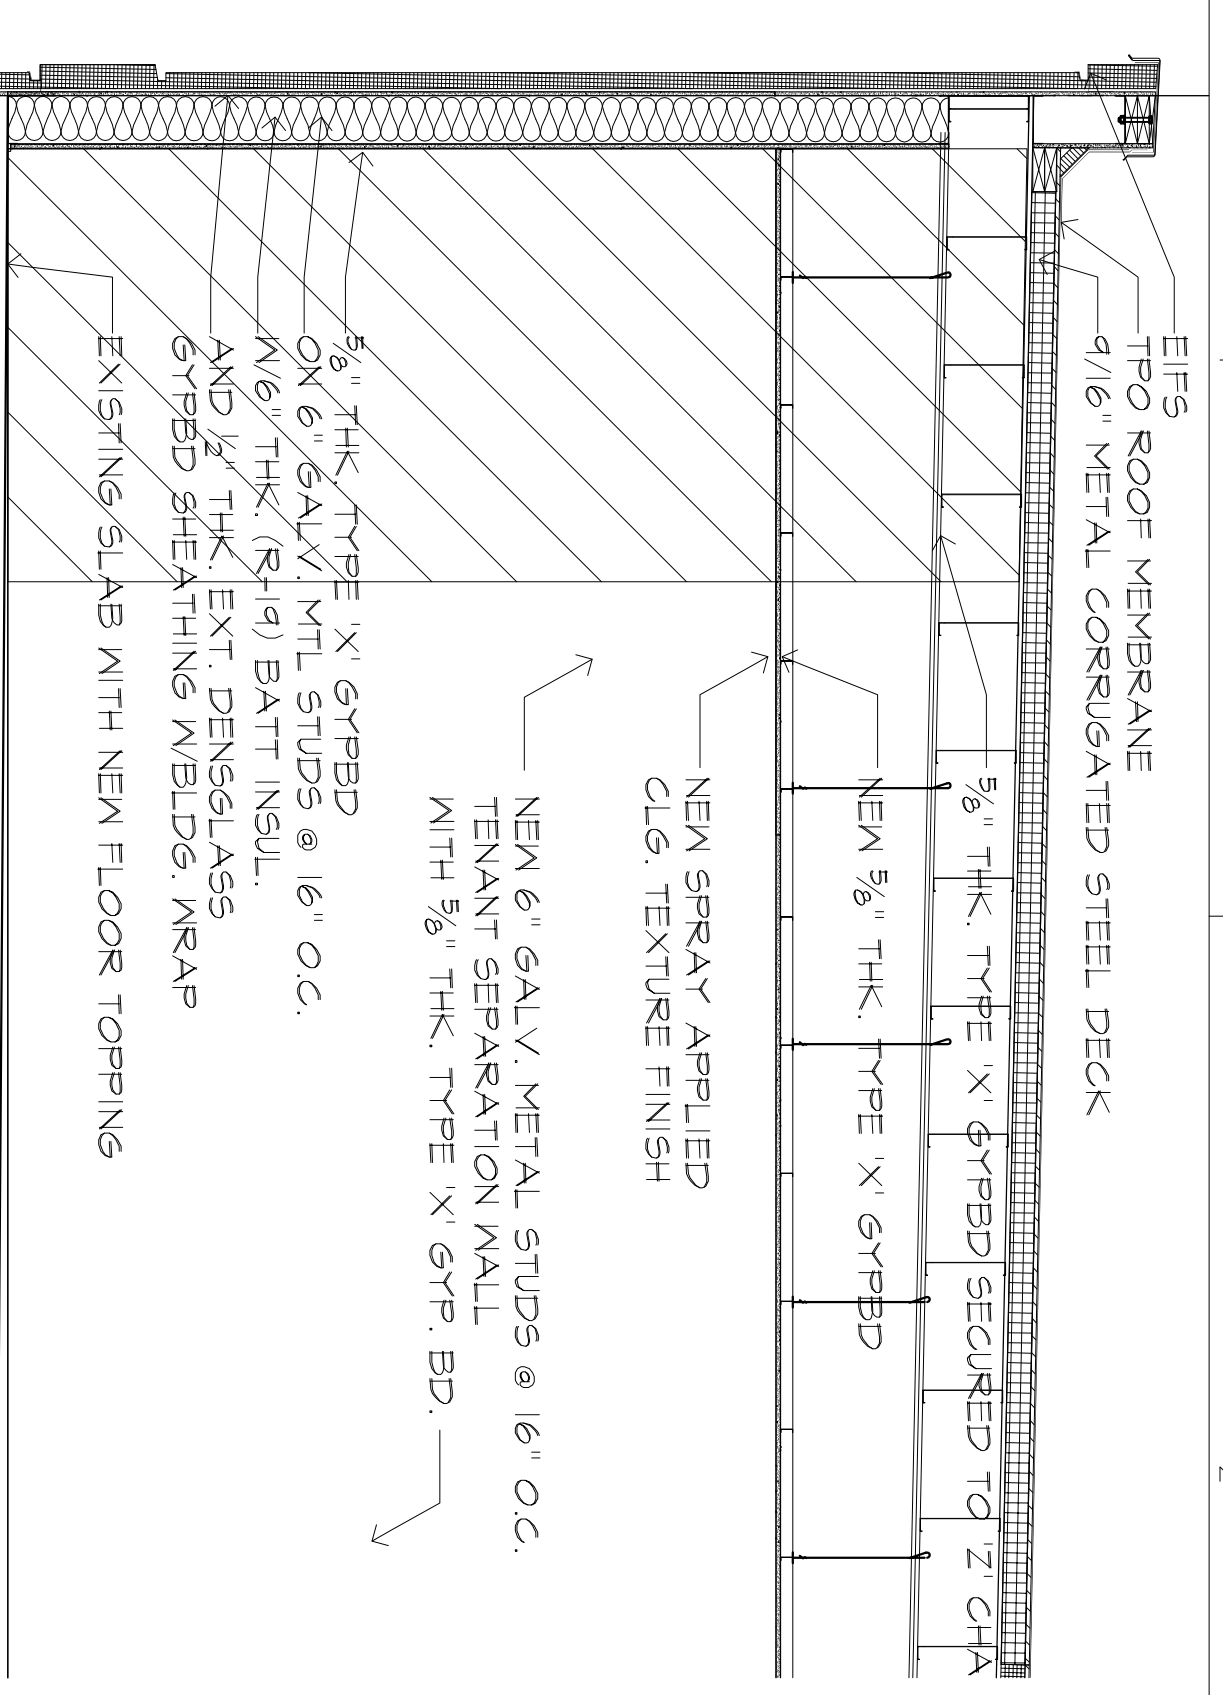
1A SECTION @ GUESTROOM SCALE 1/2"=1'-0"

1 2 3 4

5A SECTION @ GUESTROOM SCALE 1/2"=1'-0"

1 2 3 4 5





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3	1/22/2016	100% REVIEW SET

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PROJECT NAME:  
 SHEET NAME:  
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DRAWN BY: BNC  
 CHECKED BY: BBC  
 DATE: 12-22-15  
 SCALE: AS NOTED  
 DRAWING NUMBER: **A305**

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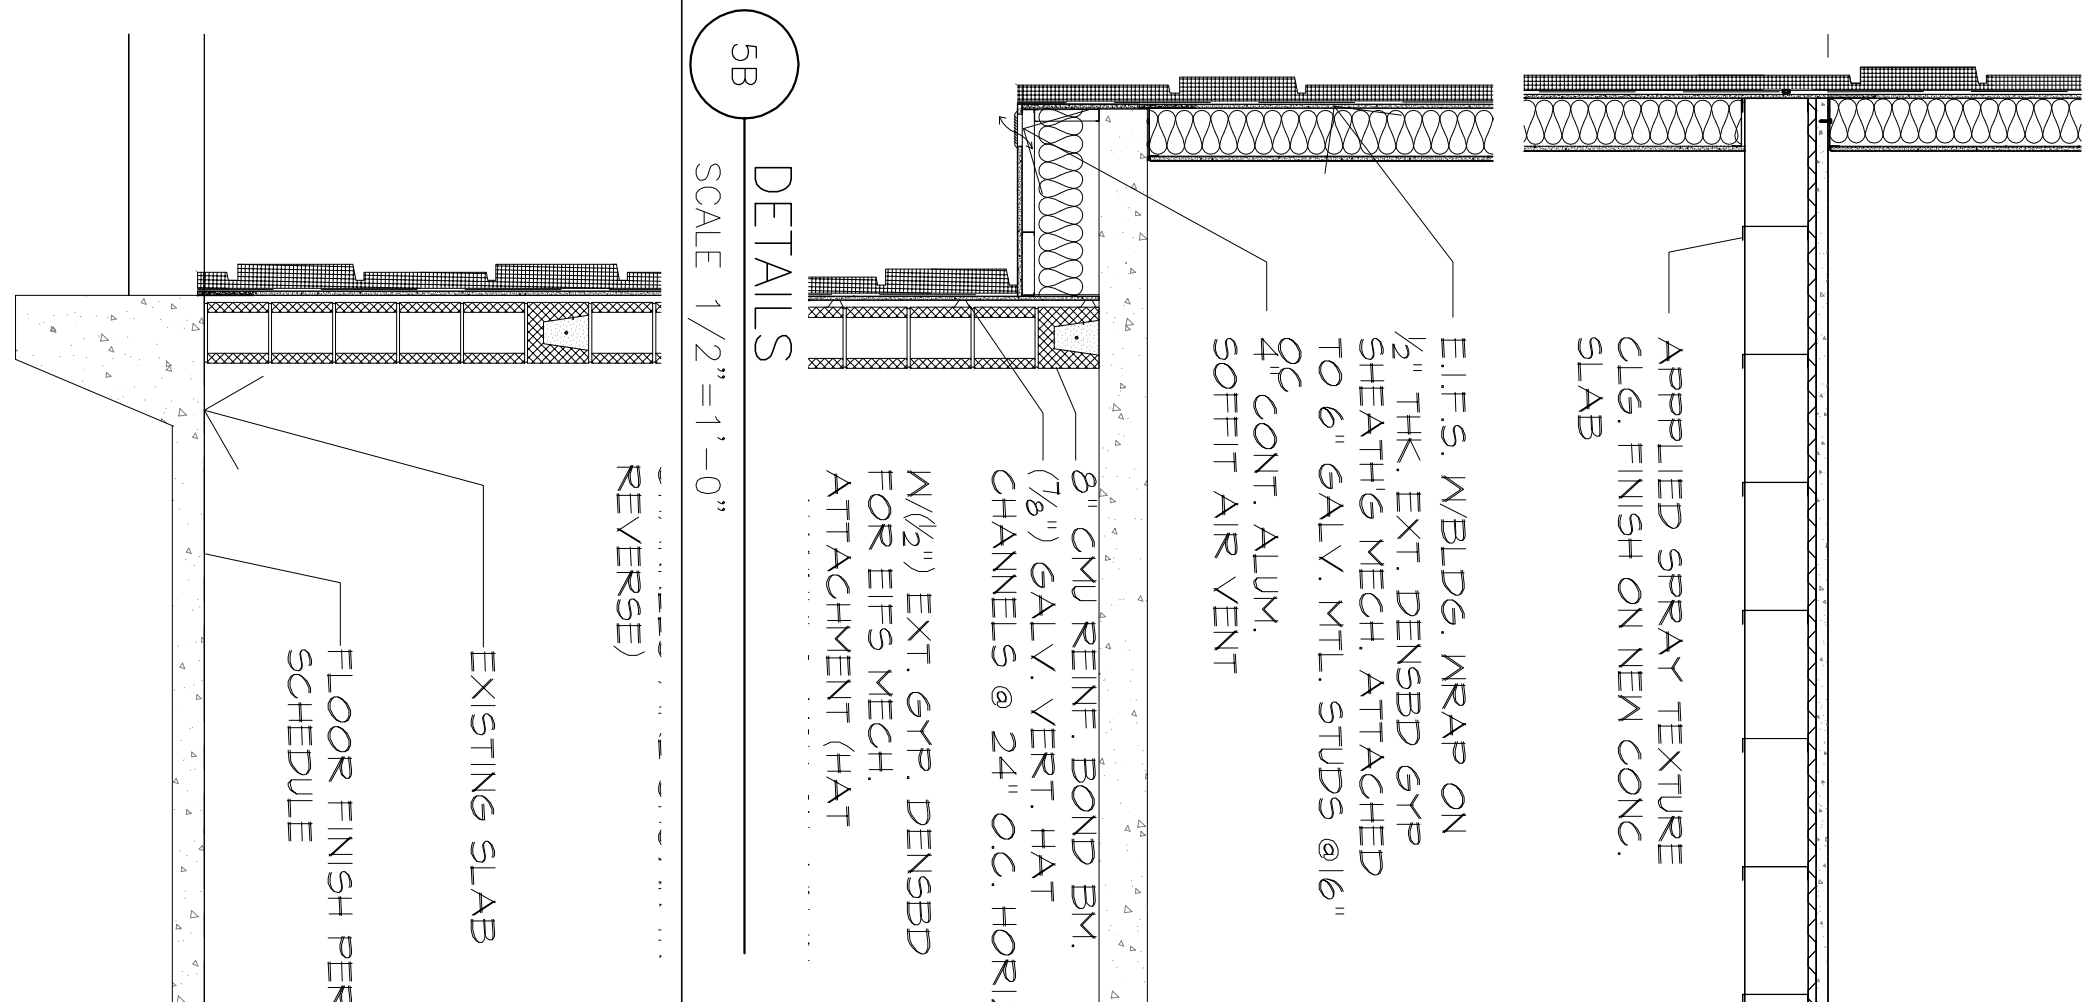
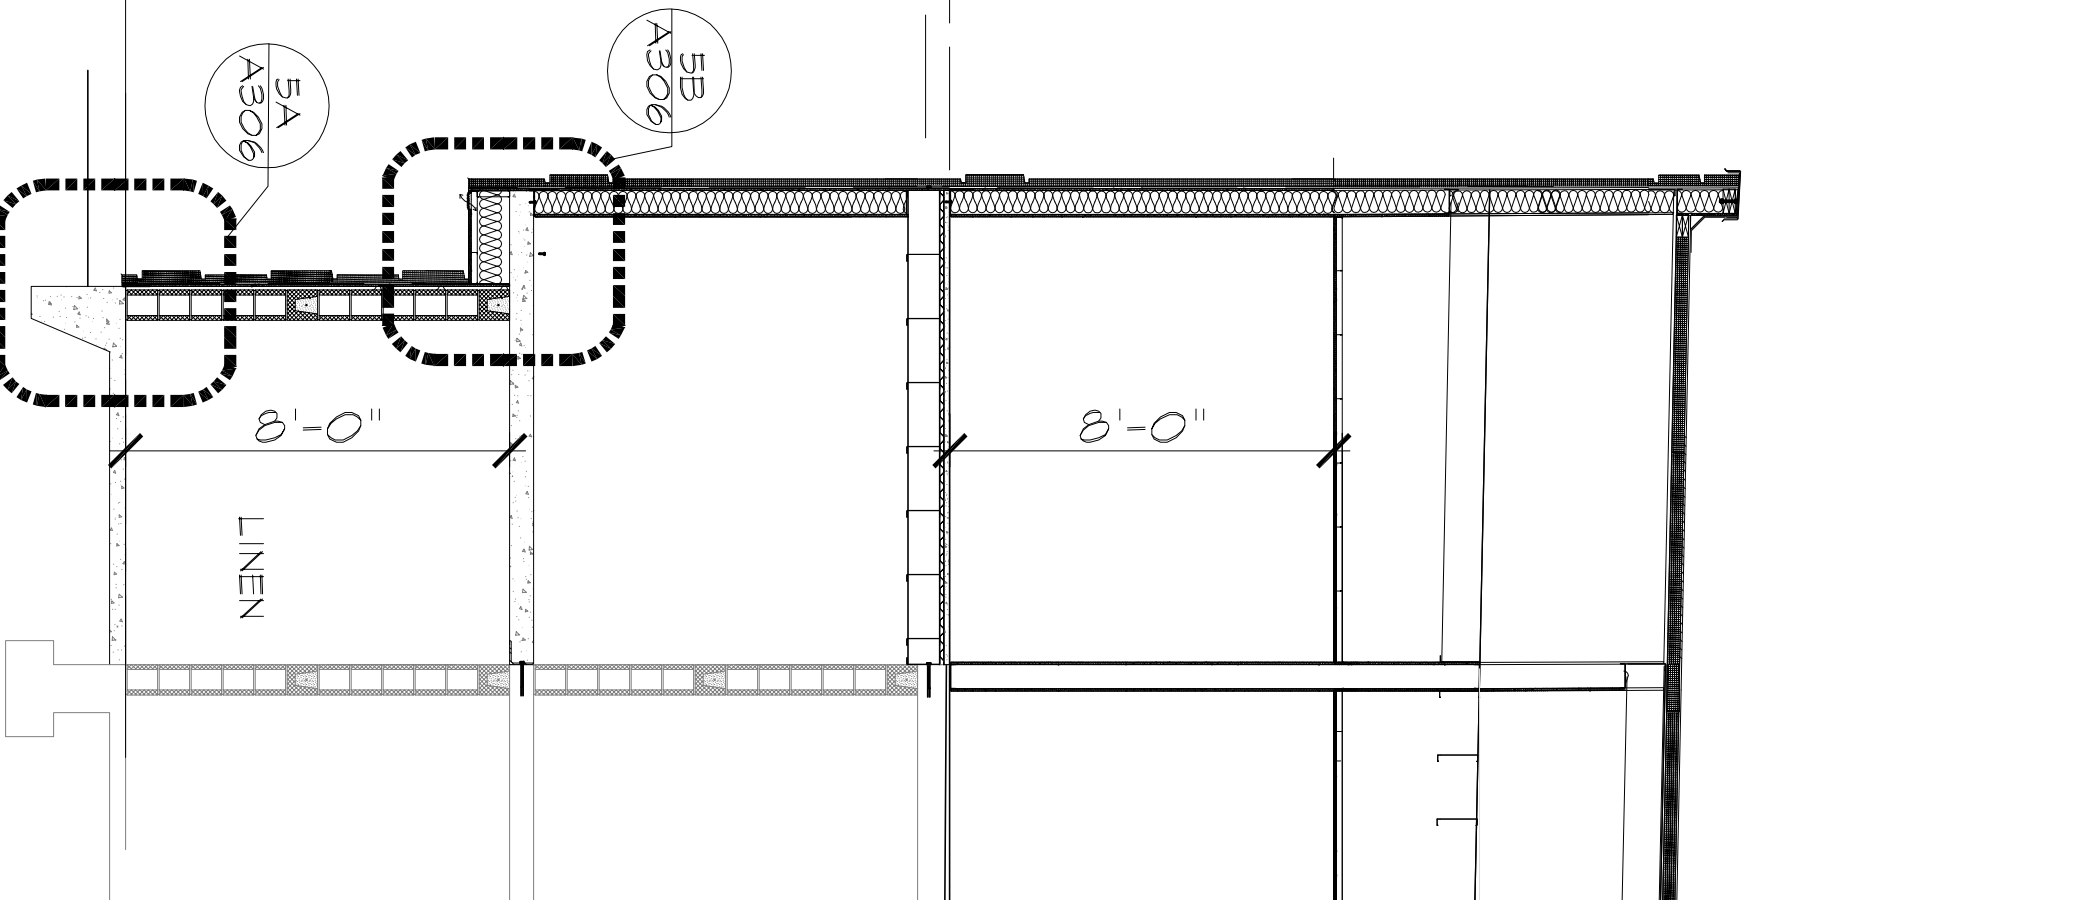
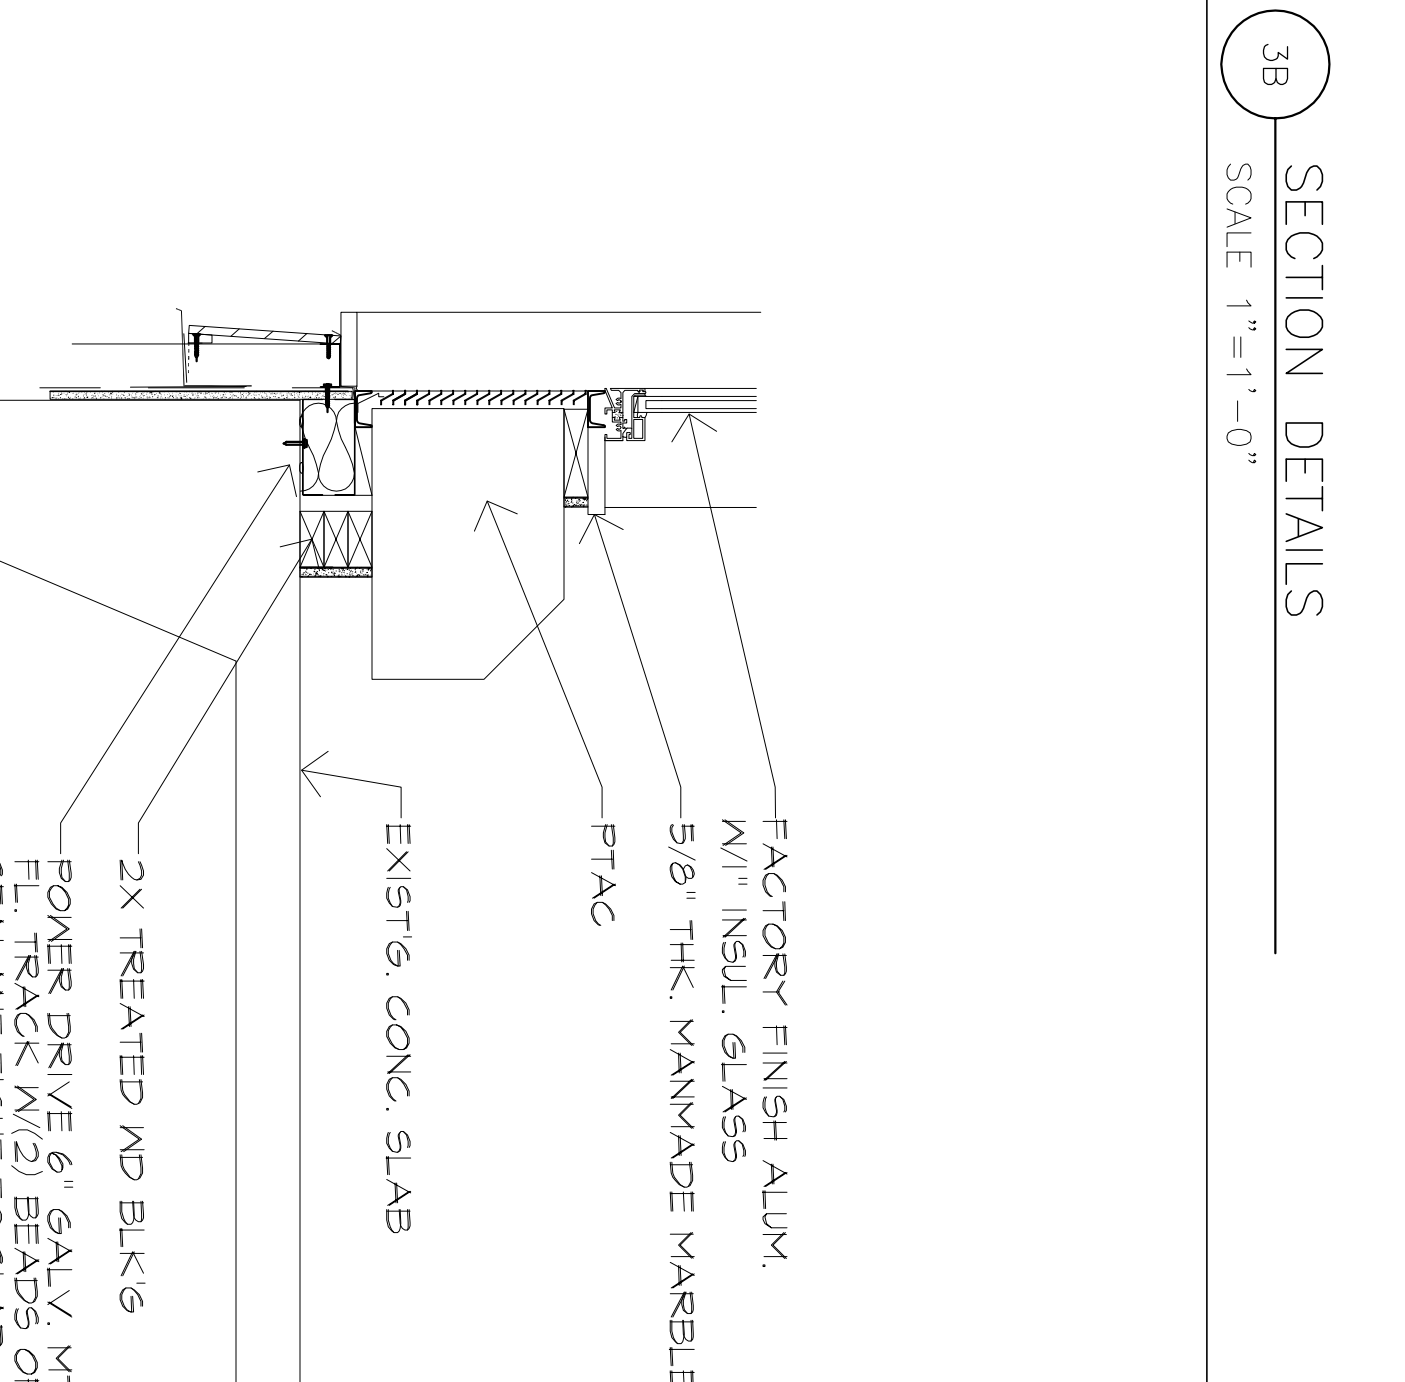
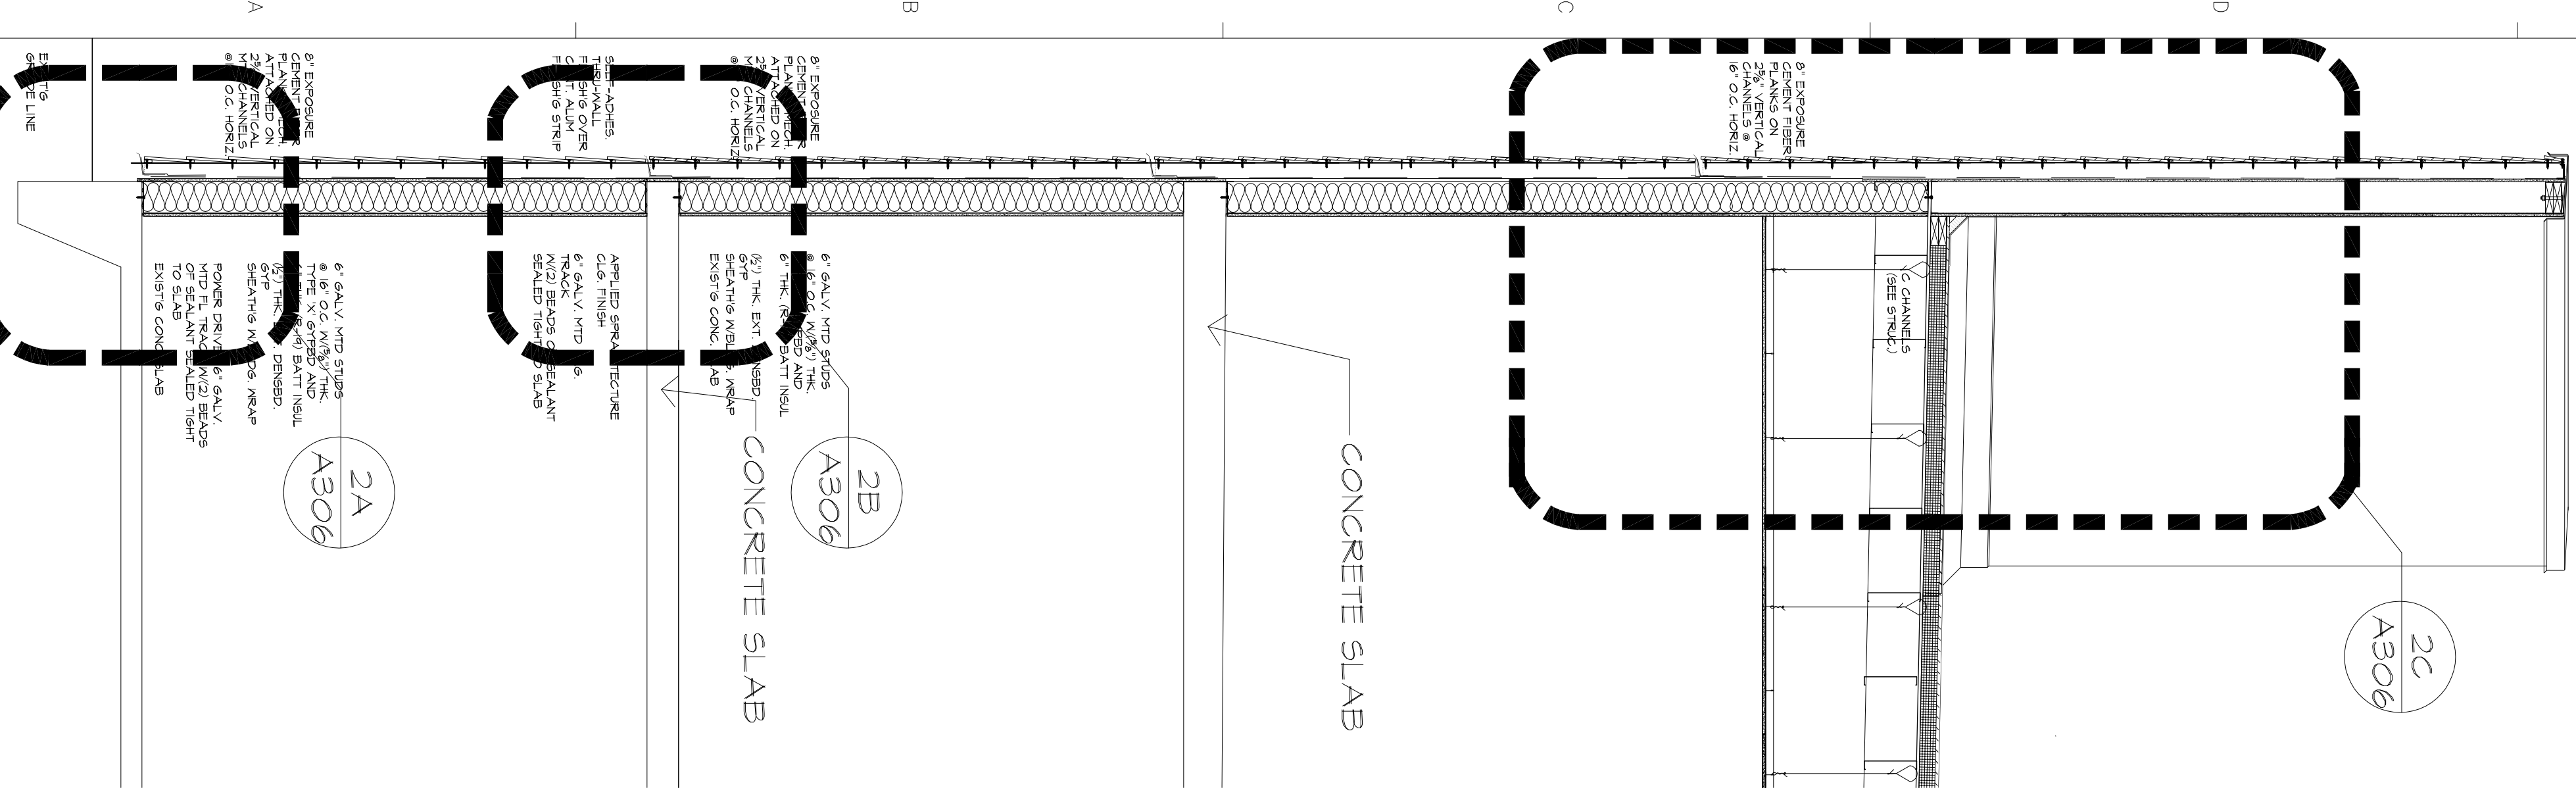
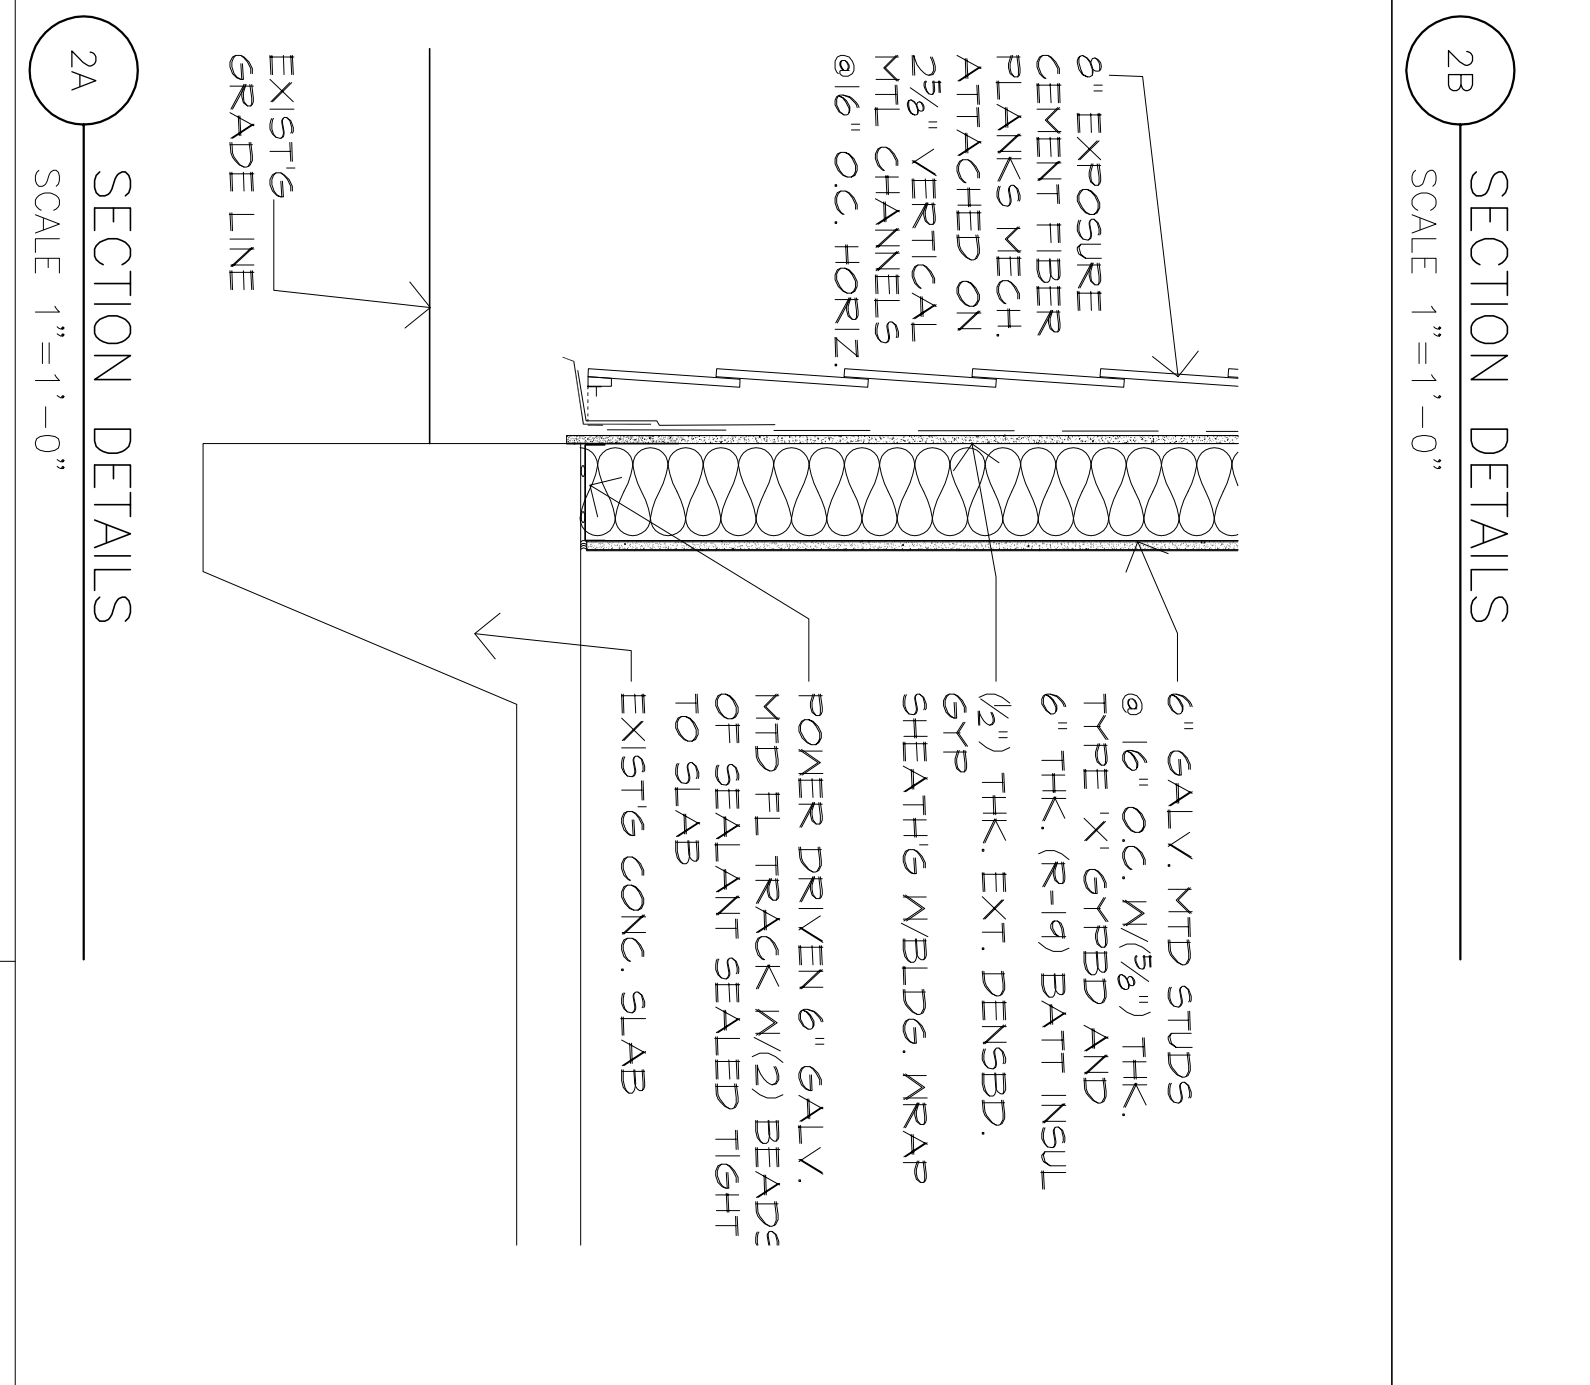
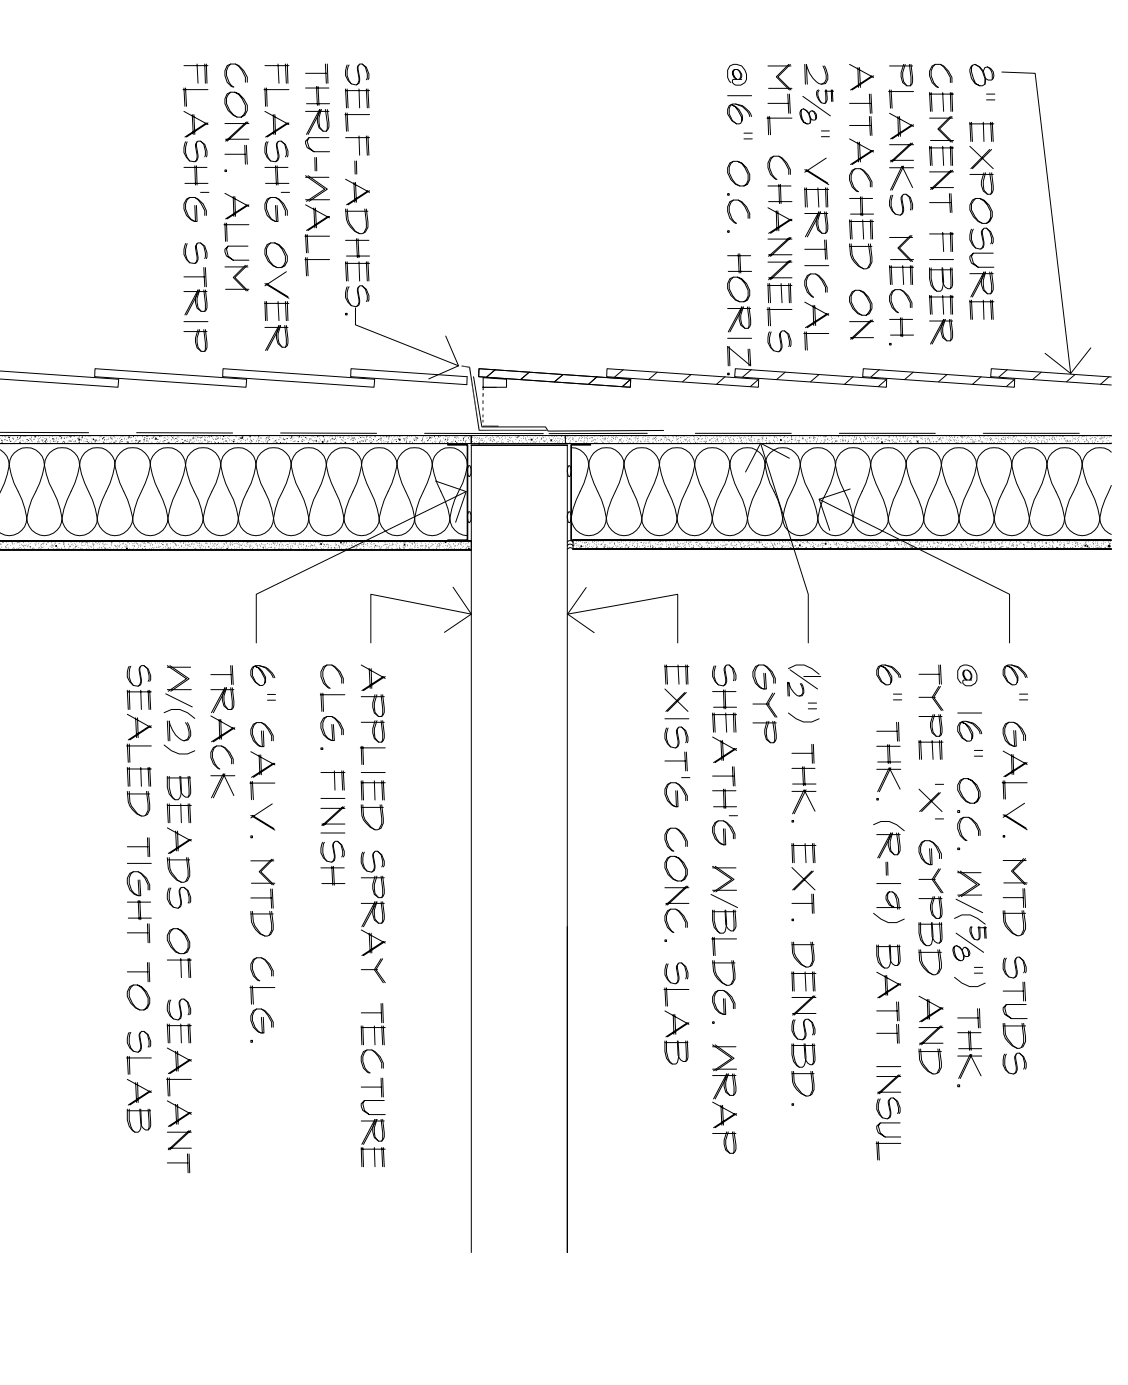
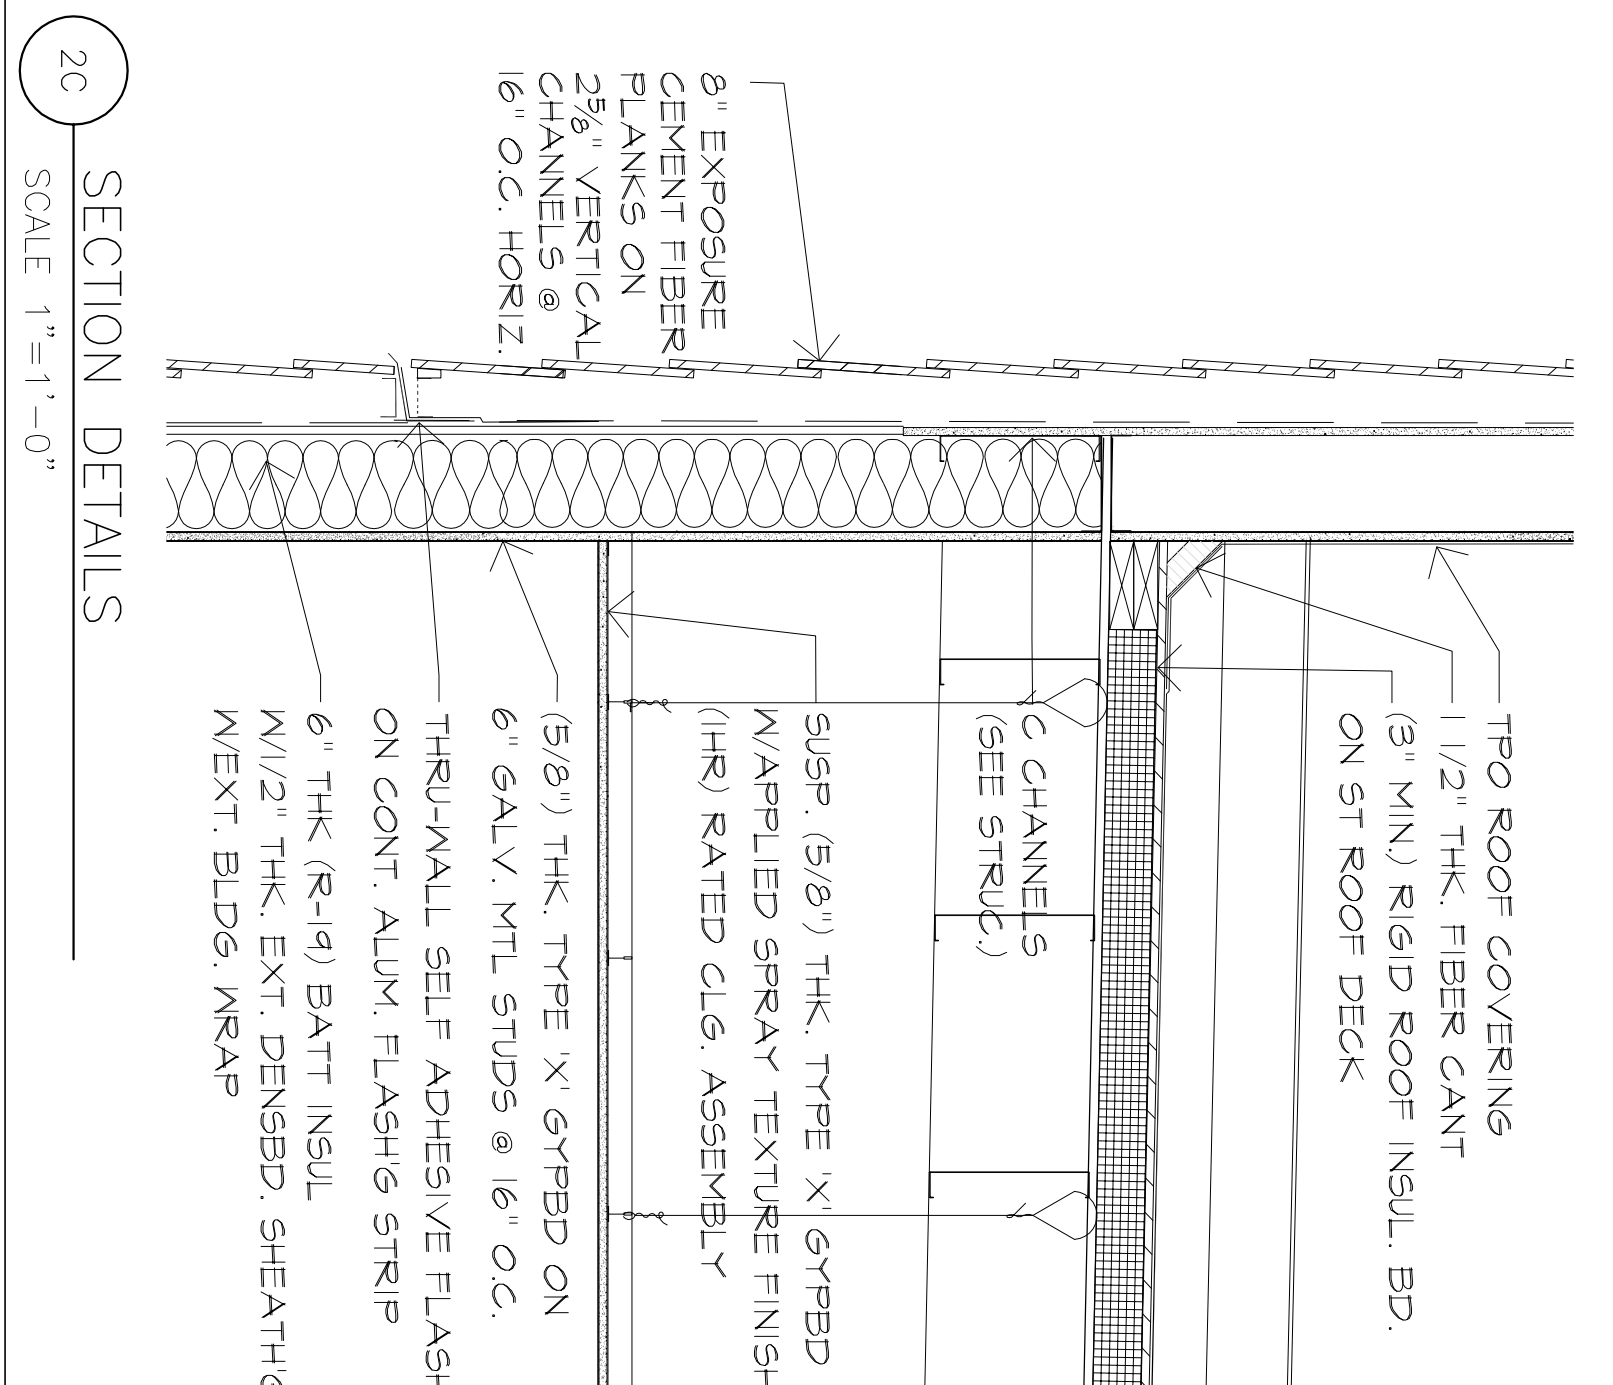
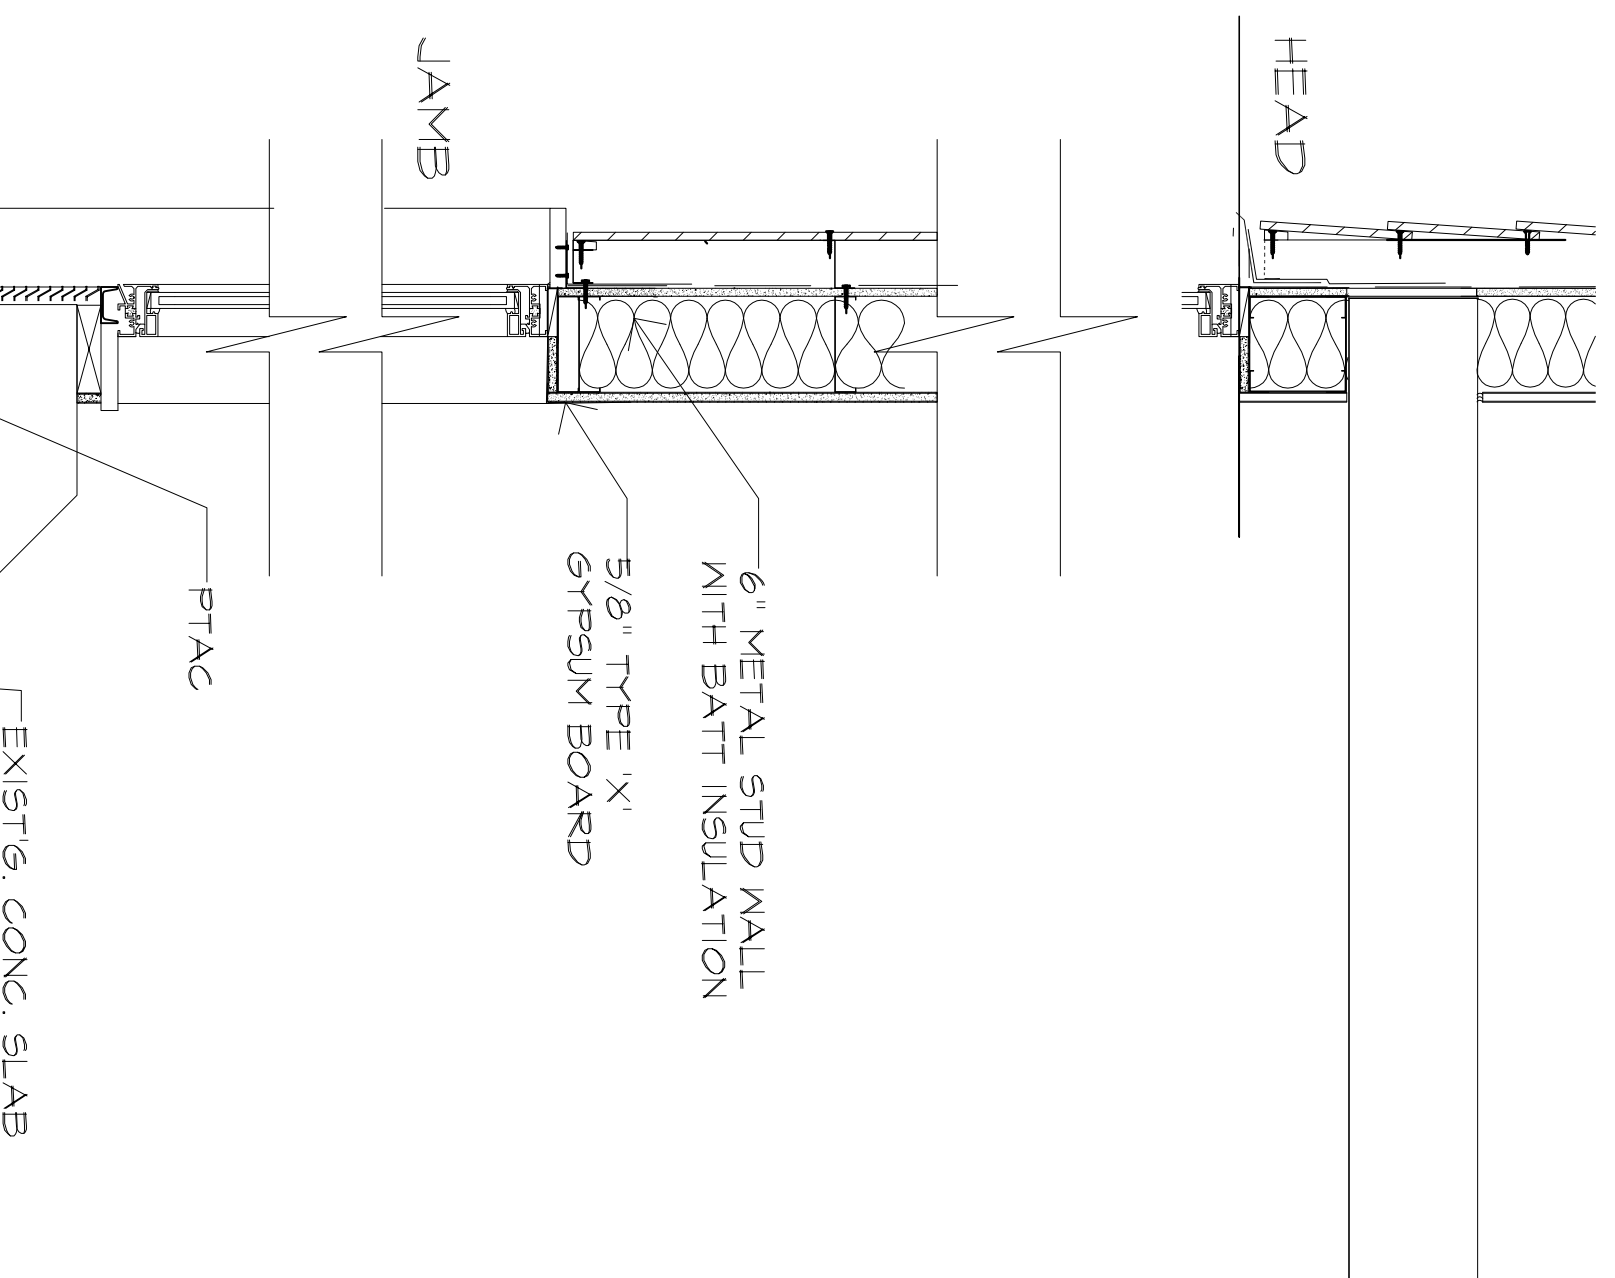
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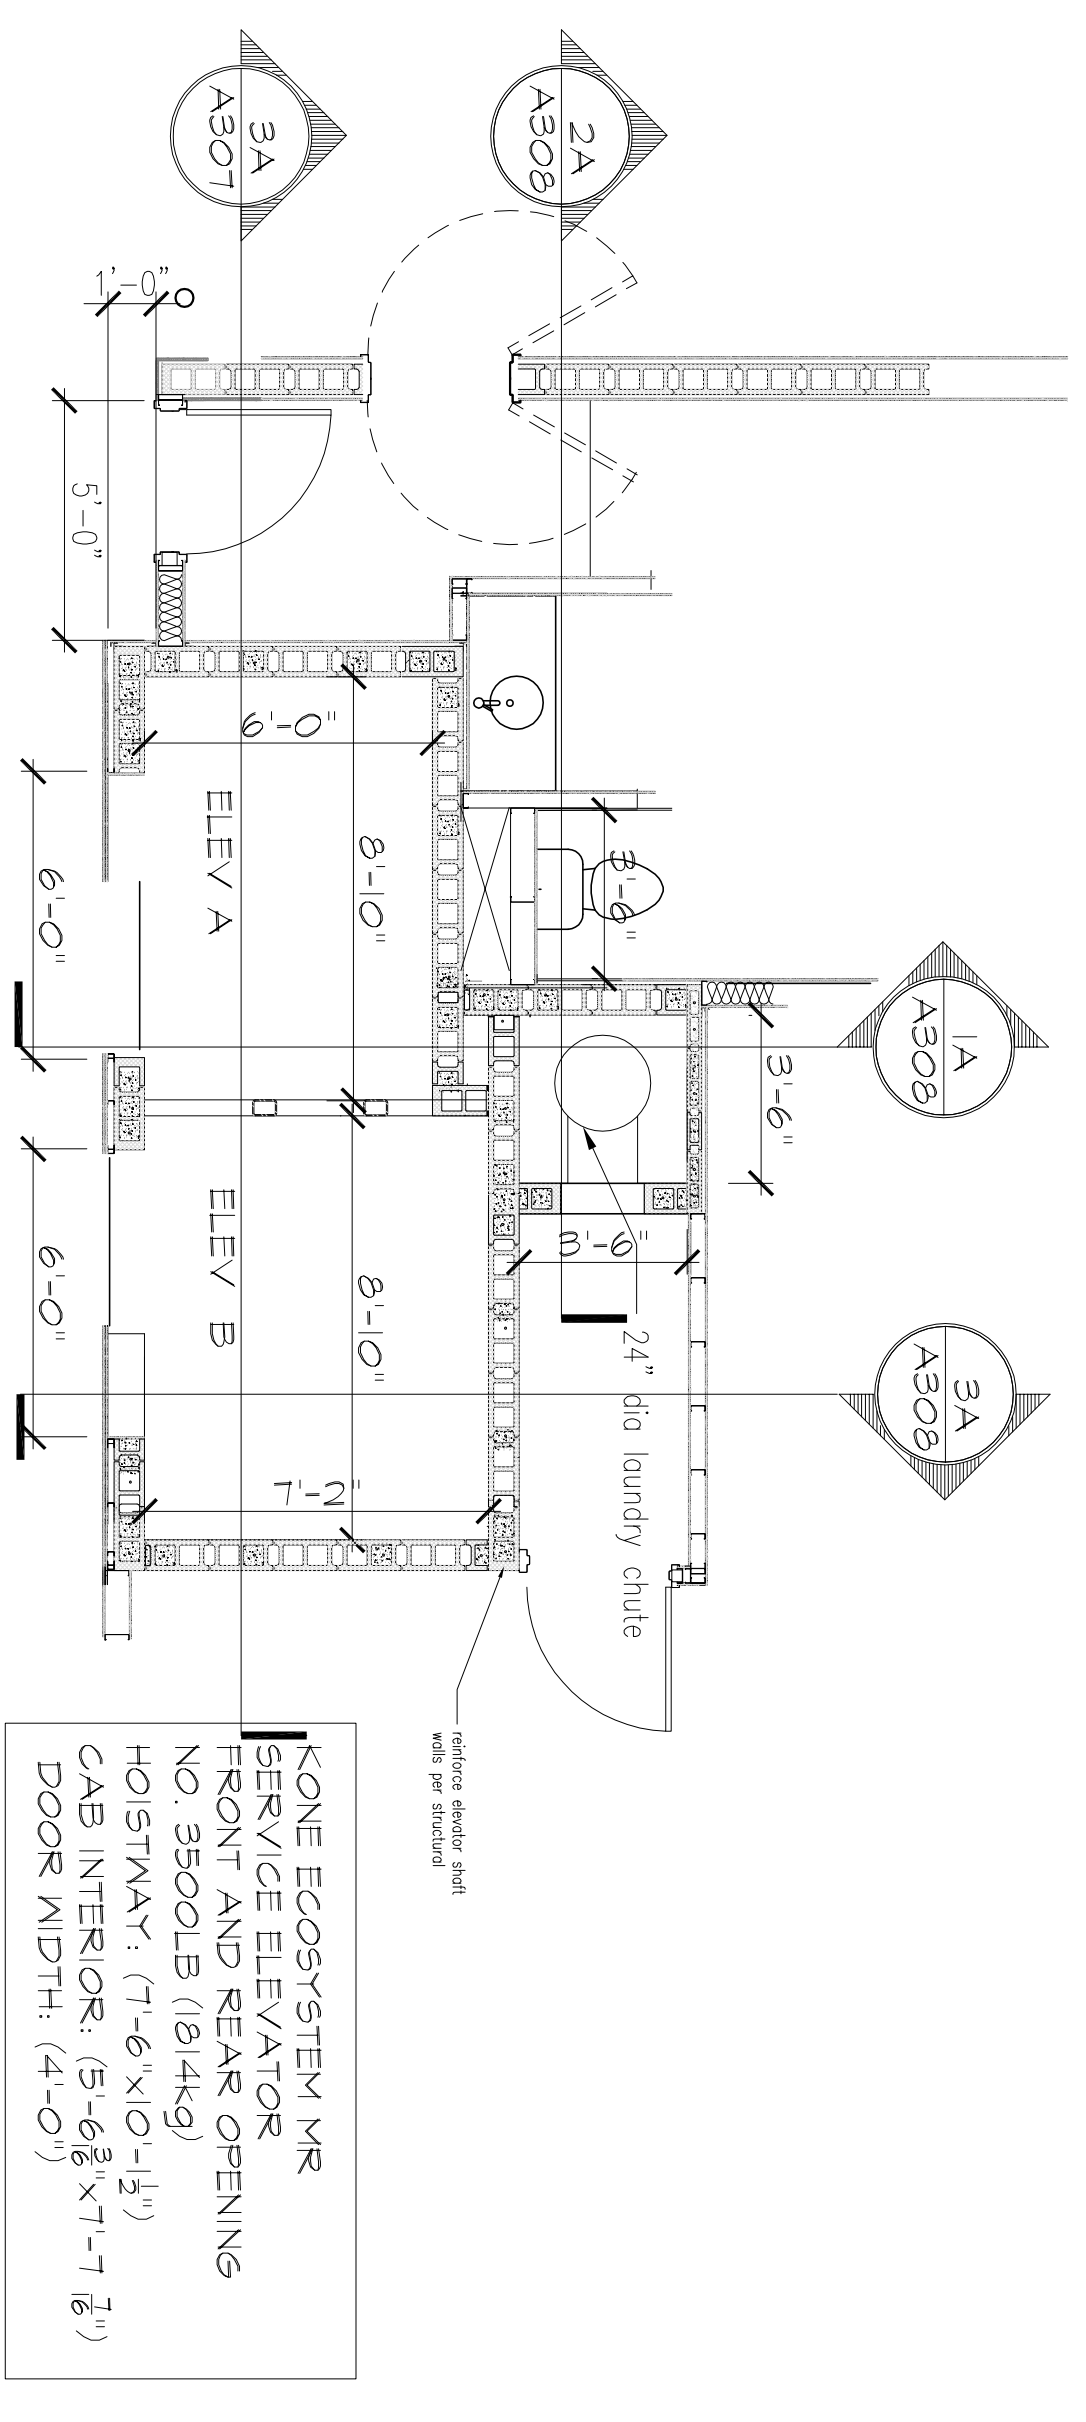
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NO.	DATE	DESCRIPTION
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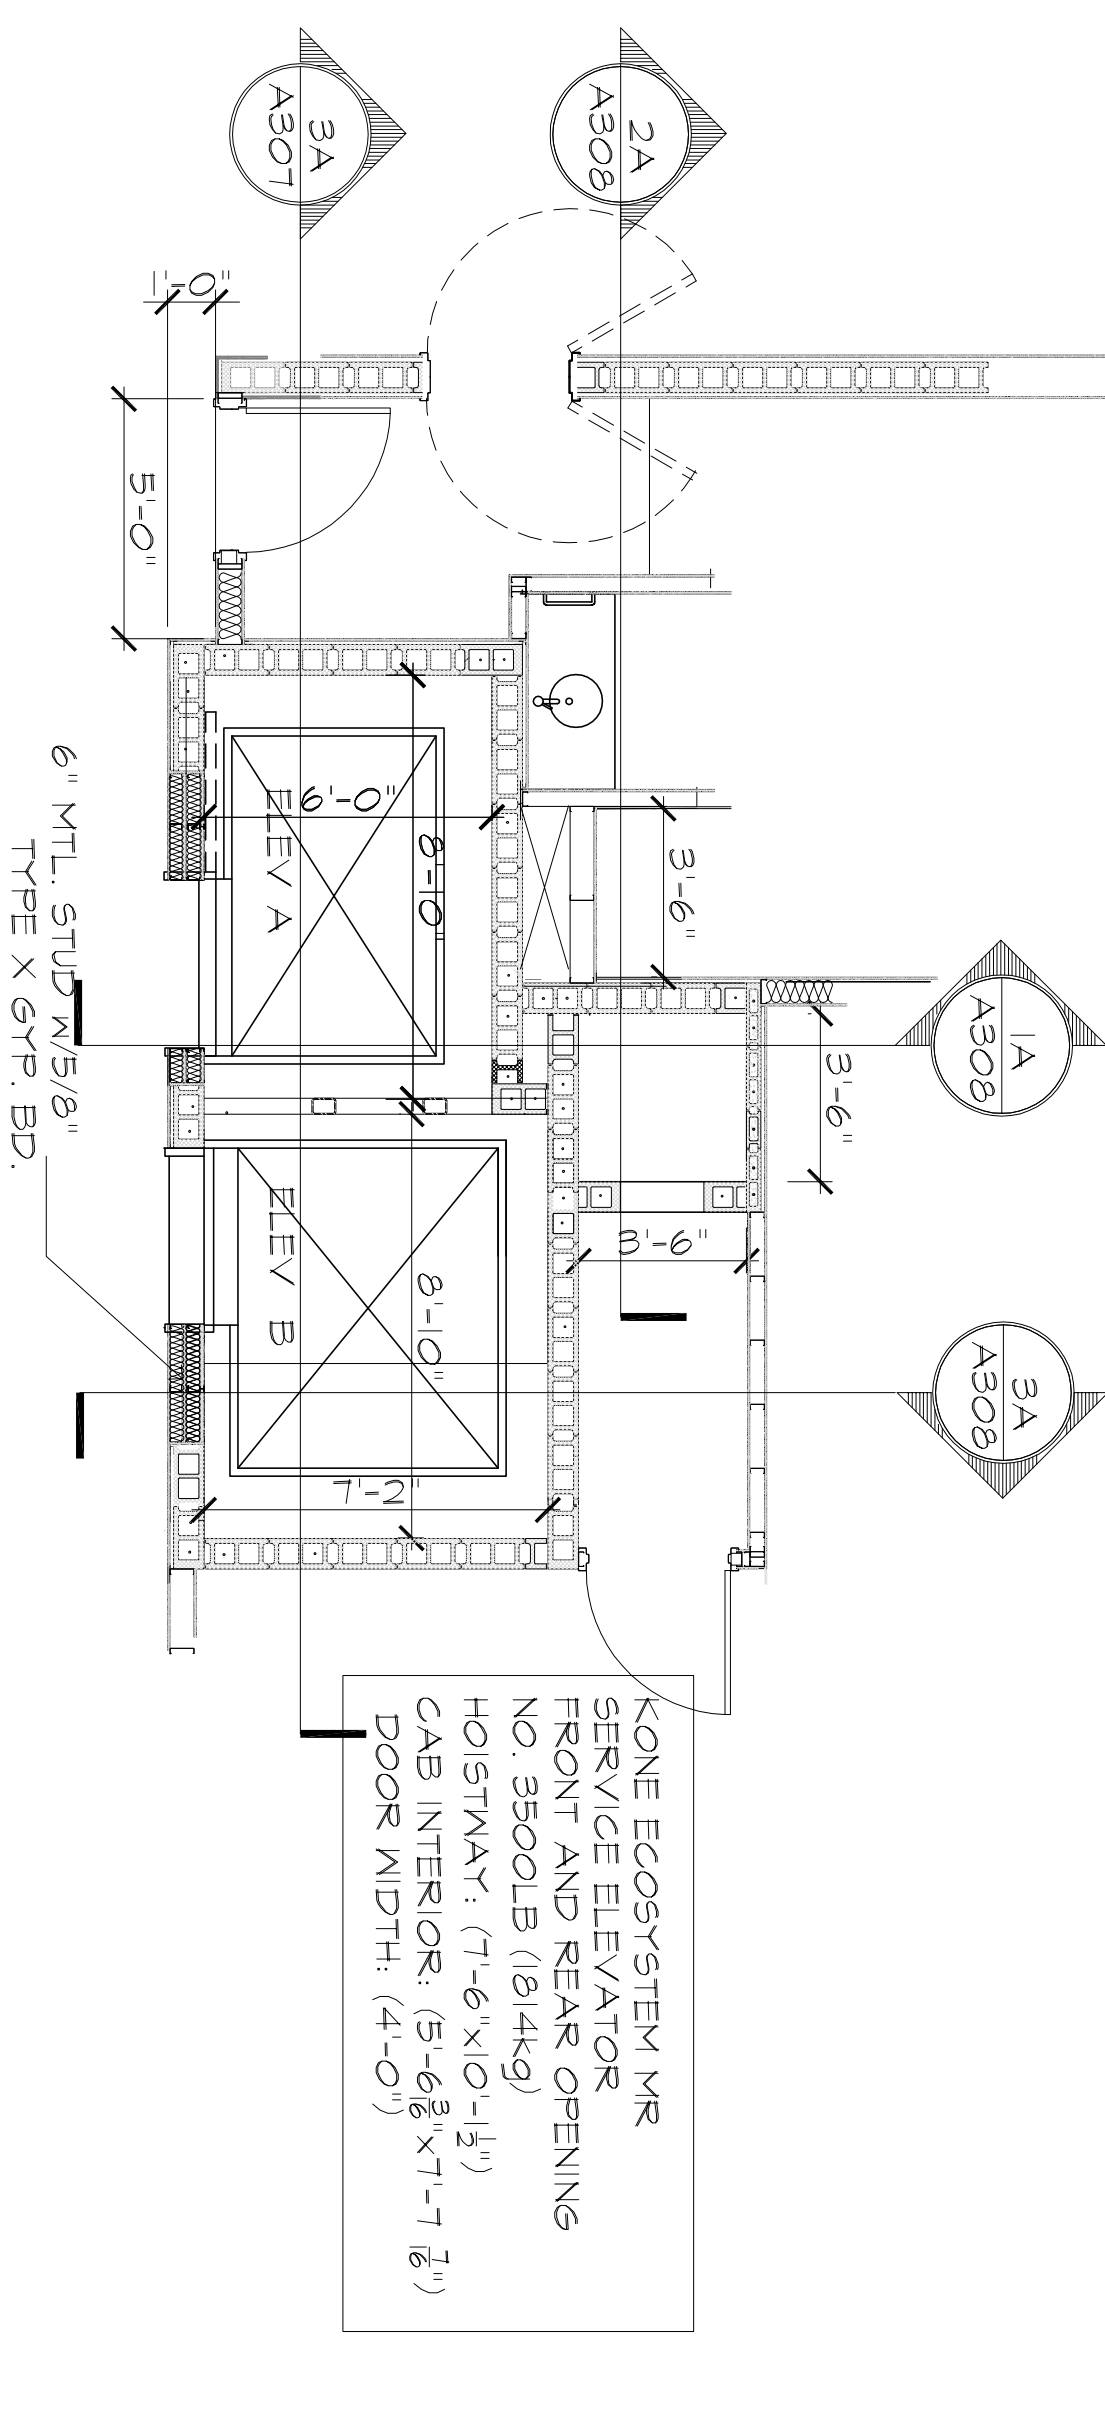
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DRAWING NUMBER:	A306
DRAWN BY/CHK:	BBC
CHECKED BY:	BBC
DATE:	12-22-15
SCALE:	AS NOTED

PROJECT NUMBER:	15180
DRAWING NAME:	
SHEET NAME:	
BUILDING SECTIONS:	







1C THIRD FLOOR PLAN - ELEVATOR & LAUNDRY CHUTE  
SCALE 1/4"=1'-0"



1B SECOND FLOOR PLAN - ELEVATOR & LAUNDRY CHUTE  
SCALE 1/4"=1'-0"

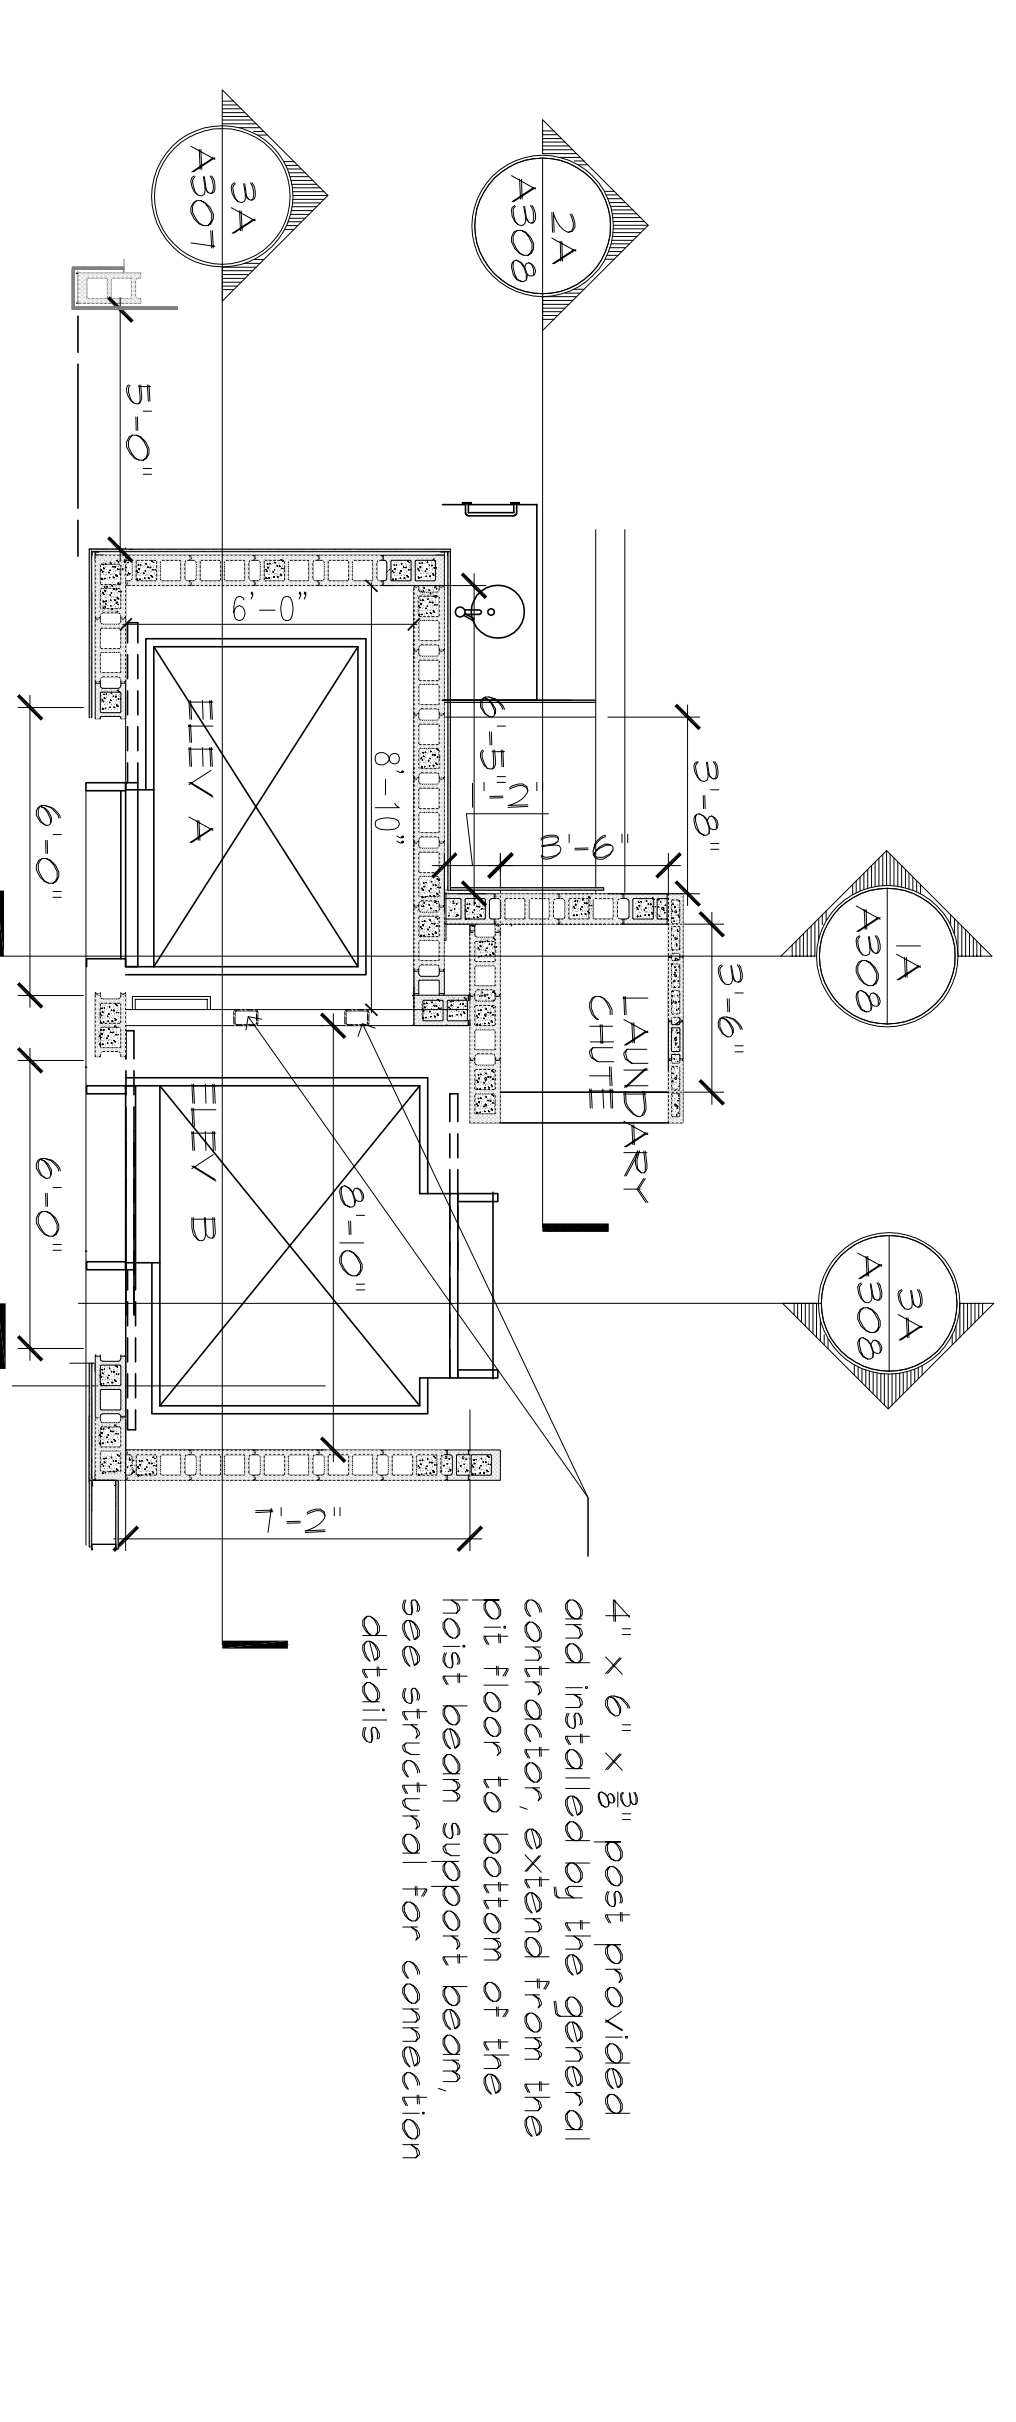

1A FIRST FLOOR PLAN - ELEVATOR & LAUNDRY CHUTE  
SCALE 1/4"=1'-0"

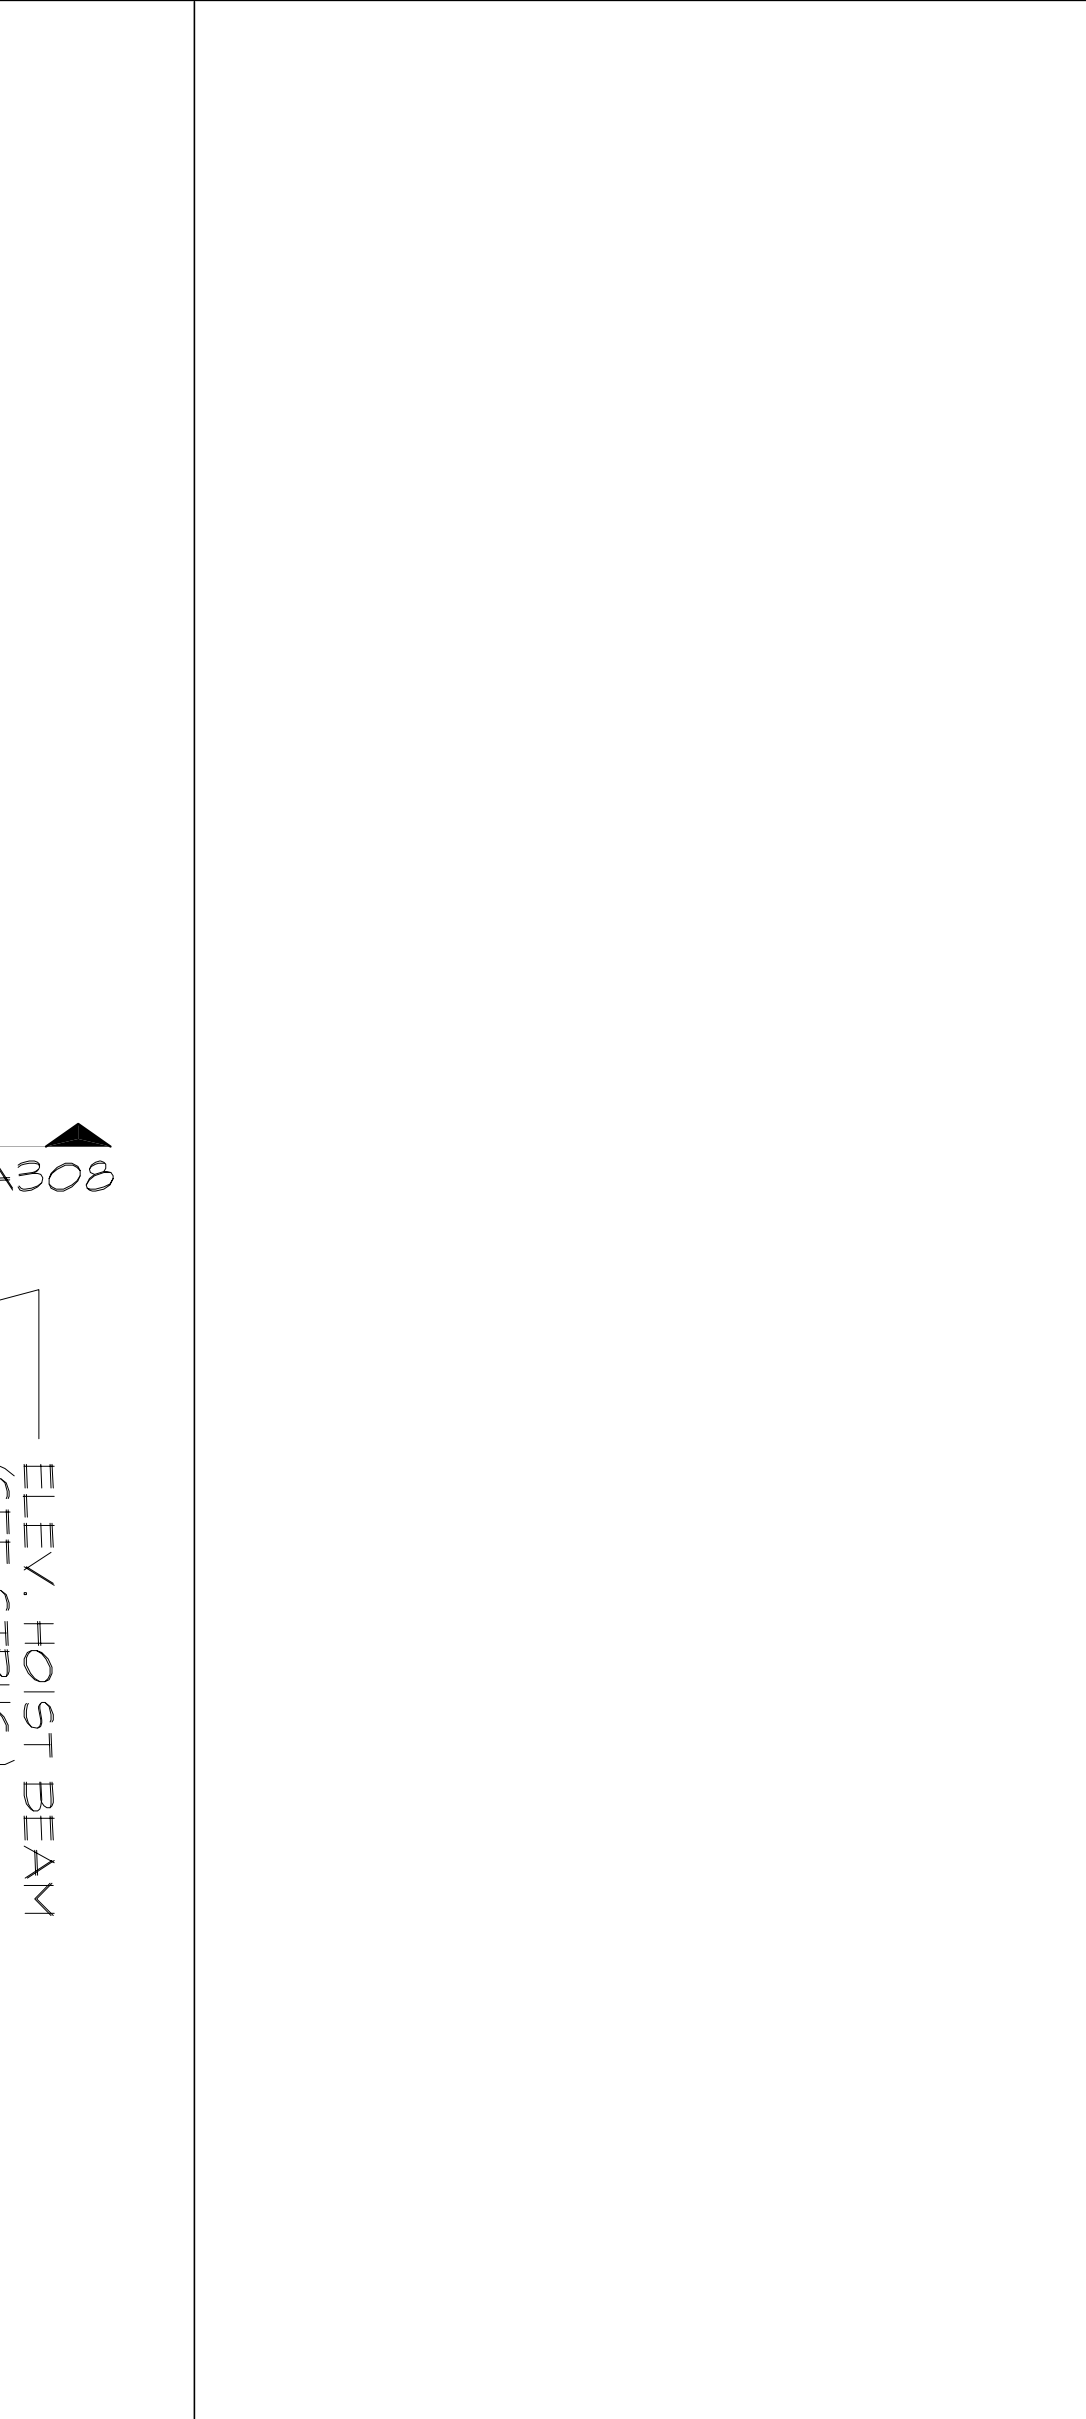

3A BUILDING SECTION @ ELEVATOR  
SCALE 3/8"=1'-0"

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NO.	DATE	DESCRIPTION
1	09/22/2015	30% REVIEW SET
2	11/22/2015	50% REVIEW SET
3	12/22/2015	100% REVIEW SET

PROJECT NAME:

PROJECT NUMBER: 15180

DRAWING BY: BBC

CHECKED BY: BBC

DATE: 12-22-15

SCALE: AS NOTED

DRAWING NUMBER: A307

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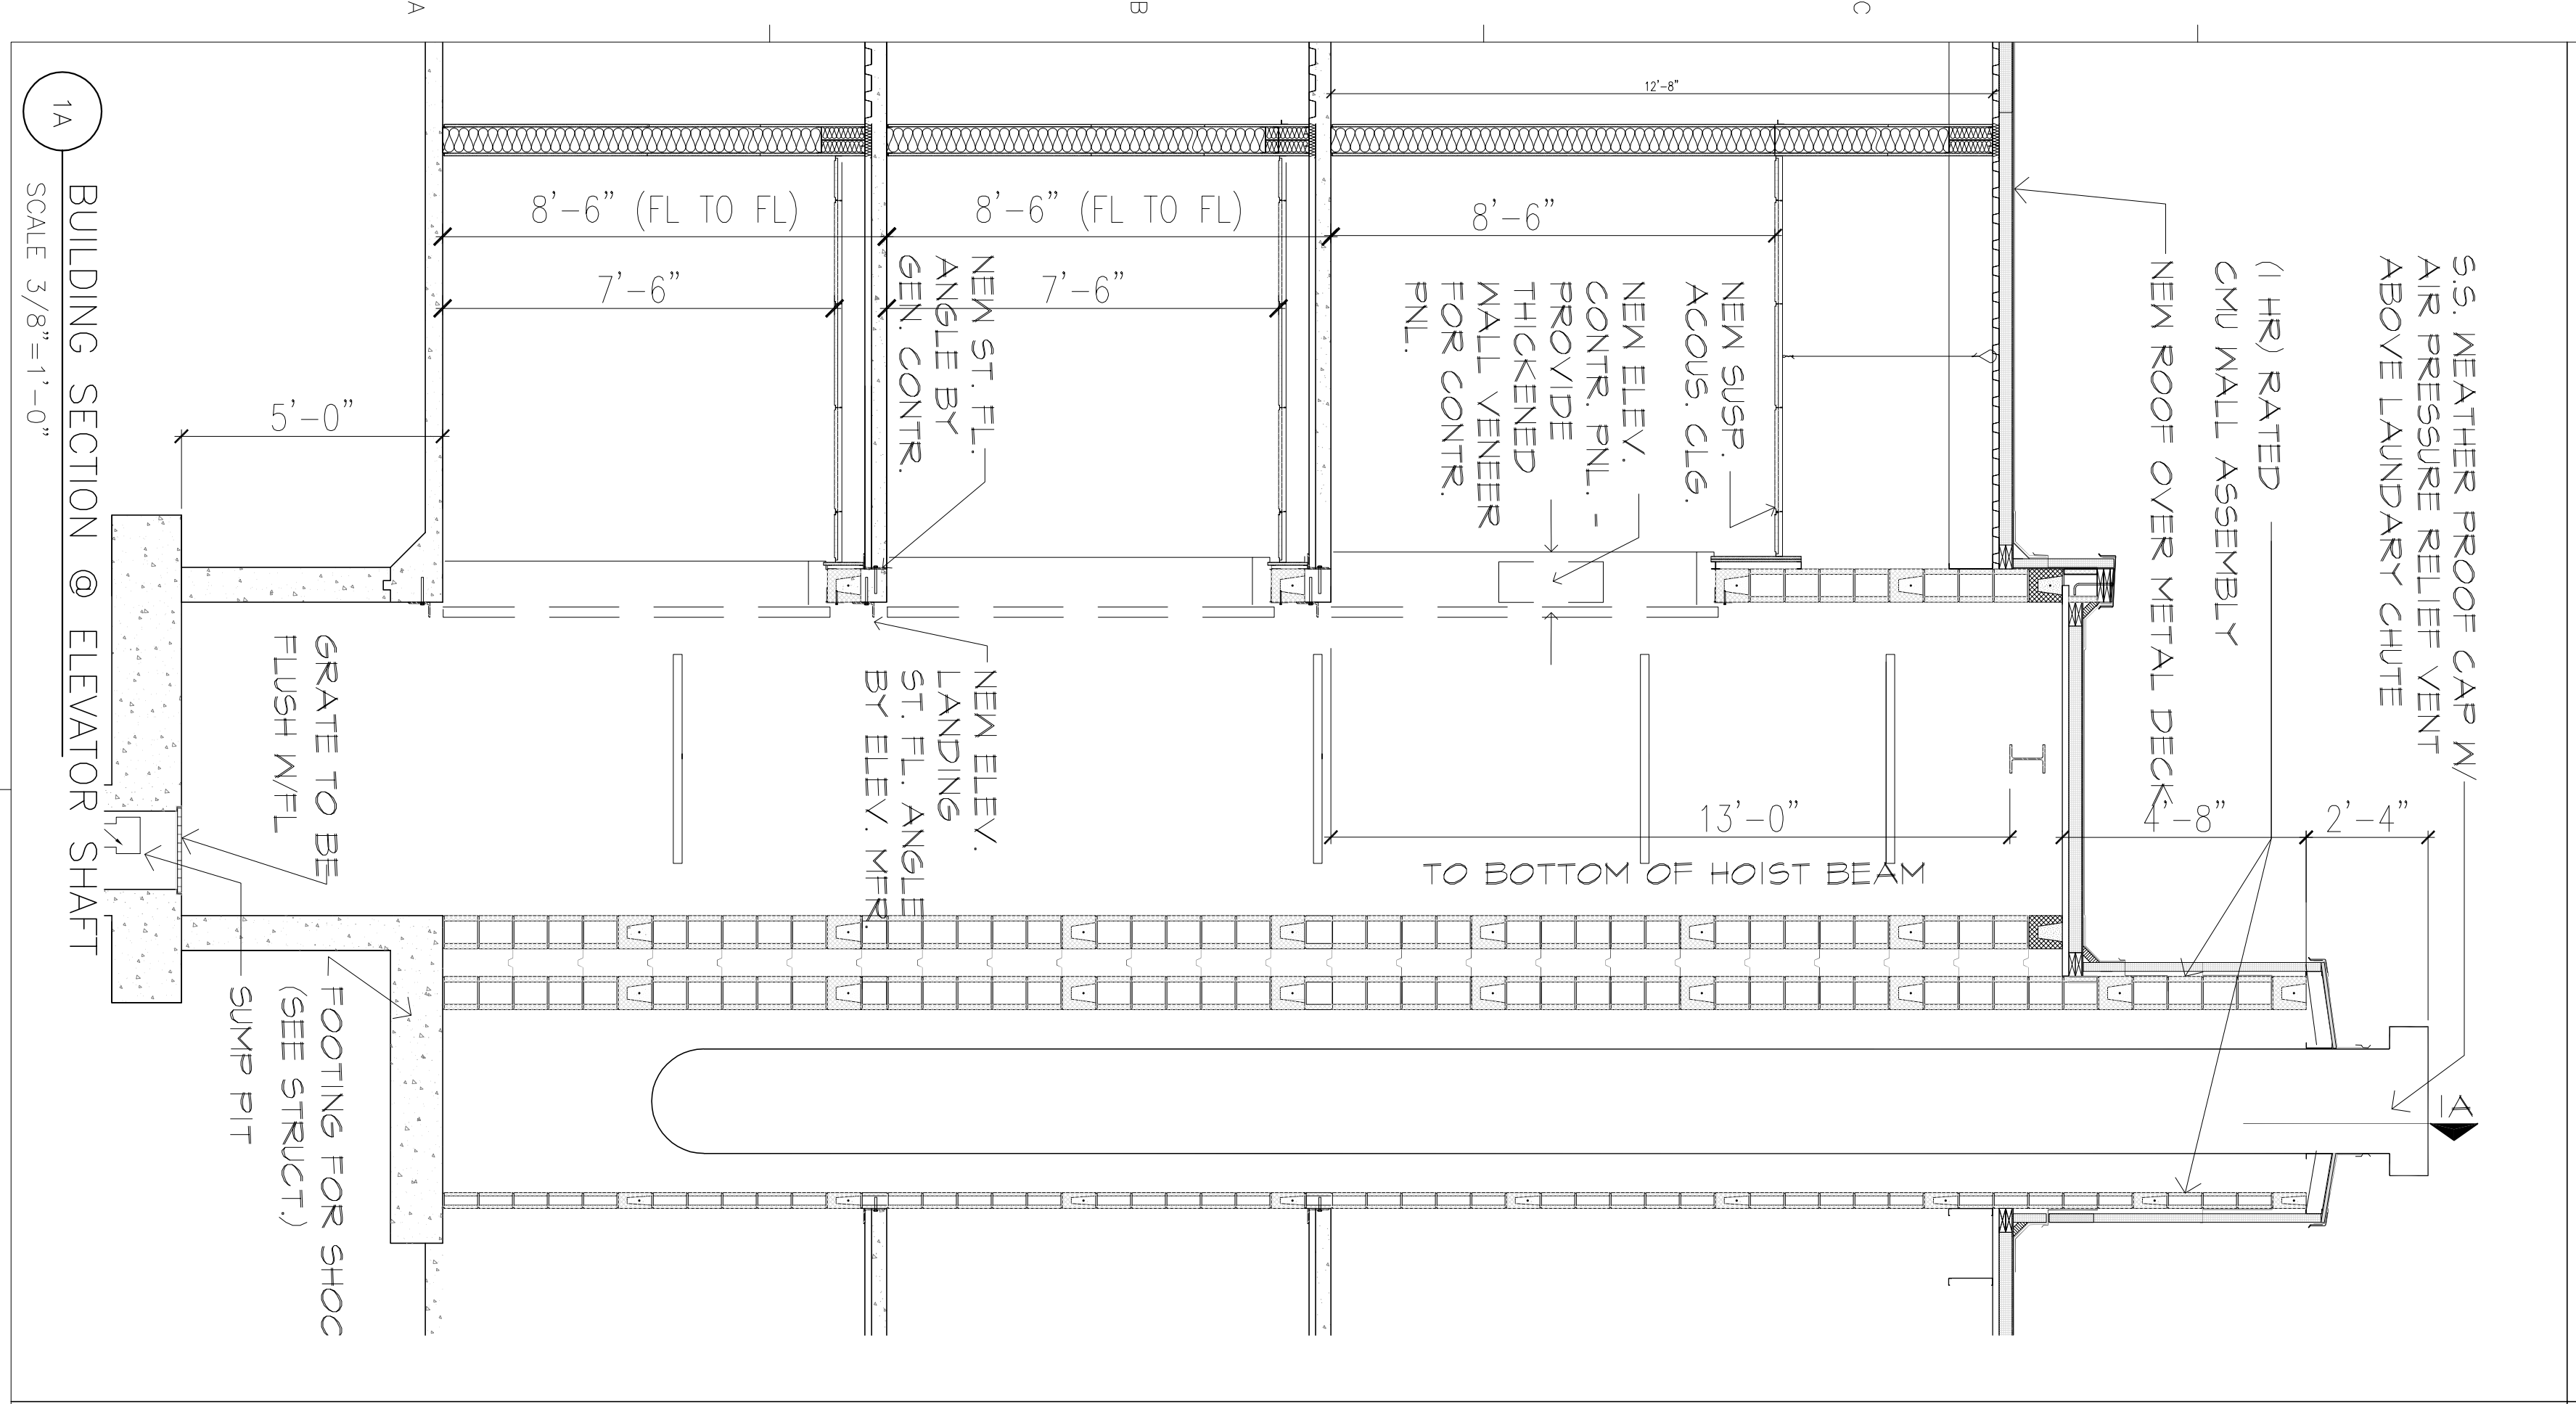
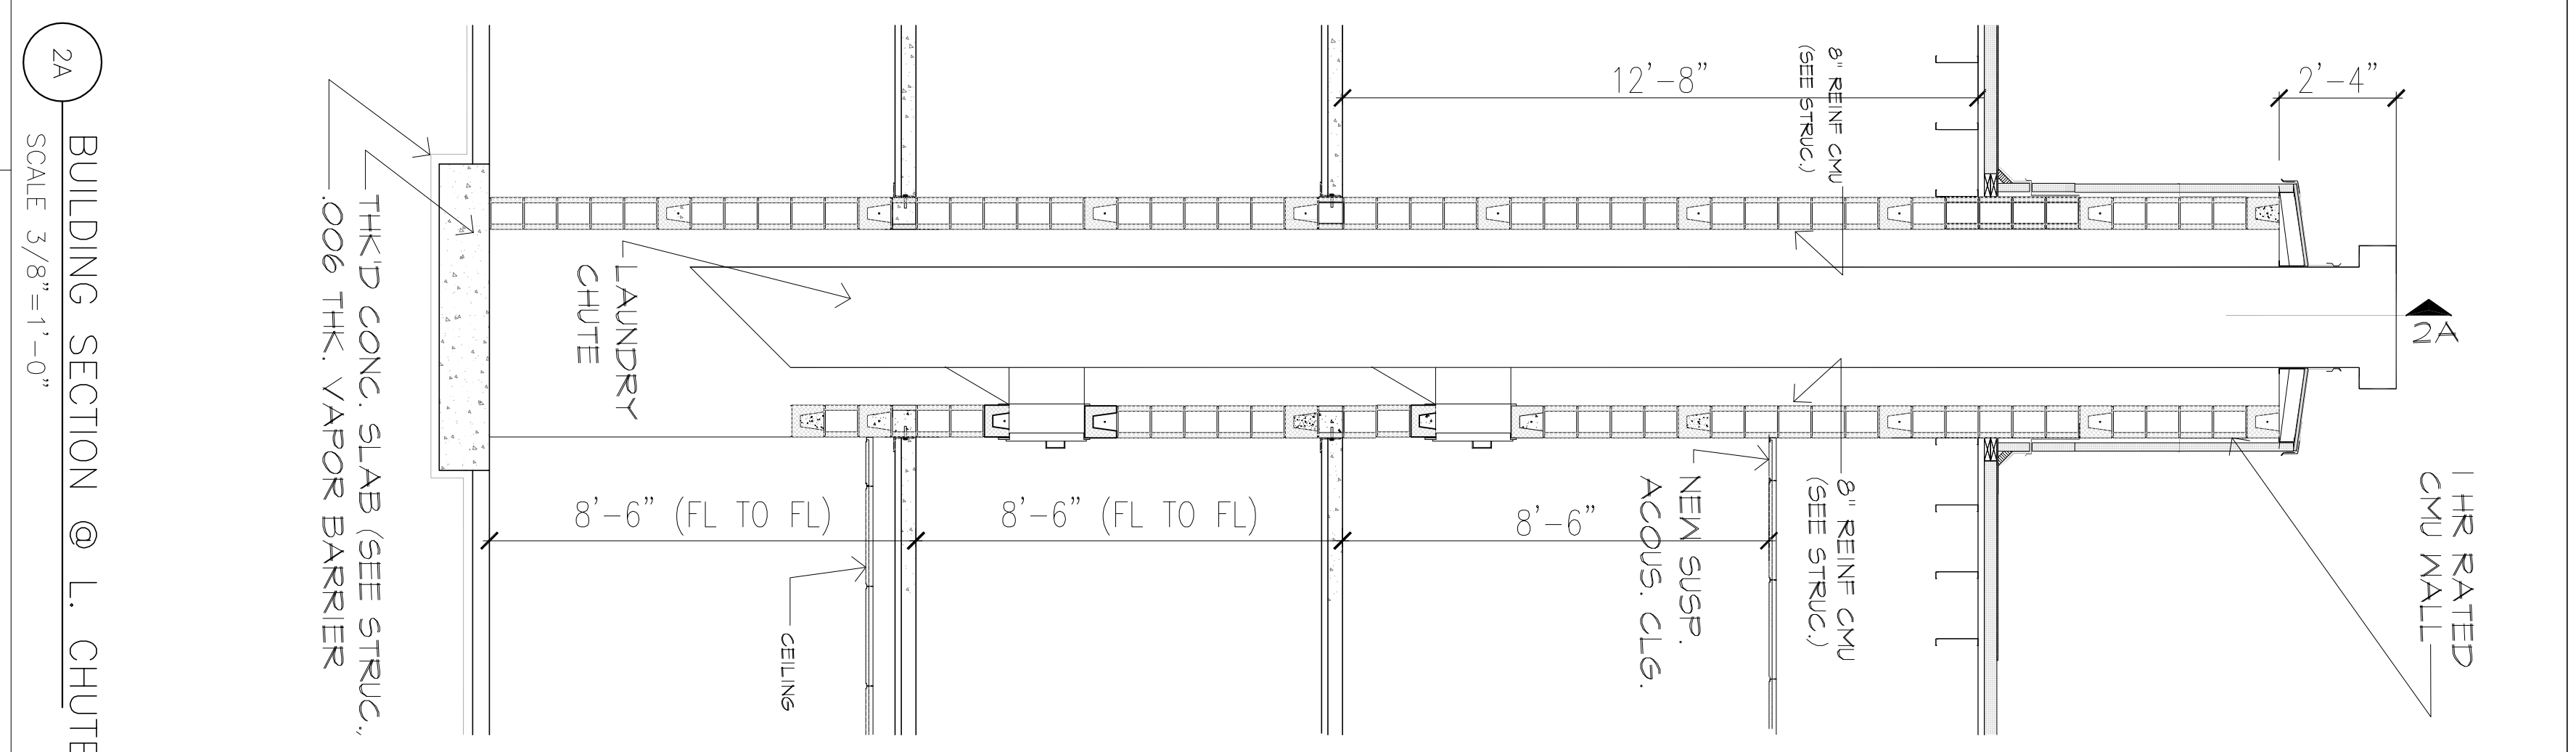
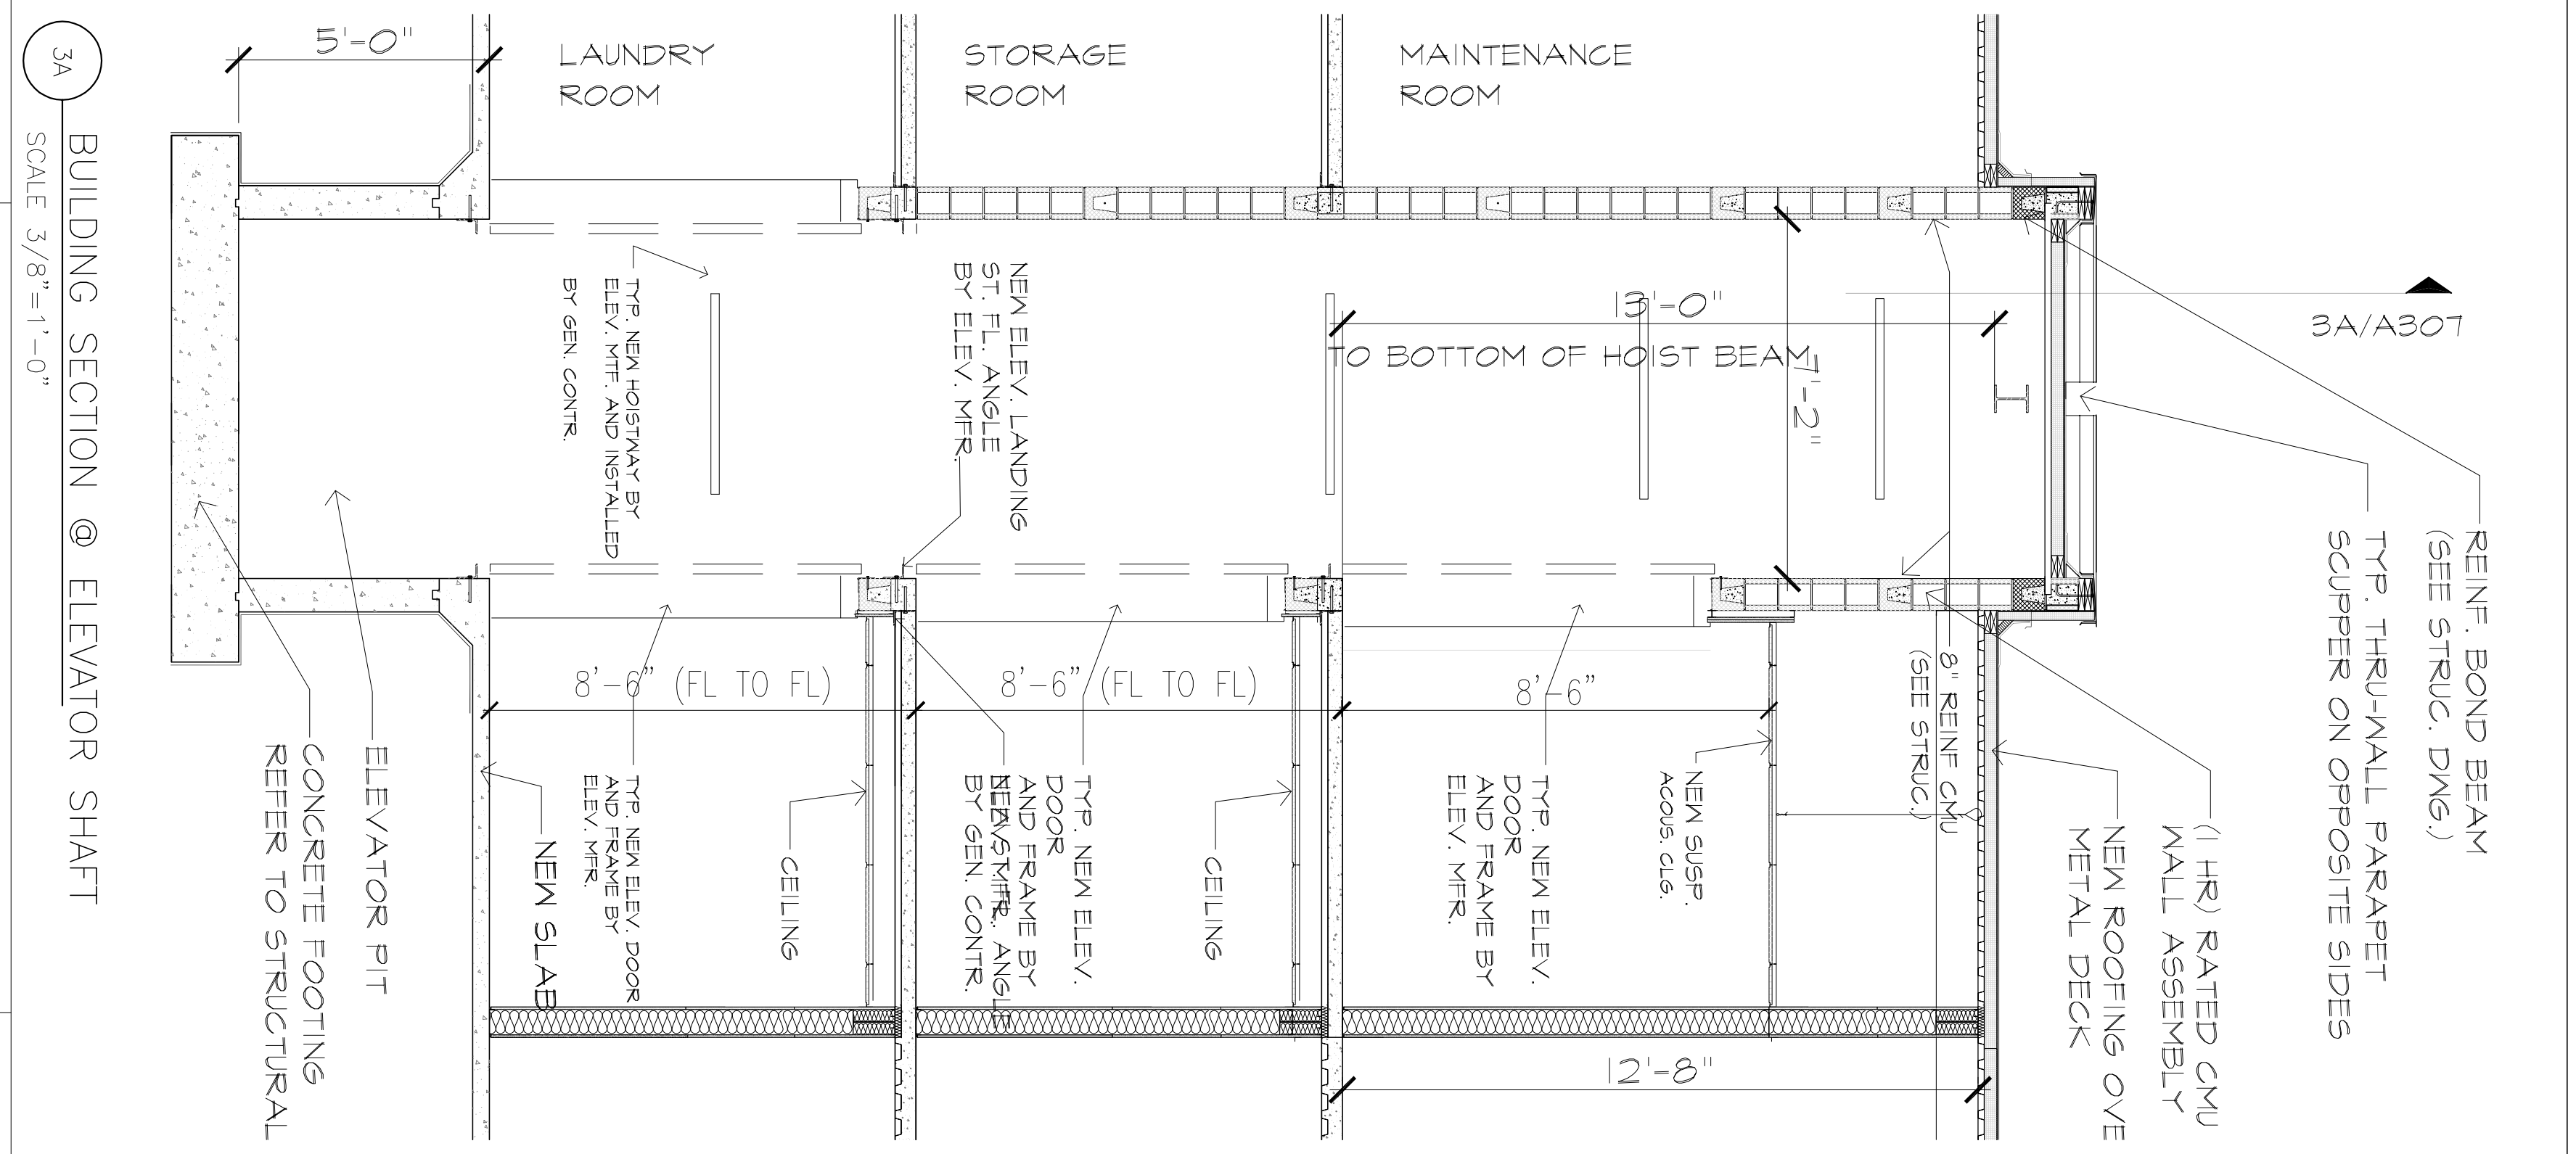
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 BY  
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 290 POWER DRIVE,  
 BATESVILLE, MS 38606

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**CONSTRUCTION**

NO.	DATE	DESCRIPTION
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2	11/22/15	50% REVIEW SET
3	12/22/15	100% REVIEW SET


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DRAWING NAME:	
SHEET NAME:	SECTIONS - ELEVATOR & LAUNDRY CHUTE
DRAWN BY/CHK:	BBC
CHECKED BY:	BBC
DATE:	12-22-15
SCALE:	AS NOTED
DRAWING NUMBER:	<b>A308</b>




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 SCALE 3/8"=1'-0"

2A BUILDING SECTION @ L. CHUTE  
 SCALE 3/8"=1'-0"


3A BUILDING SECTION @ ELEVATOR SHAFT  
 SCALE 3/8"=1'-0"

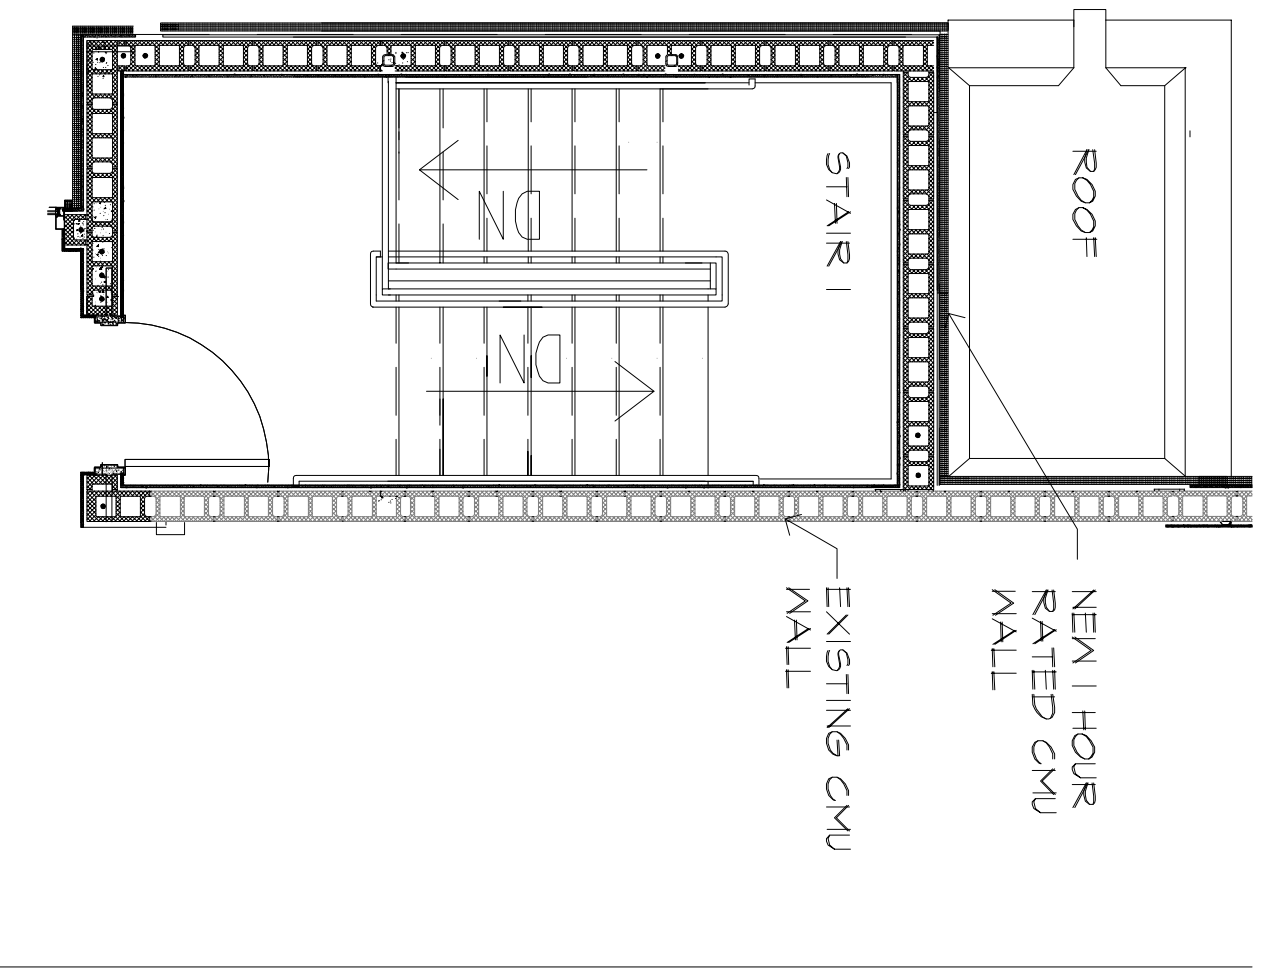


1C STAIR 1 PLAN @ THIRD FLOOR  
SCALE 1/4"=1'-0"

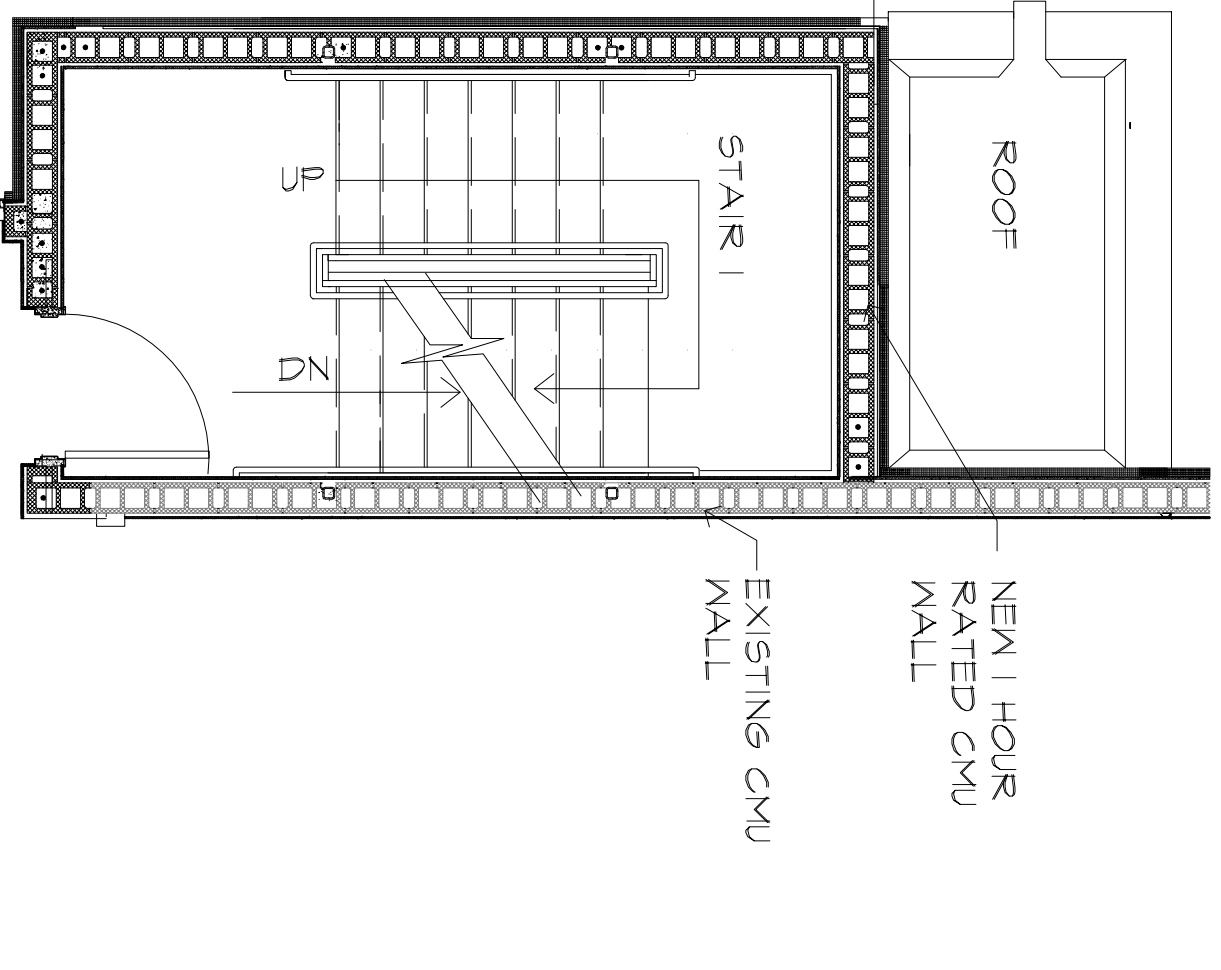


1B STAIR 1 PLAN @ SECOND FLOOR  
SCALE 1/4"=1'-0"

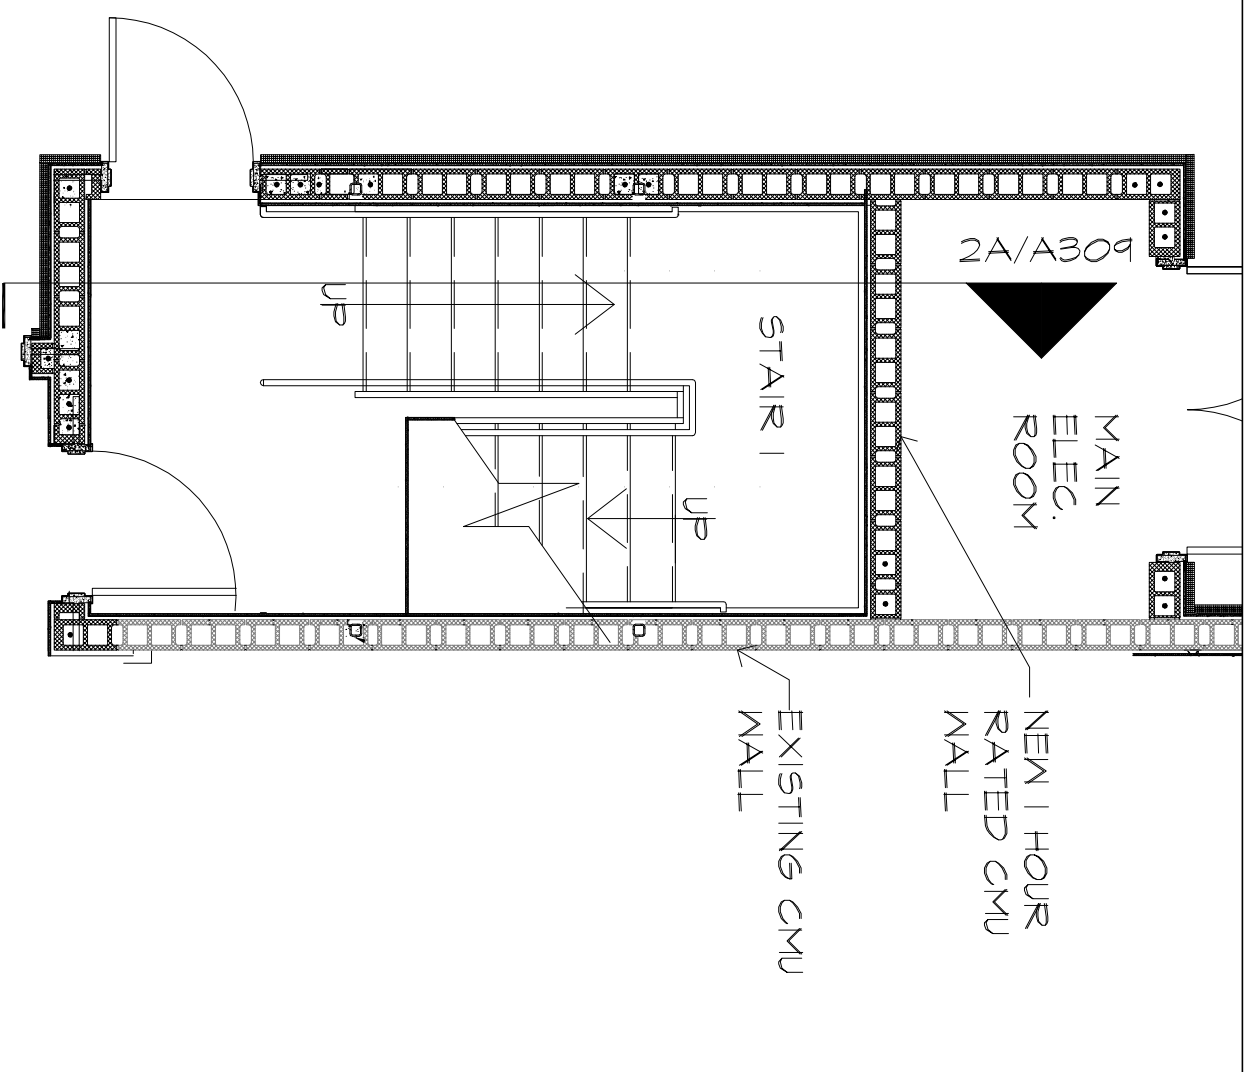


1A STAIR 1 PLAN @ FIRST FLOOR  
SCALE 1/4"=1'-0"

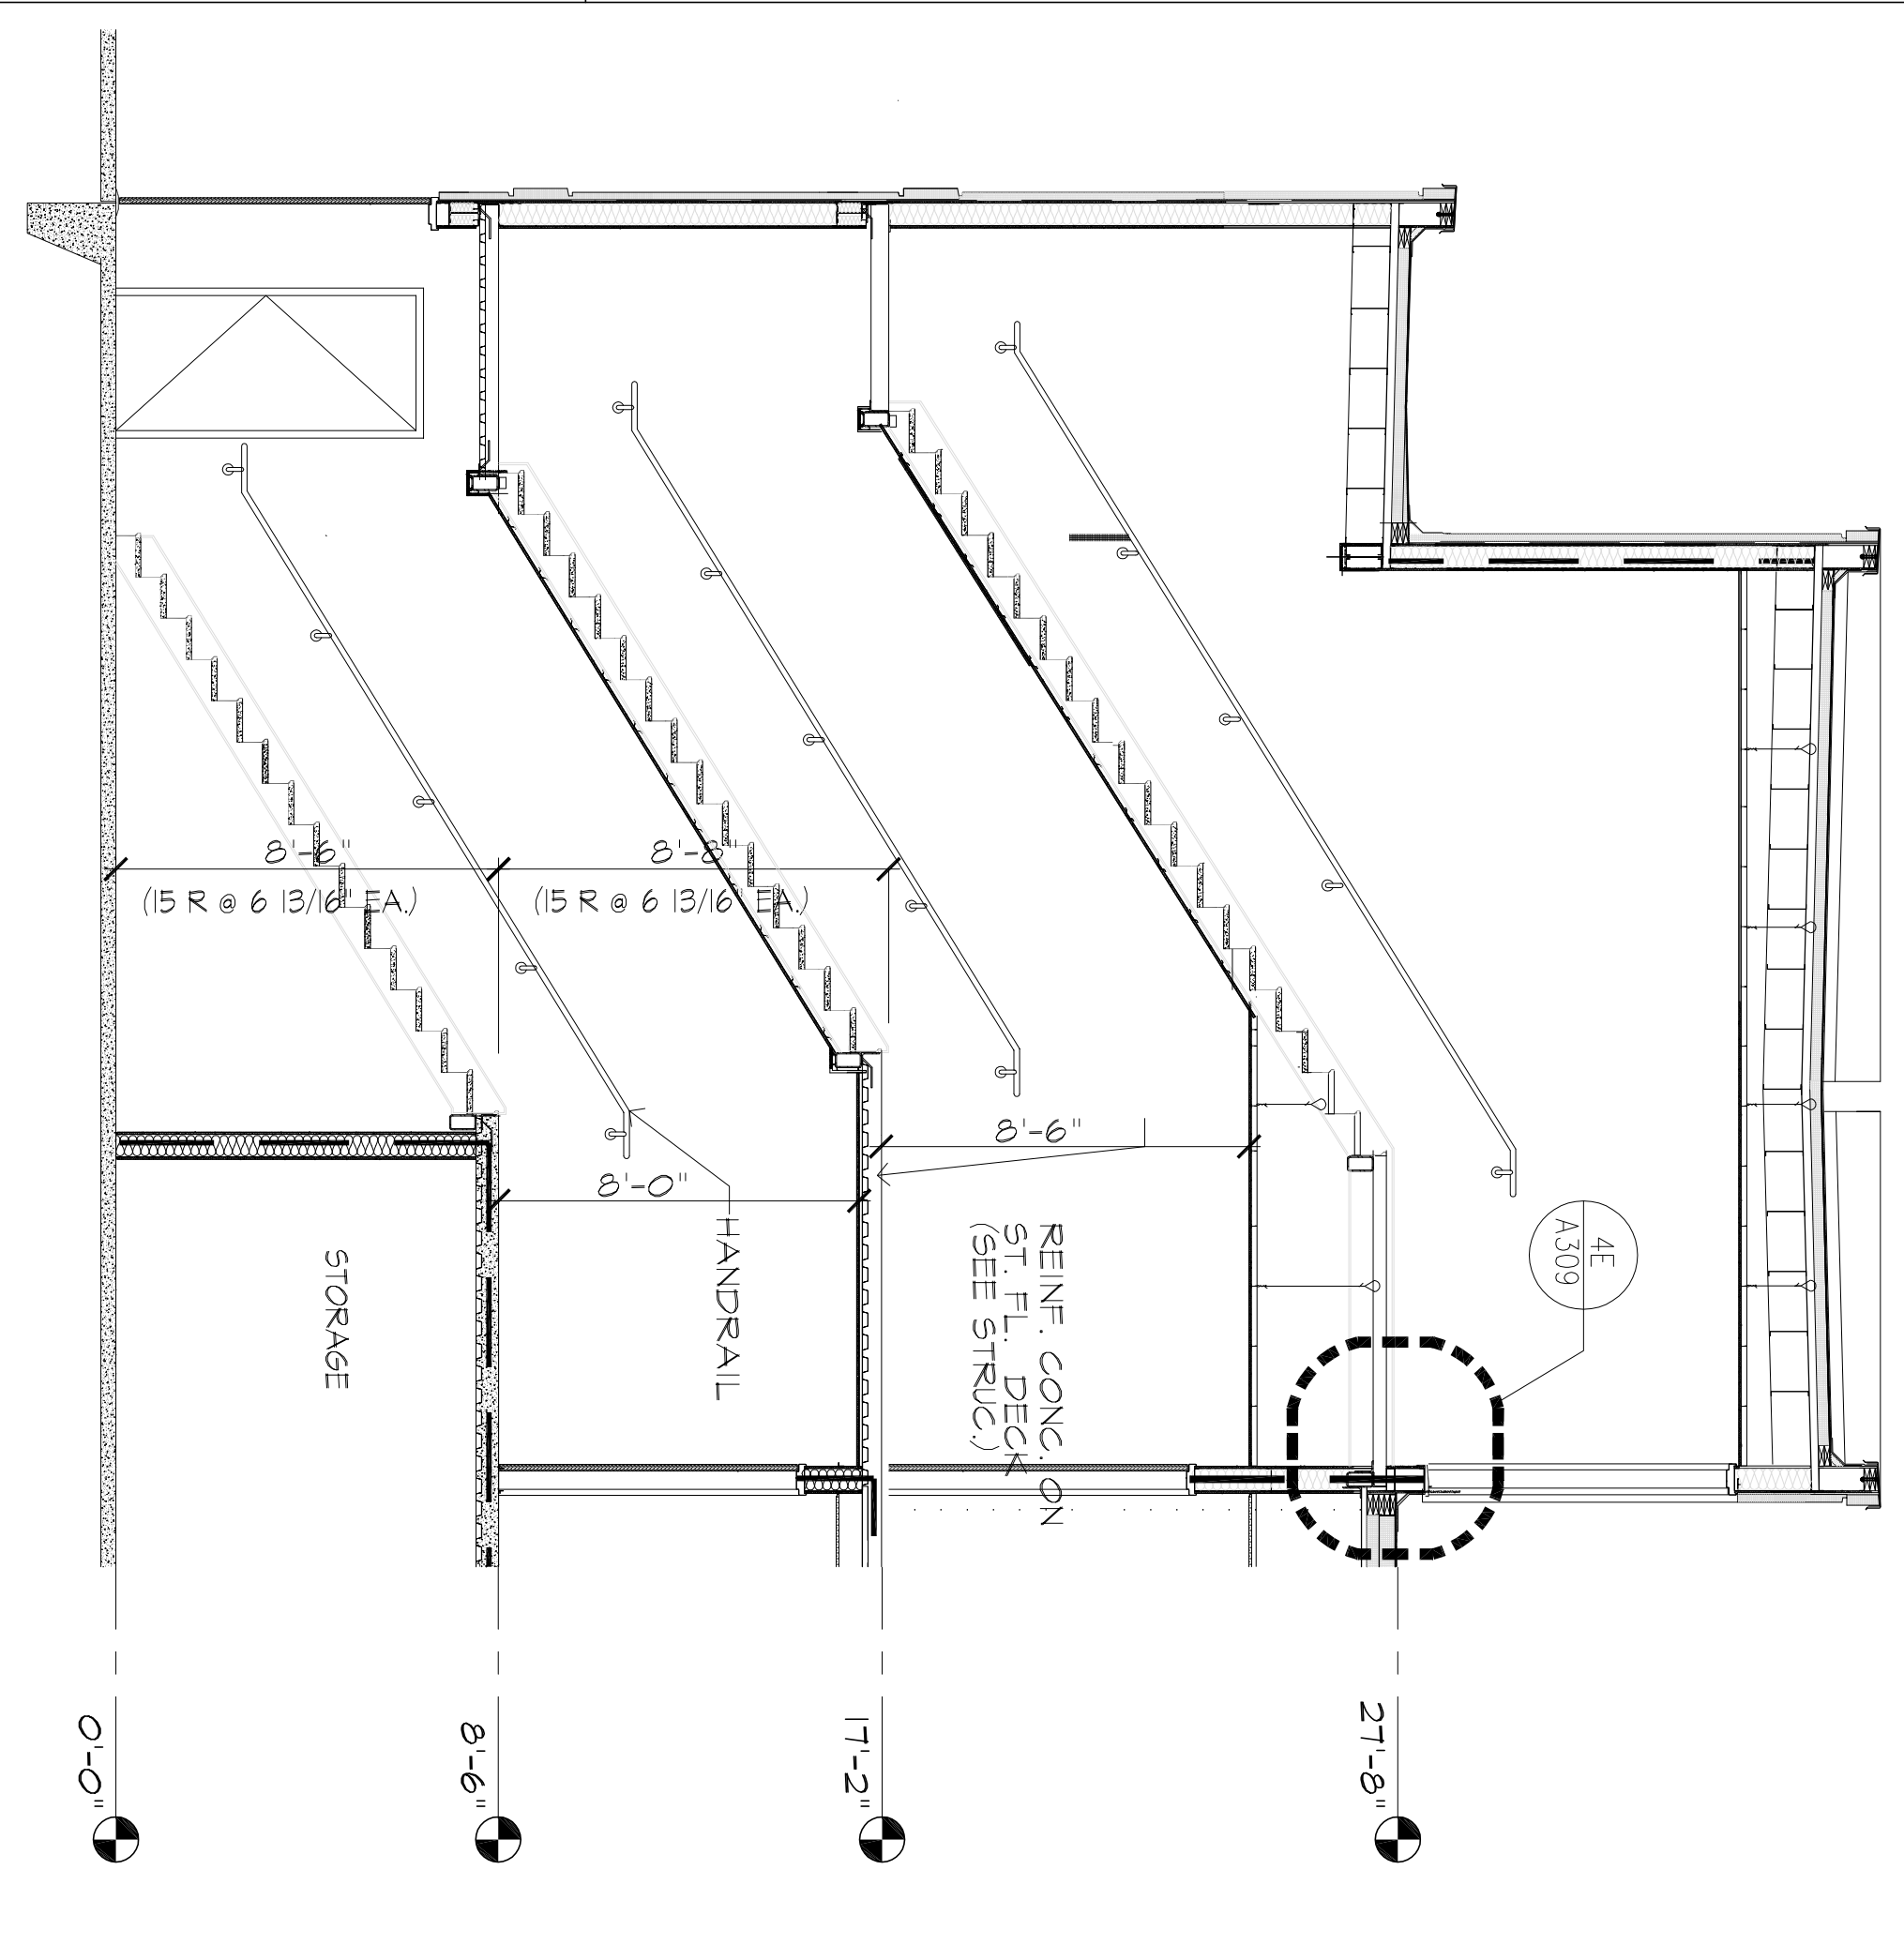


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SCALE 1/4"=1'-0"

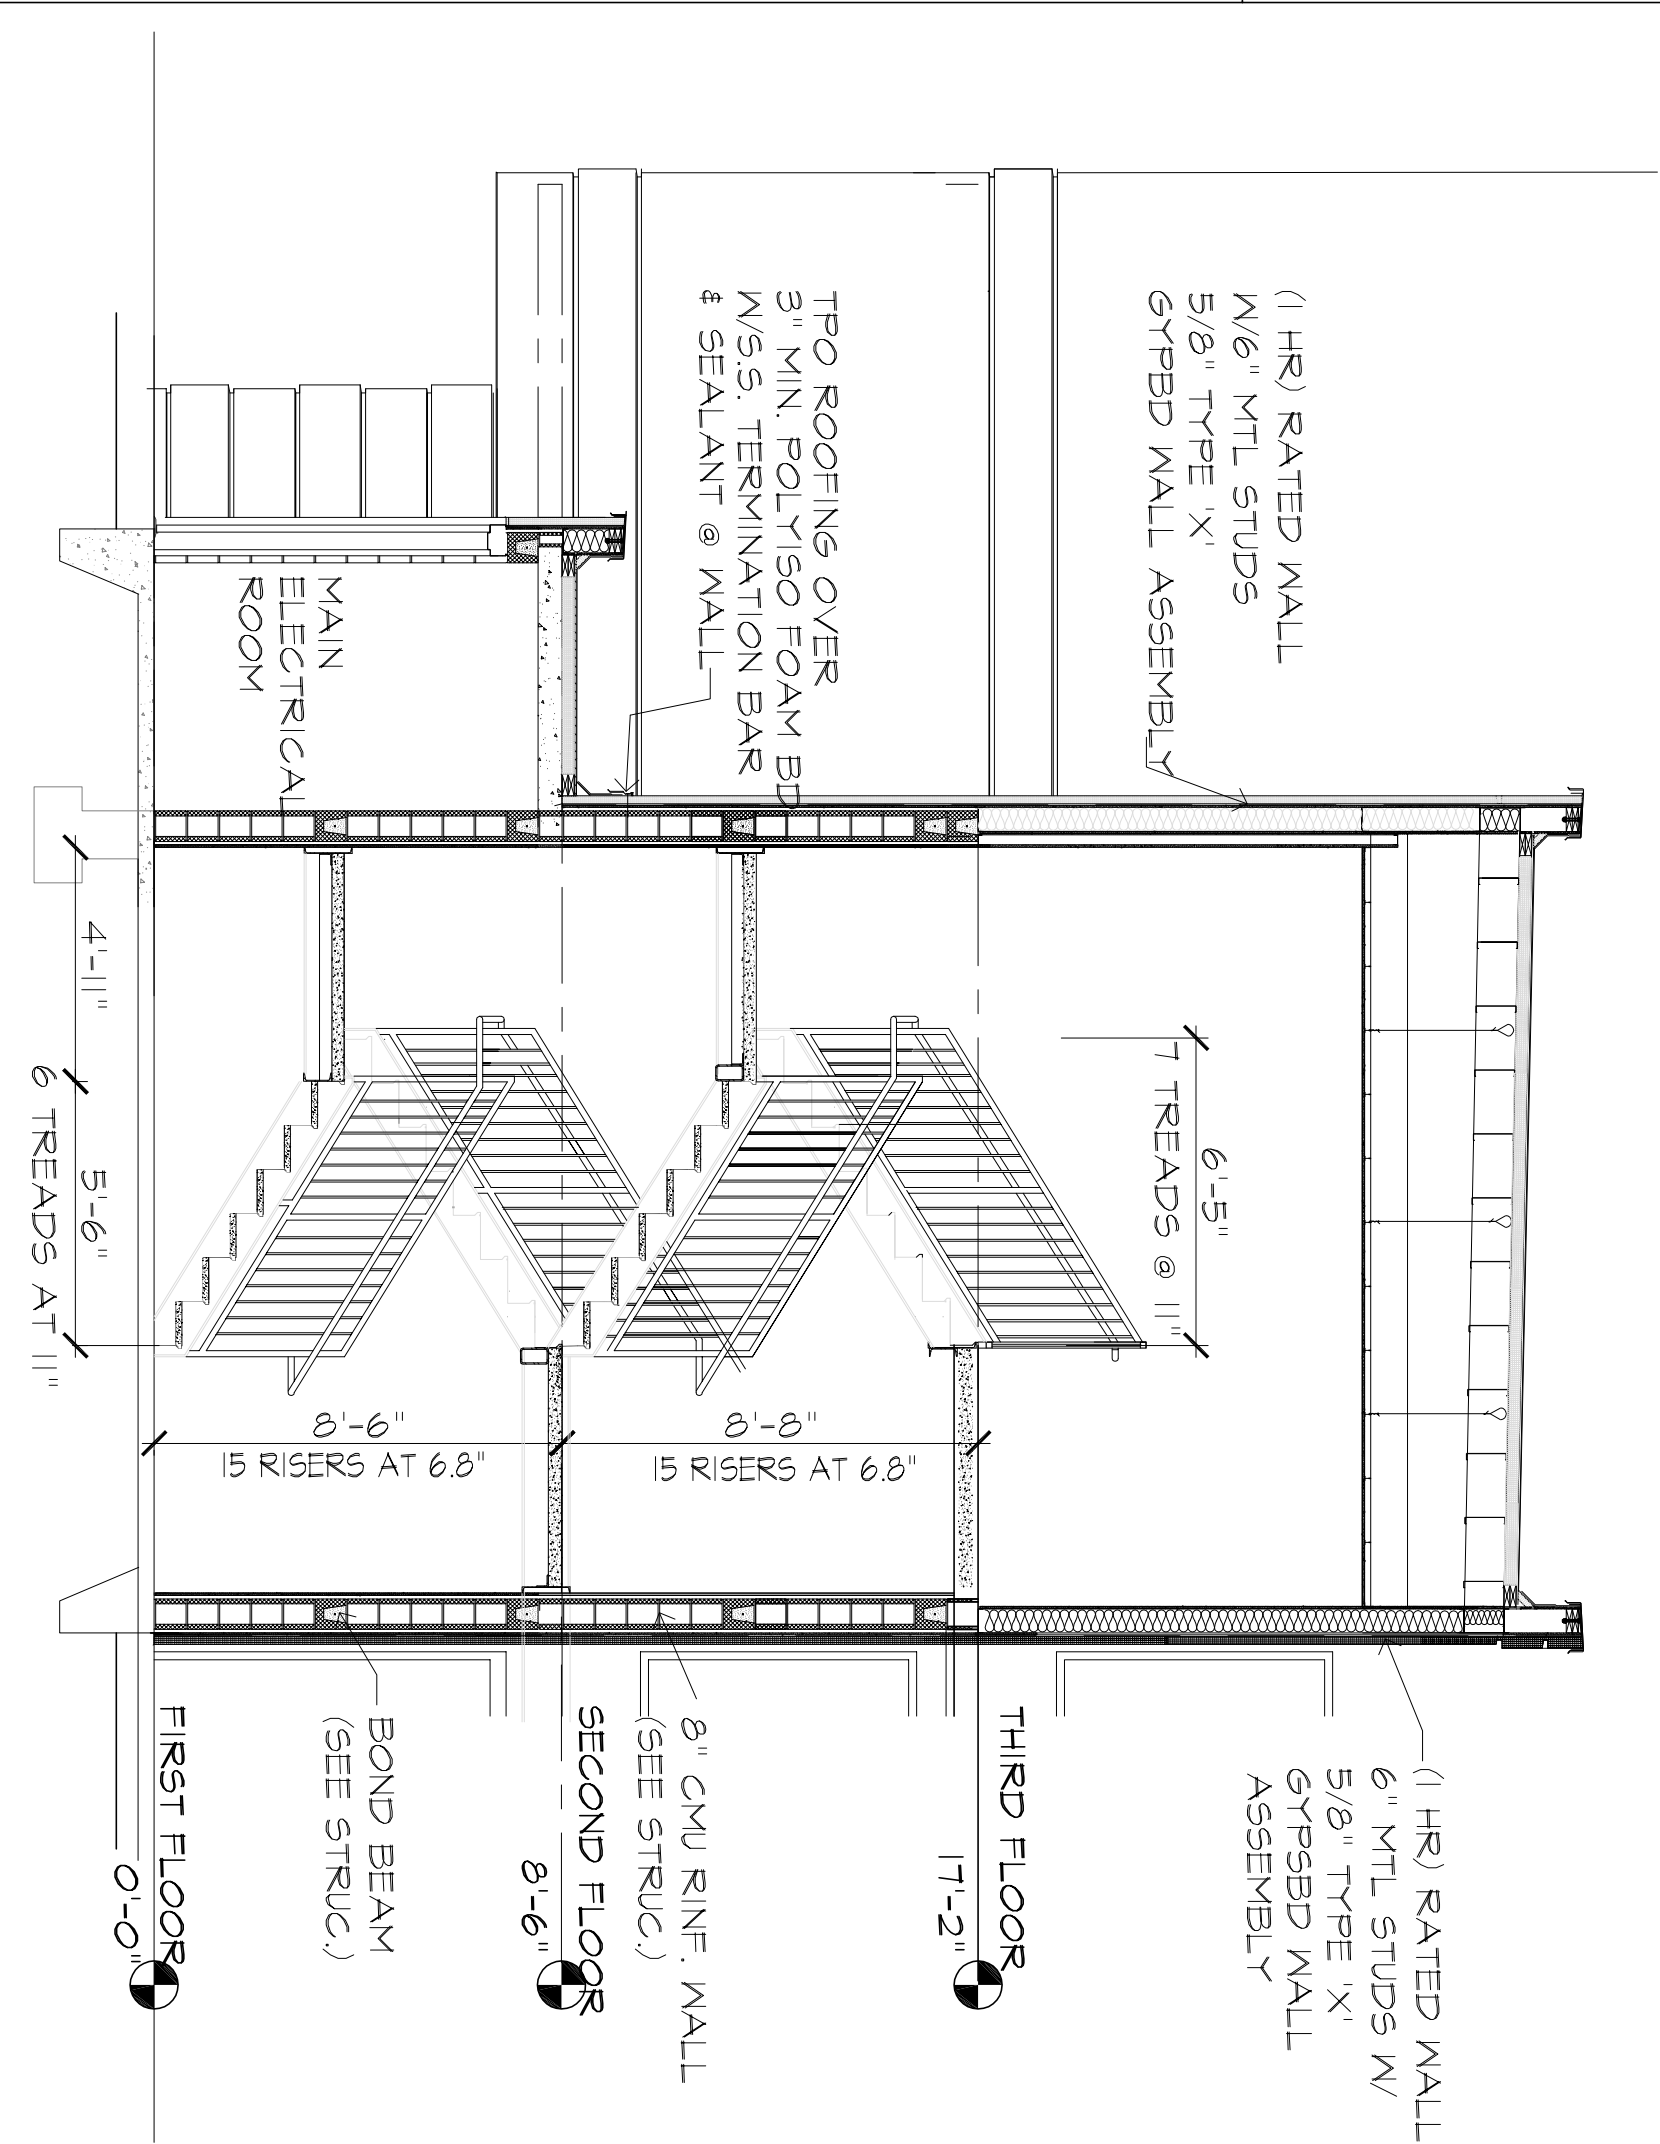


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SCALE 1/4"=1'-0"

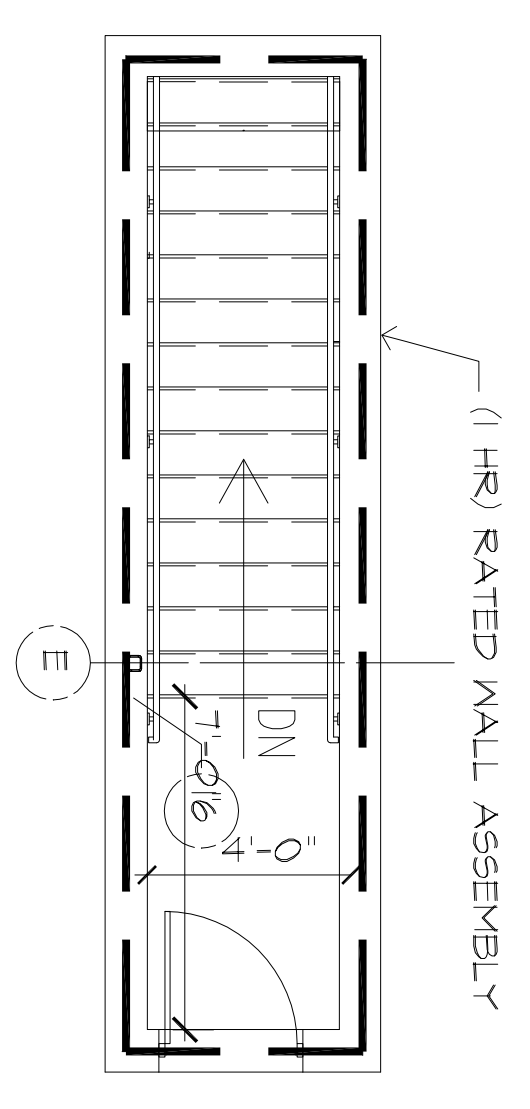


4D STAIR 2 PLAN @ ROOF PLAN  
SCALE 1/4"=1'-0"

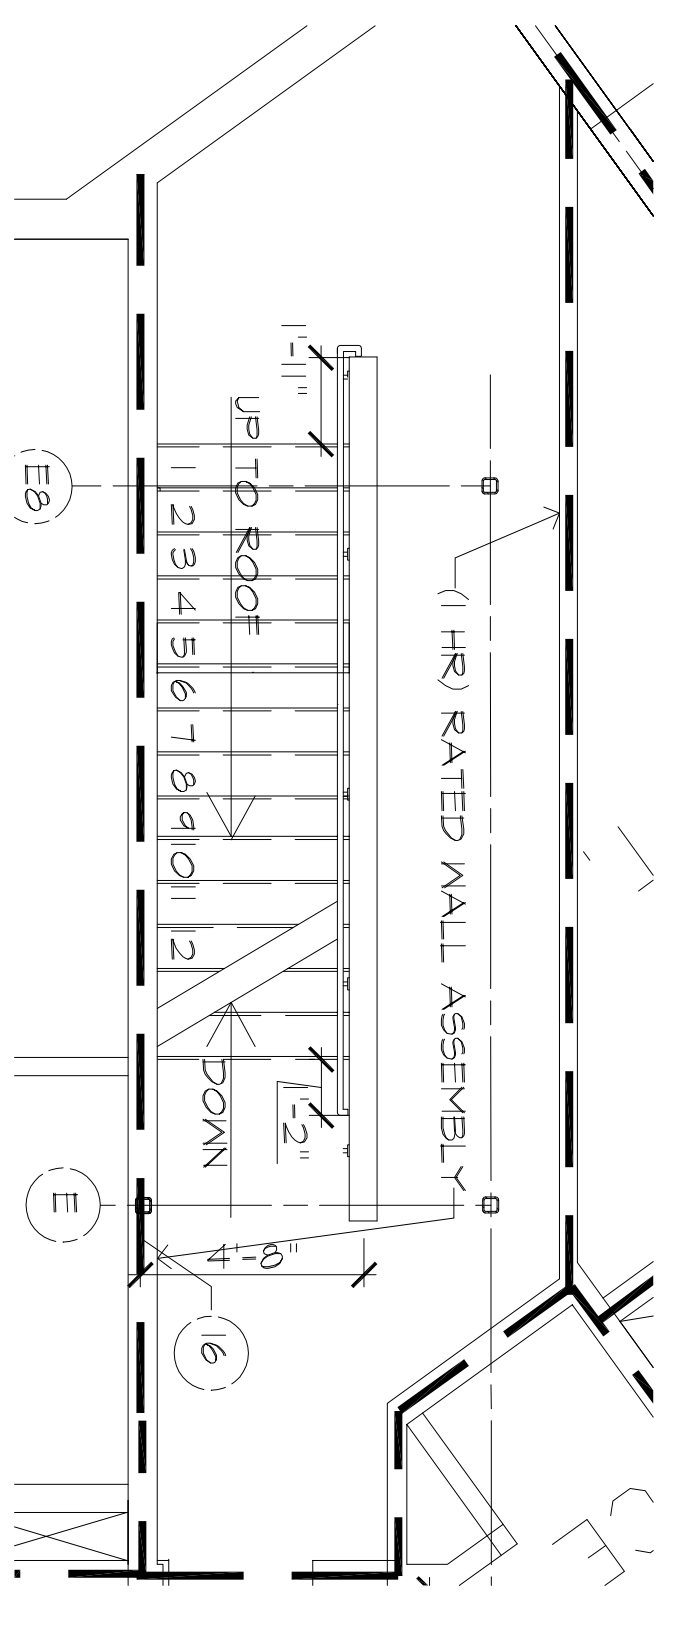

4C STAIR 2 PLAN @ THIRD FLOOR  
SCALE 1/4"=1'-0"

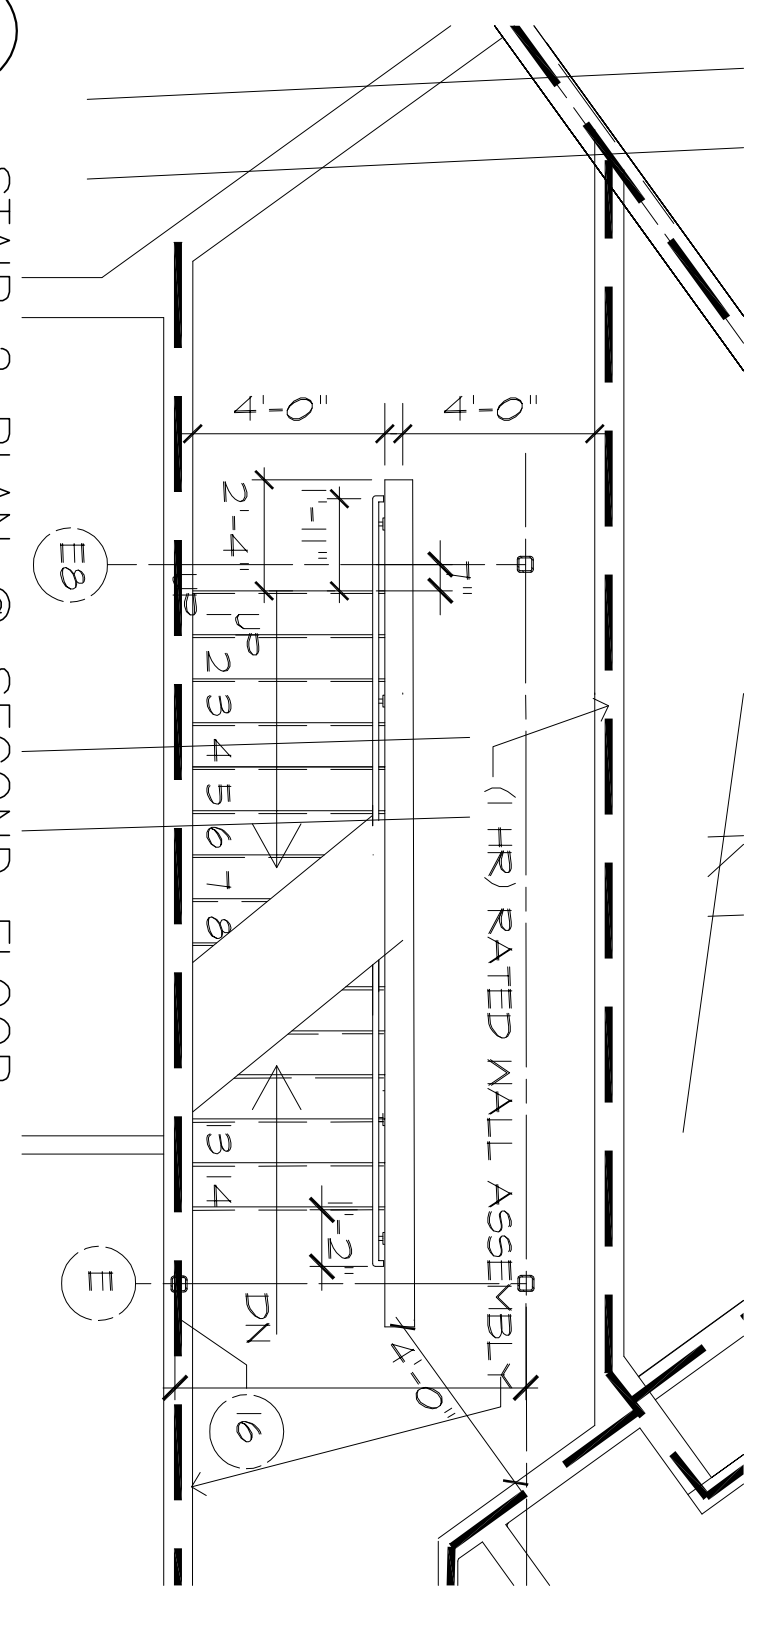

4B STAIR 2 PLAN @ SECOND FLOOR  
SCALE 1/4"=1'-0"

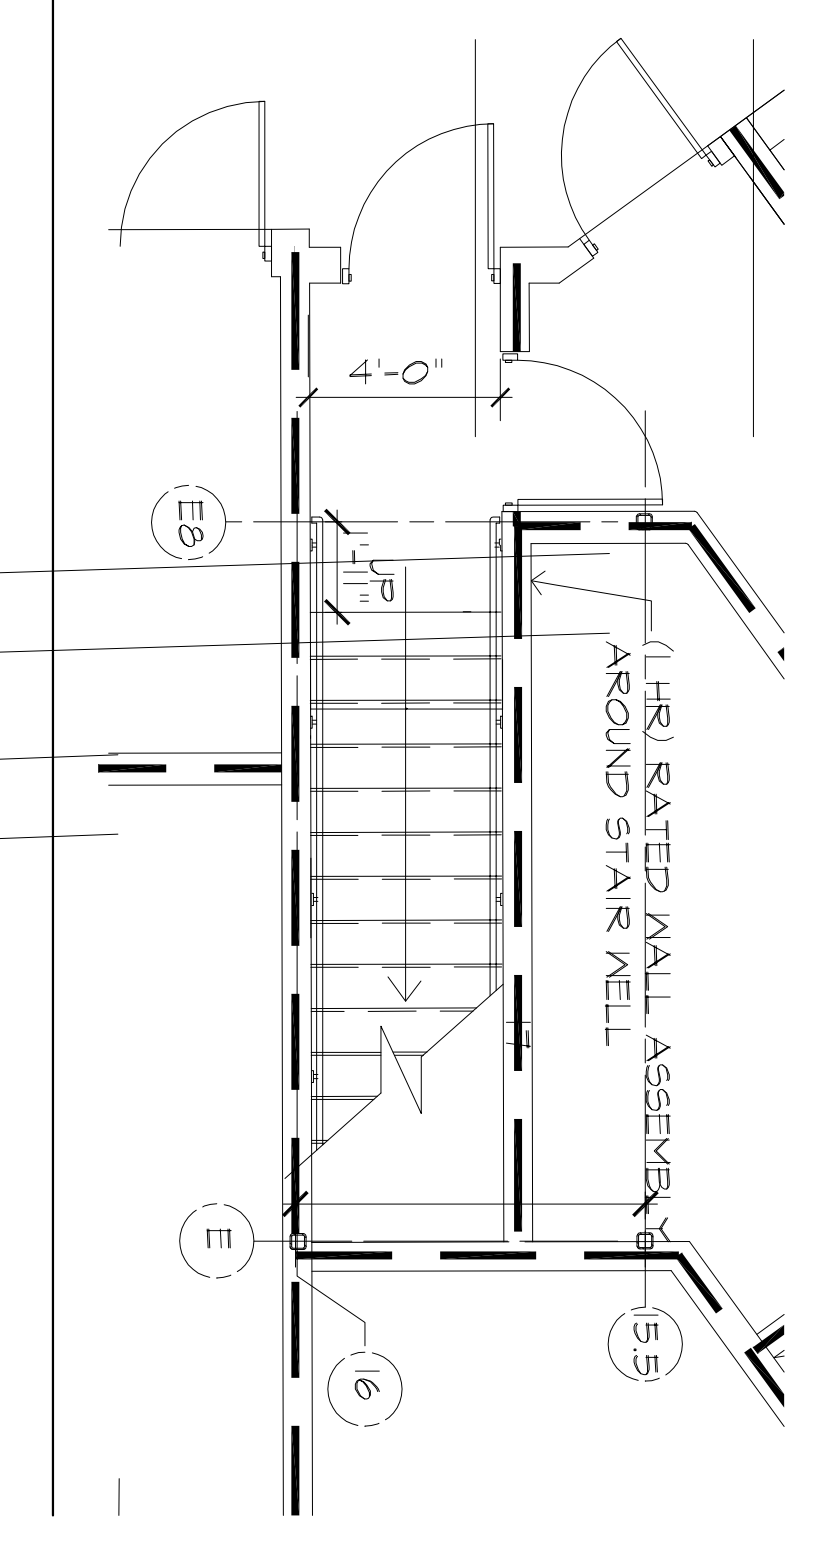

4A STAIR 2 PLAN @ FIRST FLOOR  
SCALE 1/4"=1'-0"

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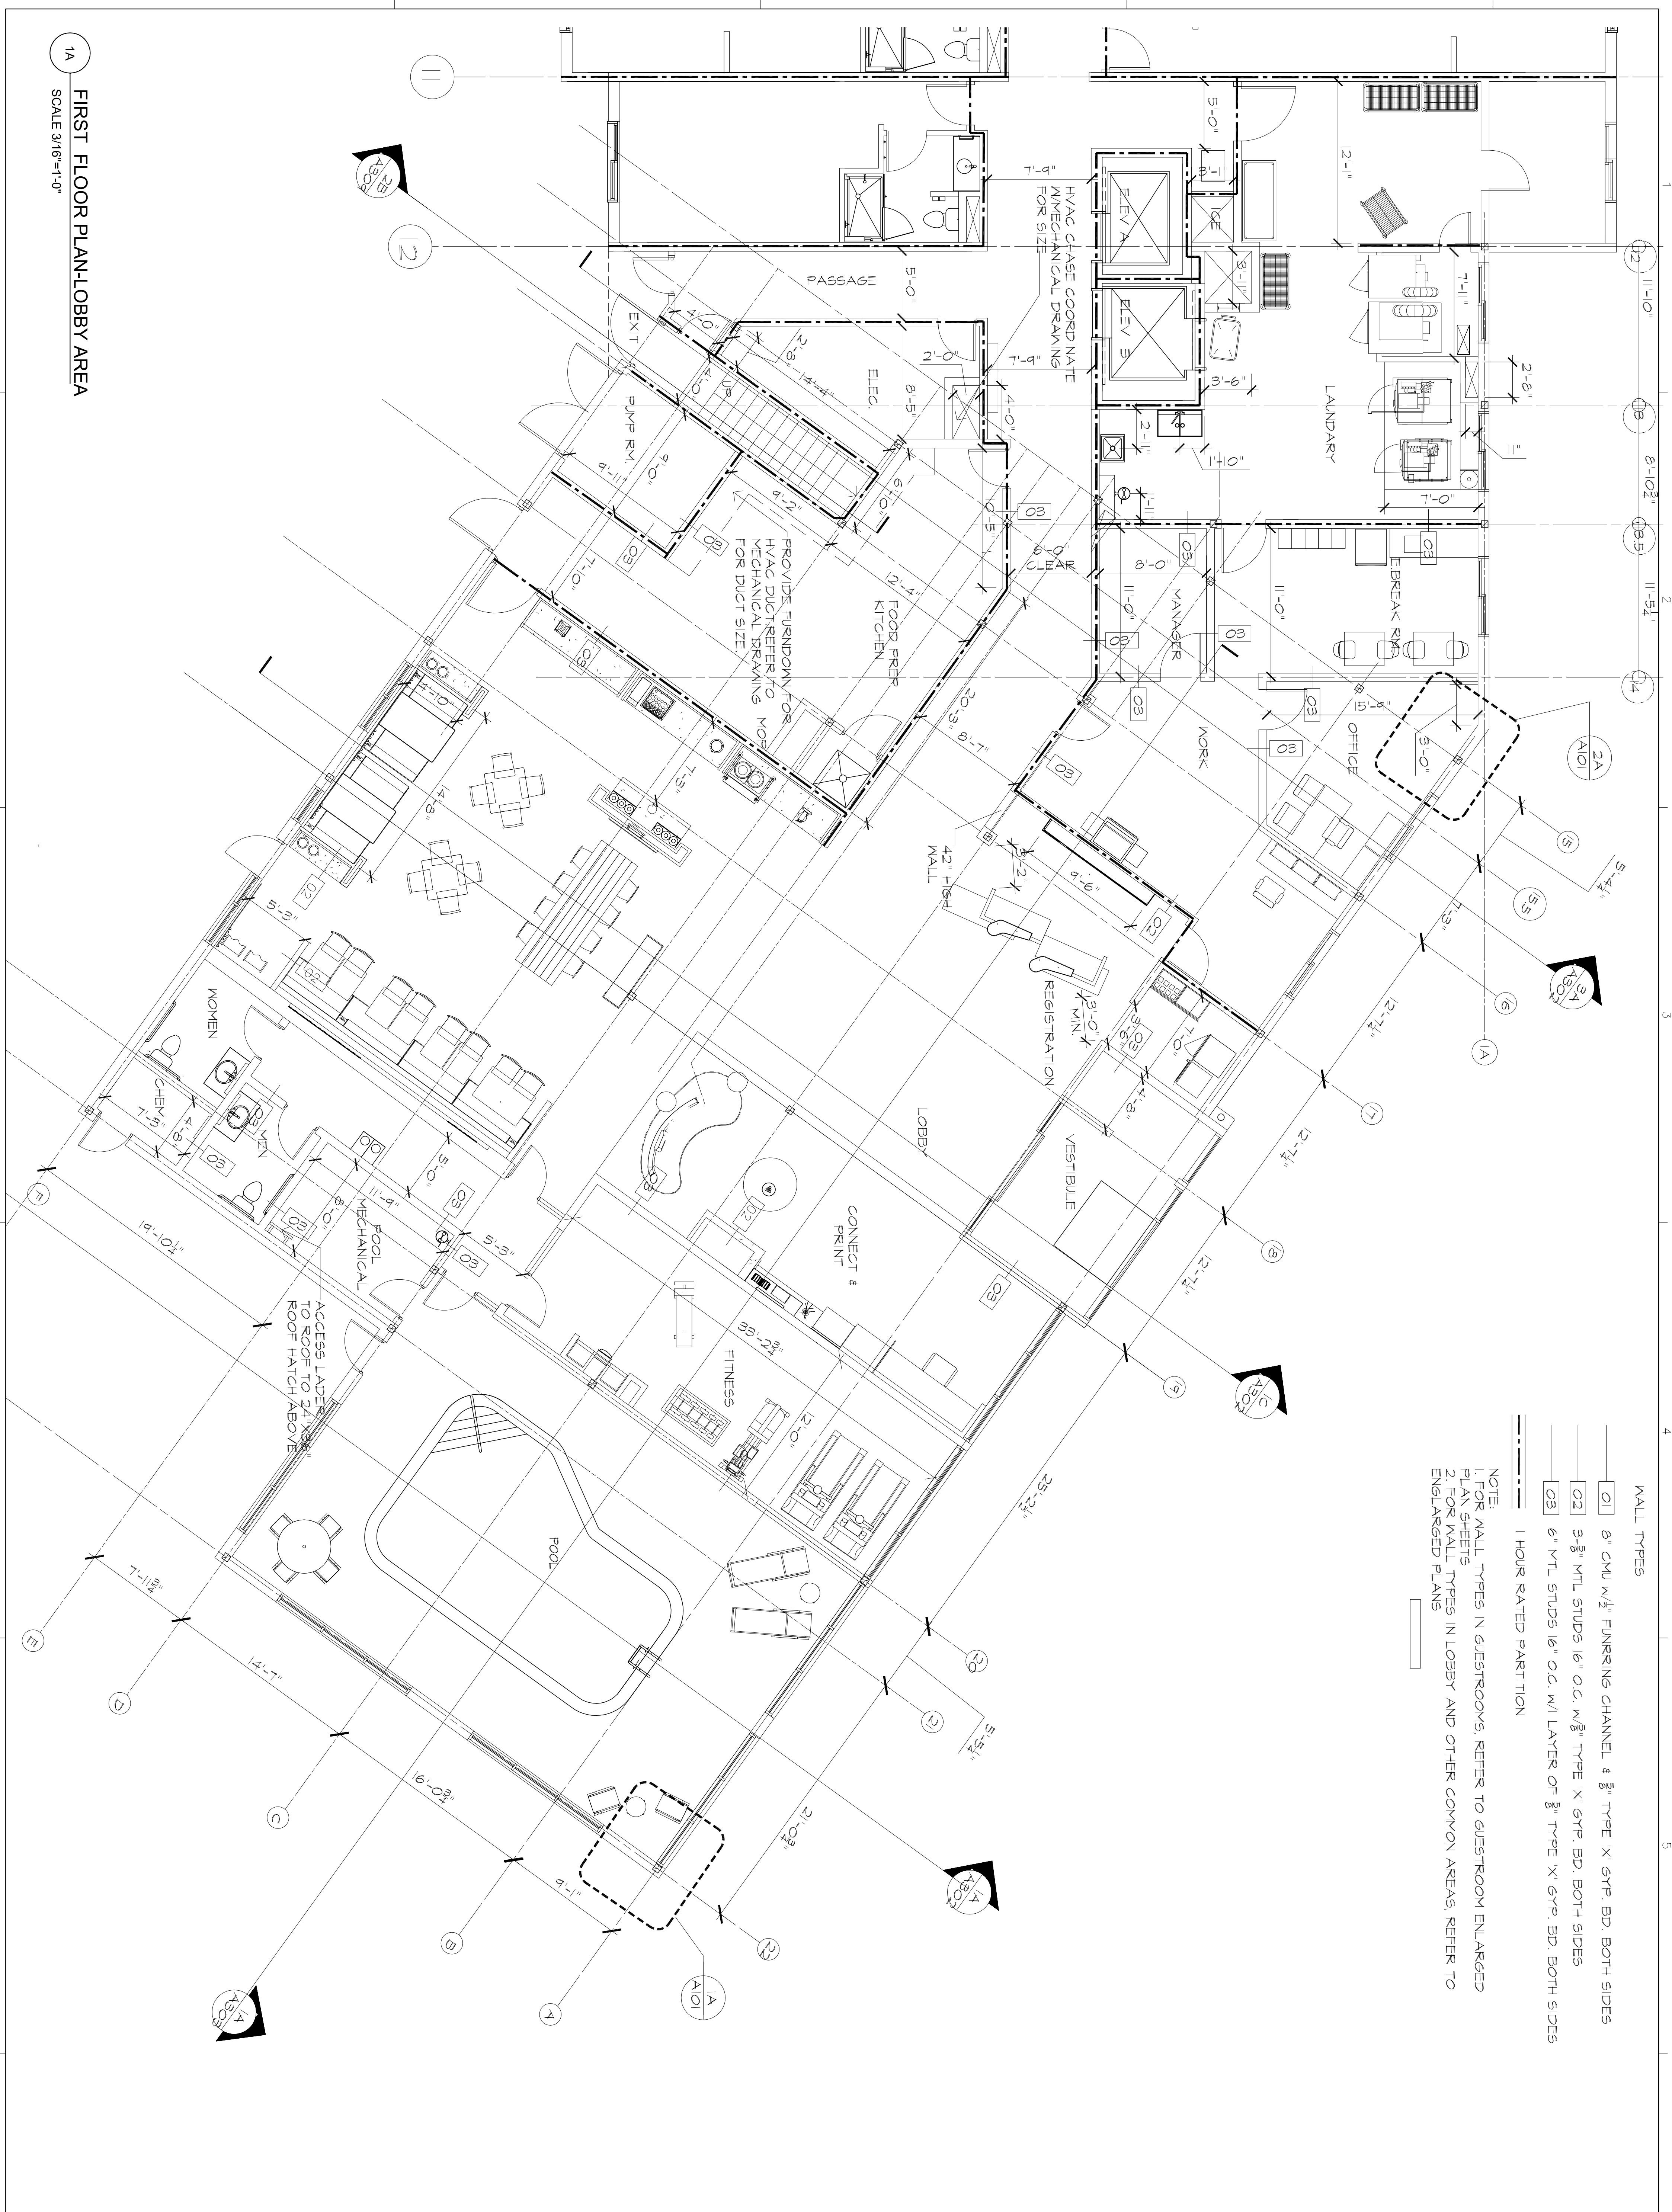
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NO.	DATE	DESCRIPTION
1	09/22/15	30% REVIEW SET
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3	12/22/2015	100% REVIEW SET

PROJECT NUMBER:	15180
DRAWING NAME:	
SHEET NAME:	
BUILDING SECTIONS:	
DRAWN BY/CHK:	BBC
CHECKED BY:	BBC
DATE:	12-22-15
SCALE:	AS NOTED
DRAWING NUMBER:	<b>A309</b>



- WALL TYPES
- 01 8" CMU w/1/2" FURRING CHANNEL & 3/8" TYPE 'X' GYP. BD. BOTH SIDES
  - 02 3-5/8" MTL STUDS 16" O.C. w/3/8" TYPE 'X' GYP. BD. BOTH SIDES
  - 03 6" MTL STUDS 16" O.C. w/ LAYER OF 5/8" TYPE 'X' GYP. BD. BOTH SIDES
  - 1 HOUR RATED PARTITION

NOTE:  
 1. FOR WALL TYPES IN GUESTROOMS, REFER TO GUESTROOM ENLARGED PLAN SHEETS  
 2. FOR WALL TYPES IN LOBBY AND OTHER COMMON AREAS, REFER TO ENLARGED PLANS

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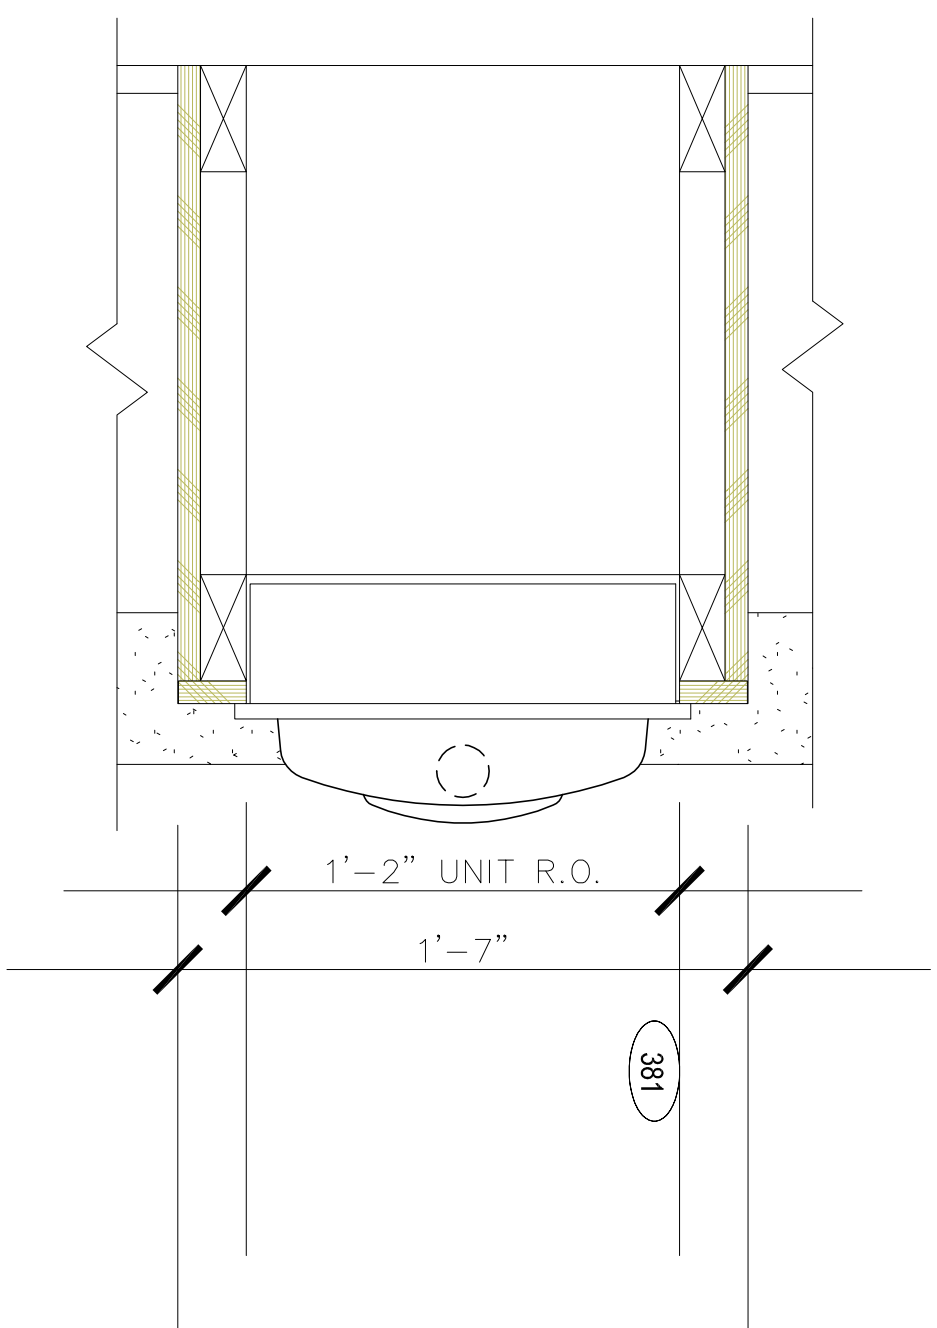
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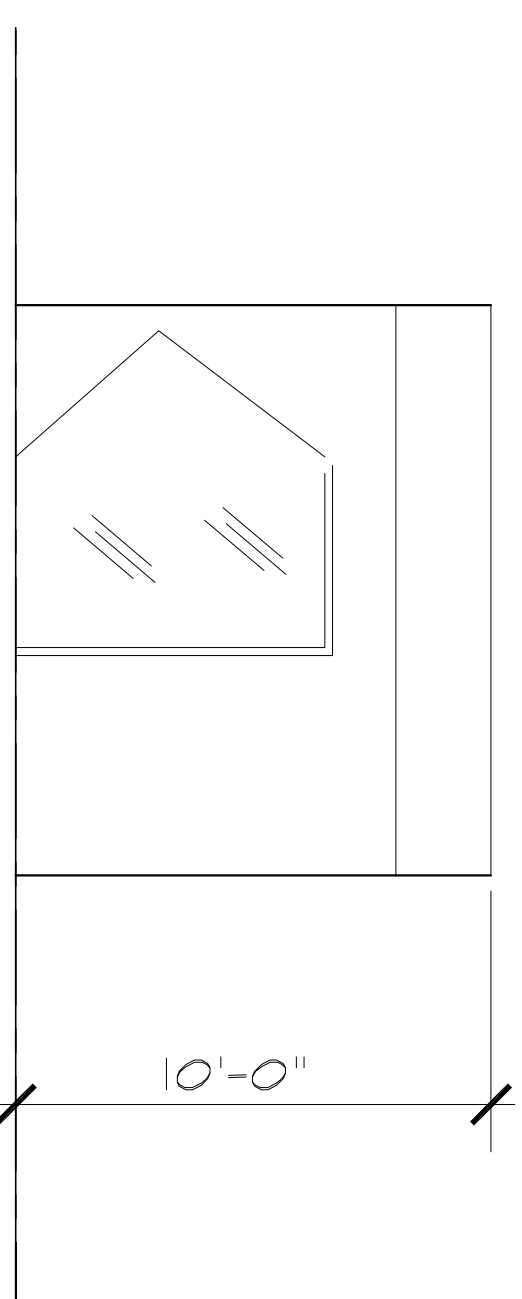
NO.	DATE	DESCRIPTION
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2	11/22/2015	50% REVIEW SET
3	12/22/2015	100% REVIEW SET

PROJECT NAME:	FAIRFIELD INN & SUITES
PROJECT NUMBER:	15180
DRAWING NAME:	LOBBY ENLARGED PLAN
SHEET NAME:	LOBBY ENLARGED PLAN
DRAWN BY/CHK:	BBC
CHECKED BY:	BBC
DATE:	12-22-15
SCALE:	AS NOTED
DRAWING NUMBER:	<b>A400</b>


1A FIRST FLOOR PLAN-LOBBY AREA  
 SCALE 3/16"=1'-0"




**1D** HYDRATION STATION PLAN DETAIL  
SCALE 1/2"=1'-0"




**3D** ELEVATION  
SCALE 1/4"=1'-0"

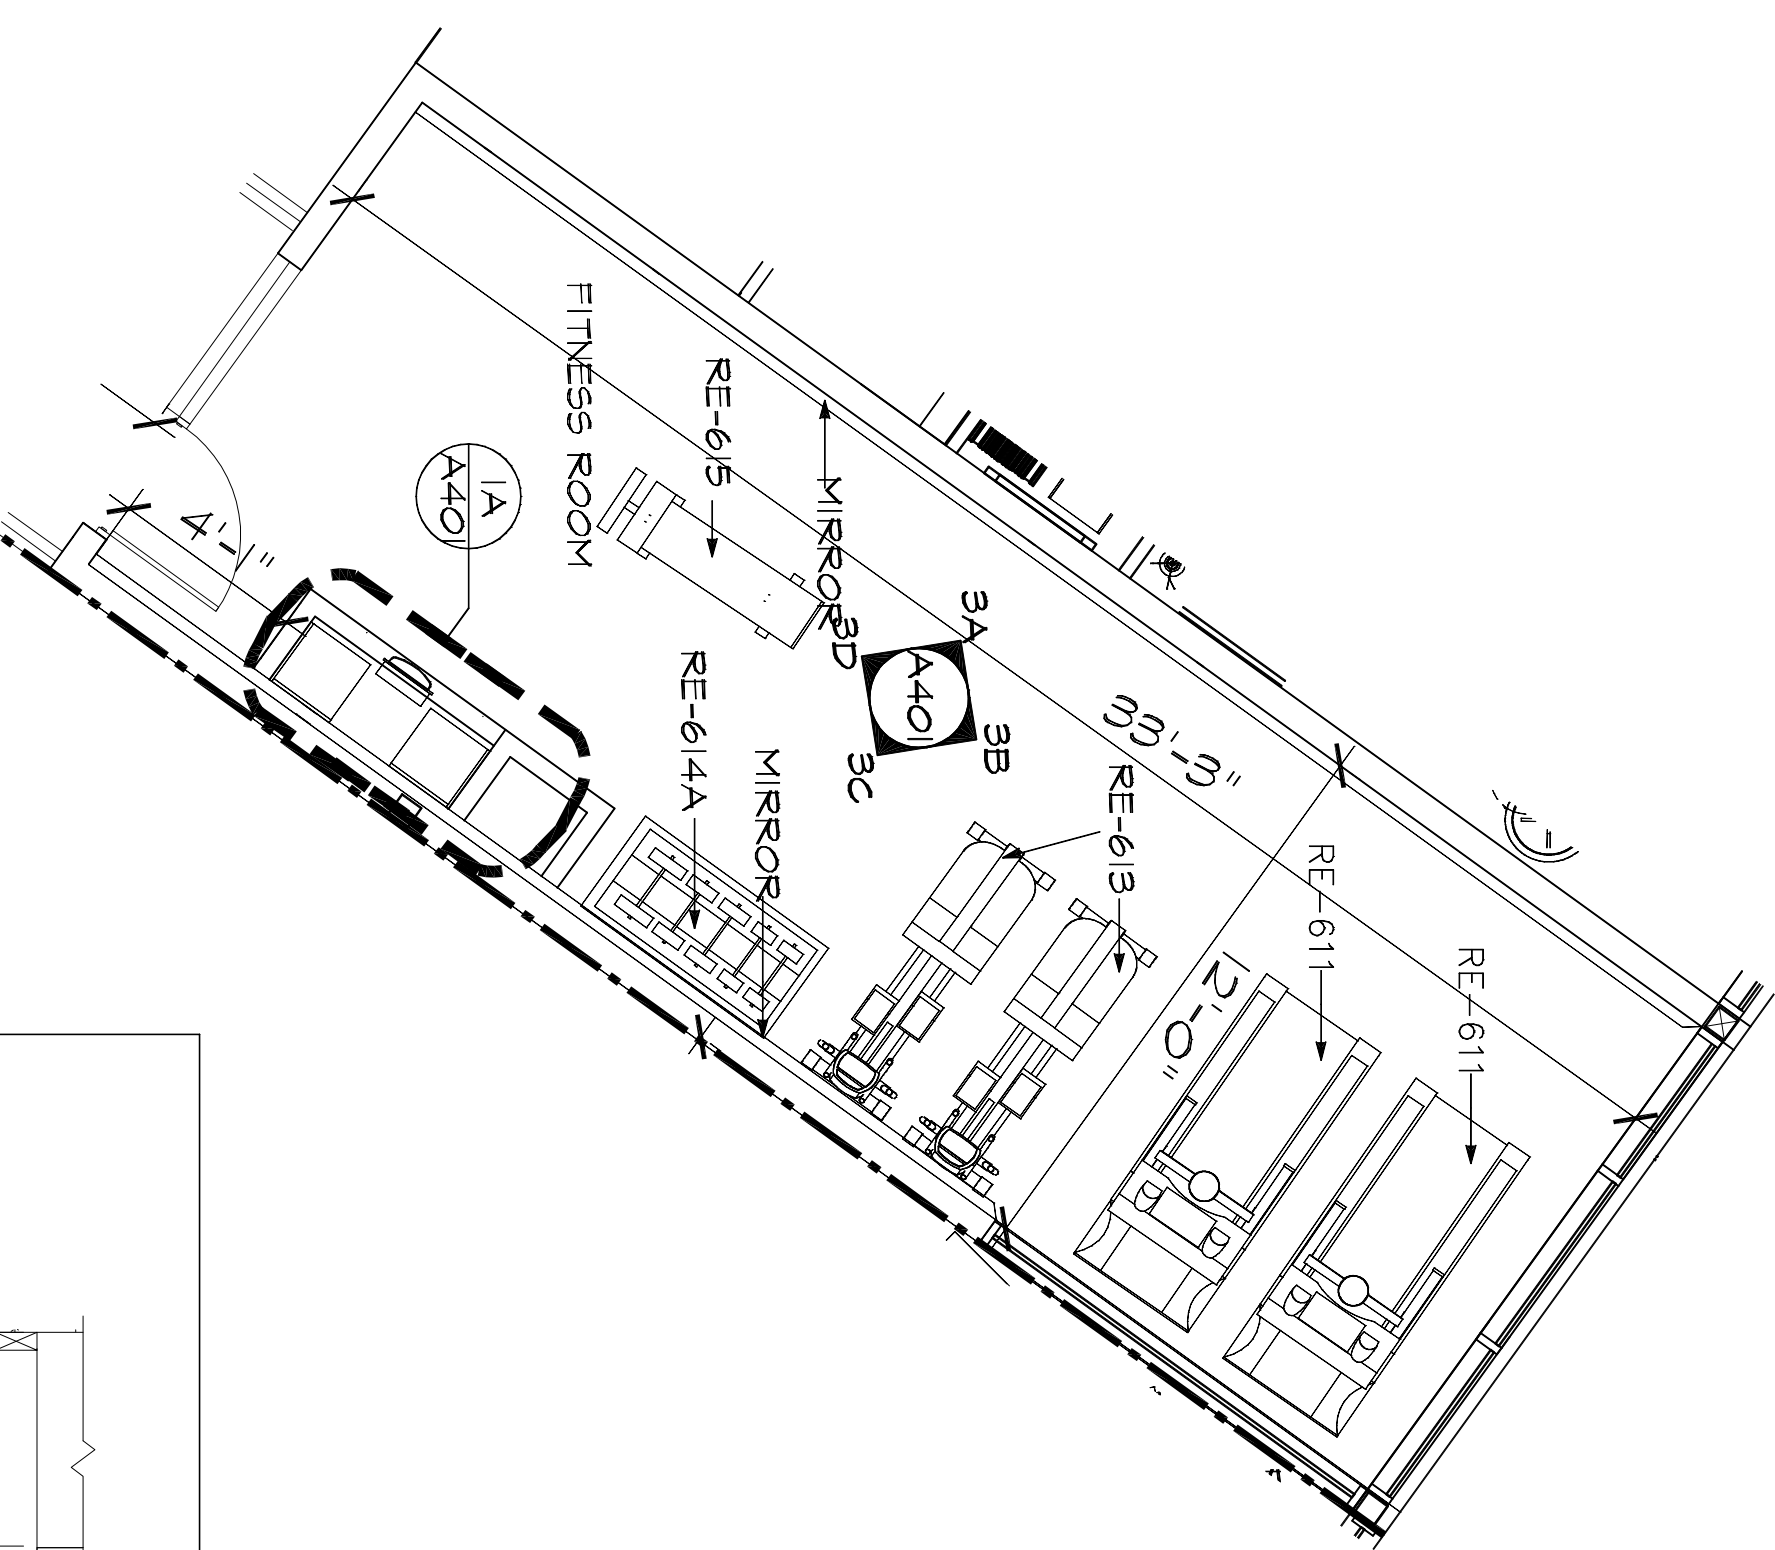


**1B** FIRST FLOOR PLAN-FITNESS ROOM  
SCALE 1/4"=1'-0"

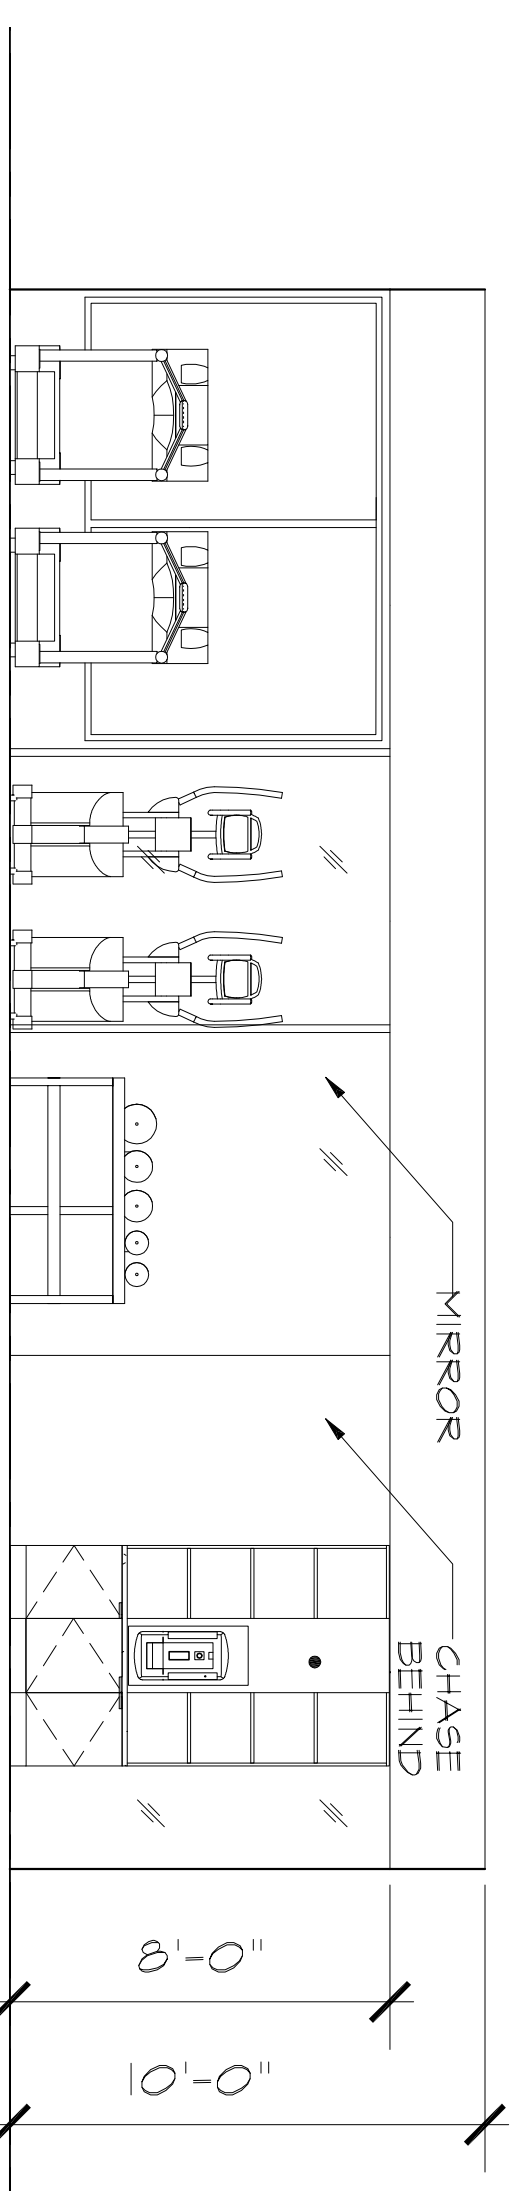


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SCALE 1/4"=1'-0"

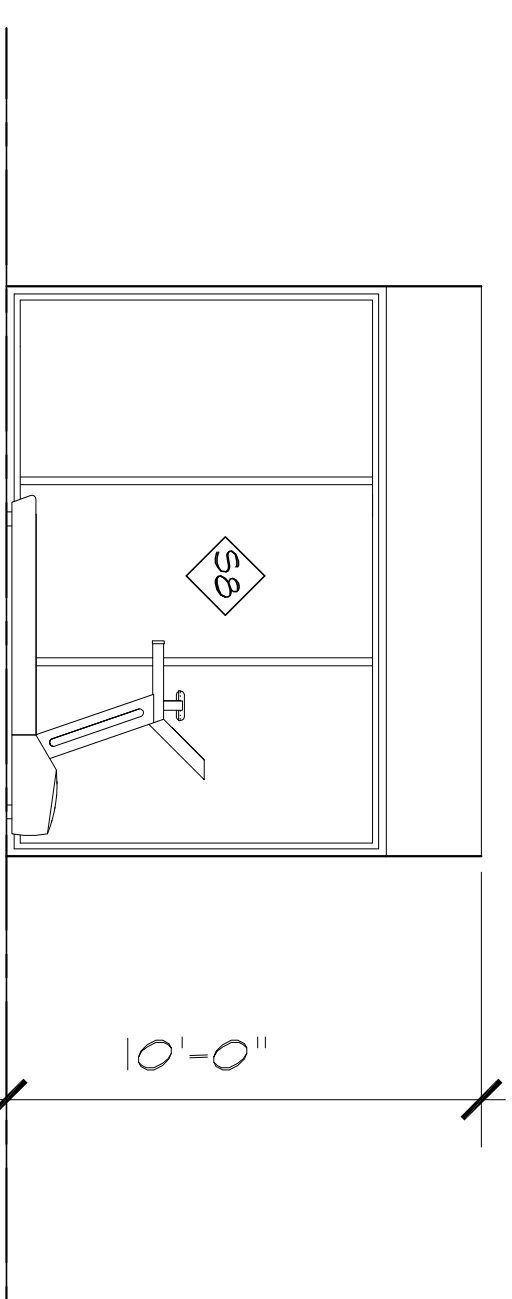


**3B** ELEVATION  
SCALE 1/4"=1'-0"

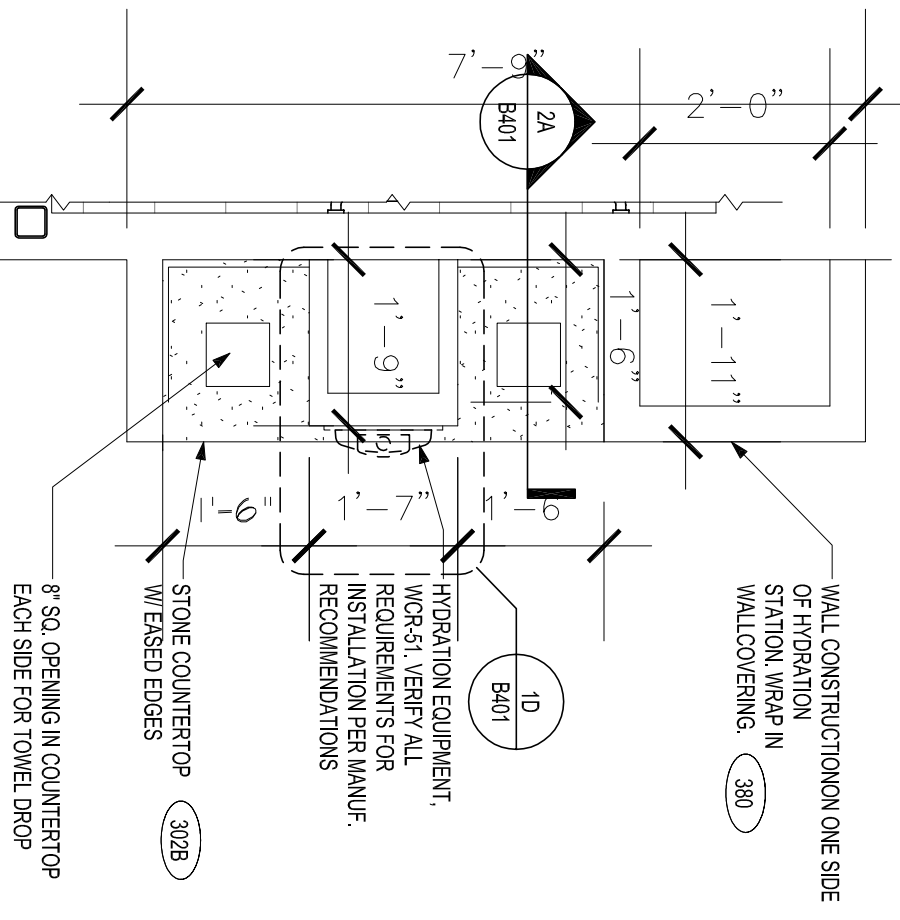

**1A** ENLARGED PLAN -HYDRATION STATION  
SCALE 1/2"=1'-0"

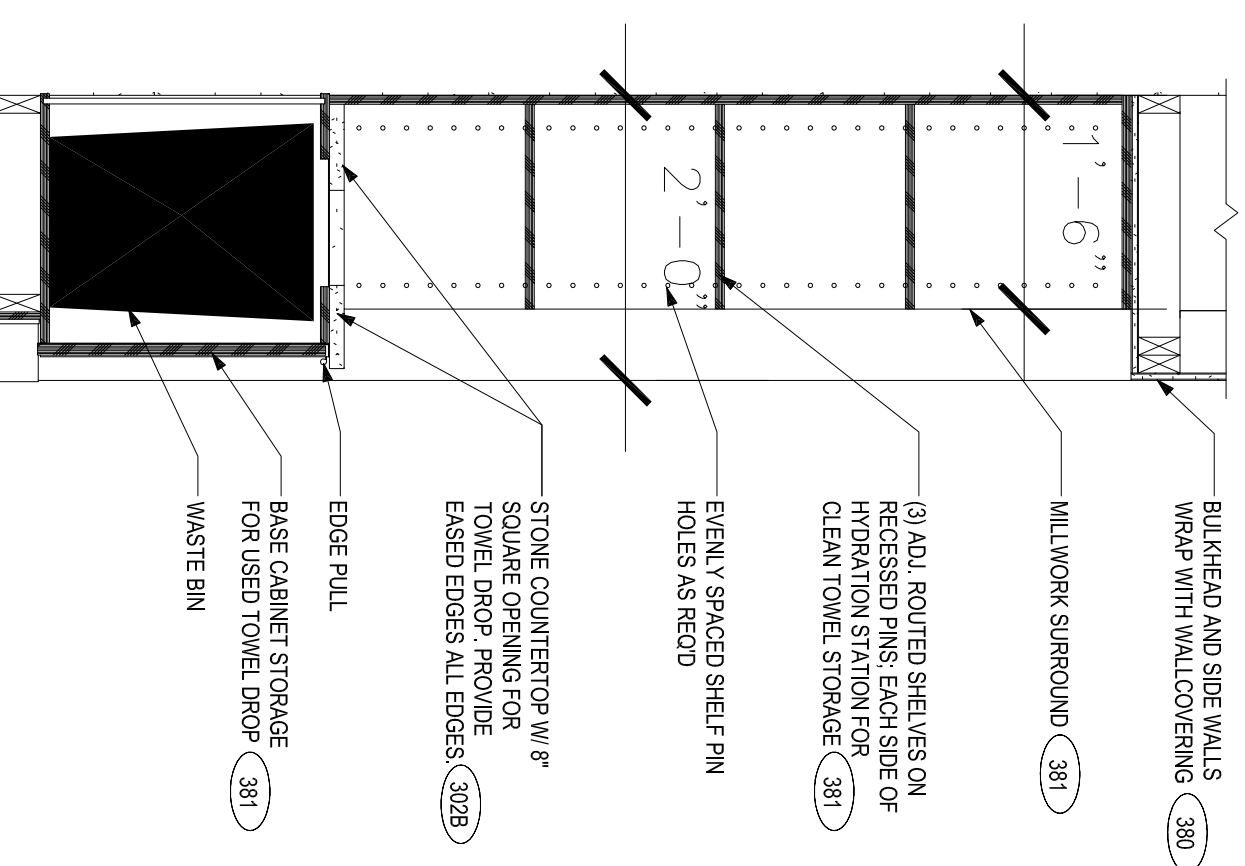

**3A** SECTION THROUGH HYDRATION STATION  
SCALE 3/4"=1'-0"

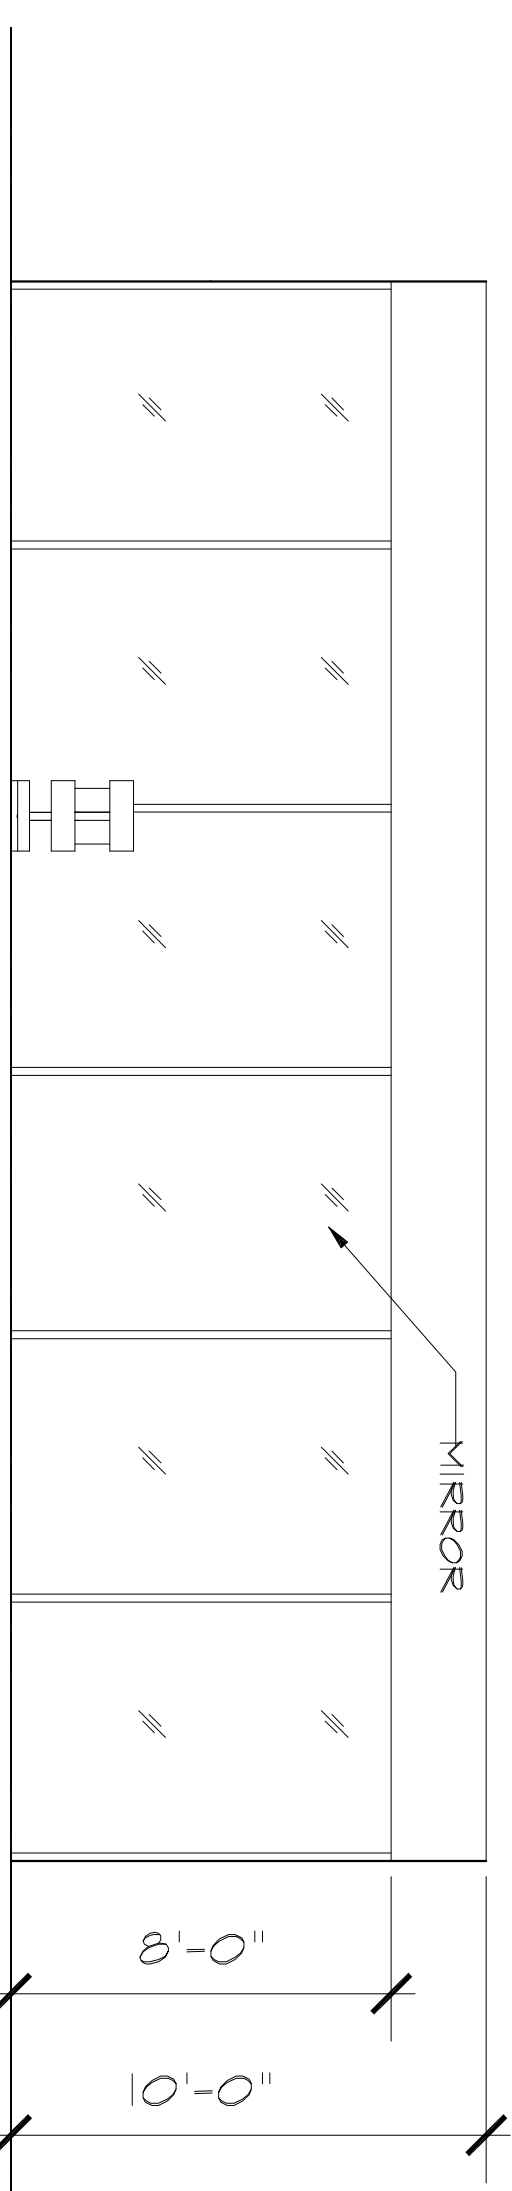


**3A** ELEVATION  
SCALE 1/4"=1'-0"

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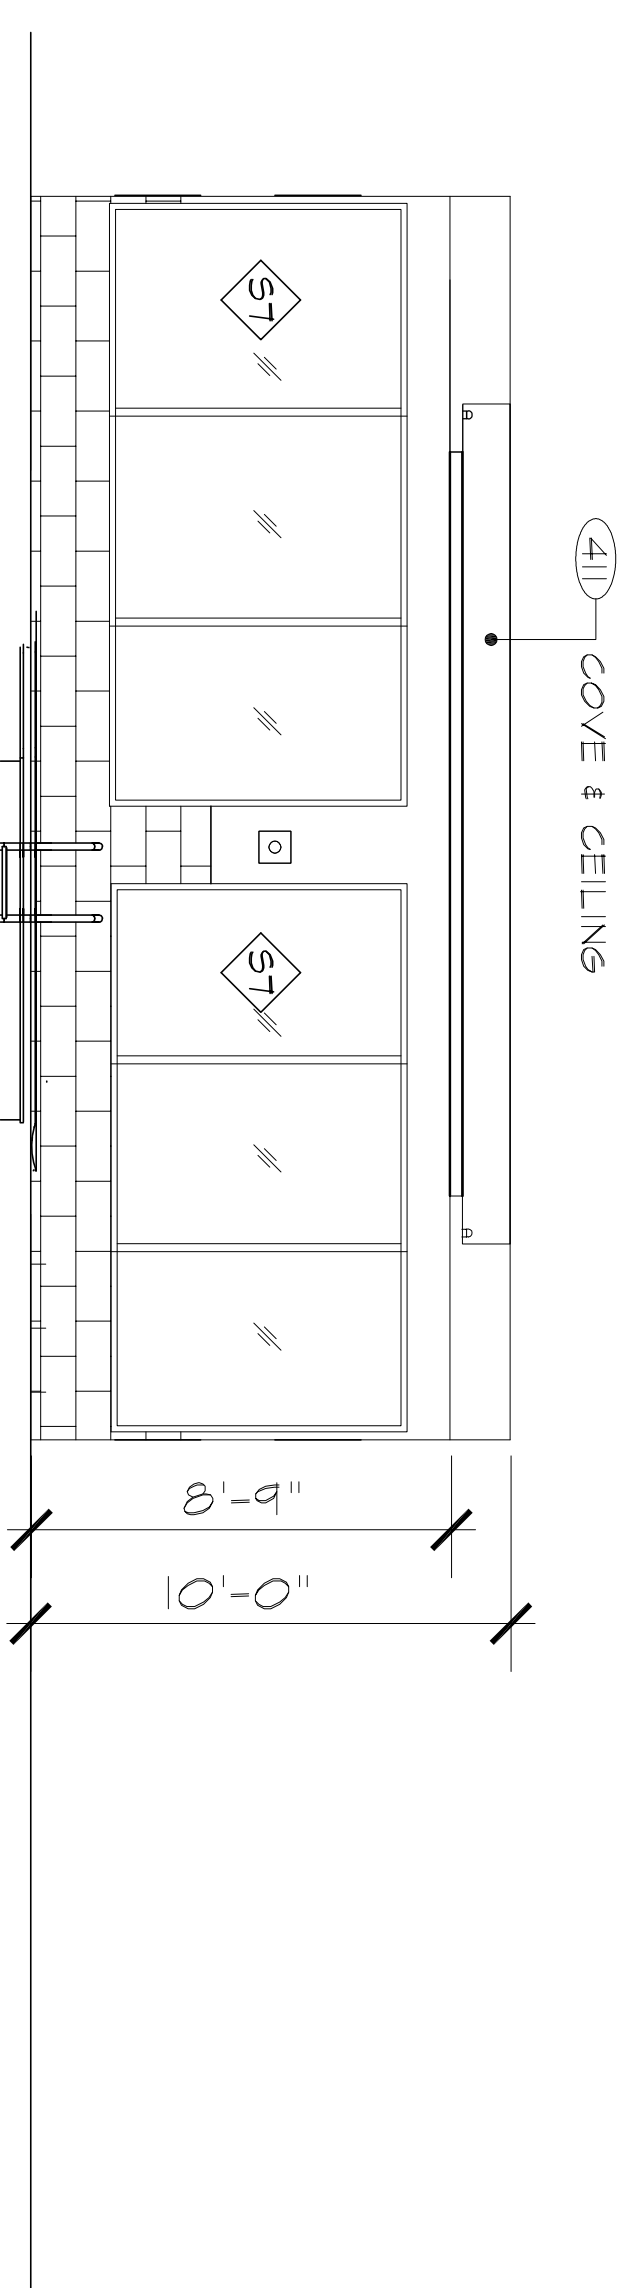
CONSULTANTS

ISSUES & REVISIONS	NO.	DATE	DESCRIPTION
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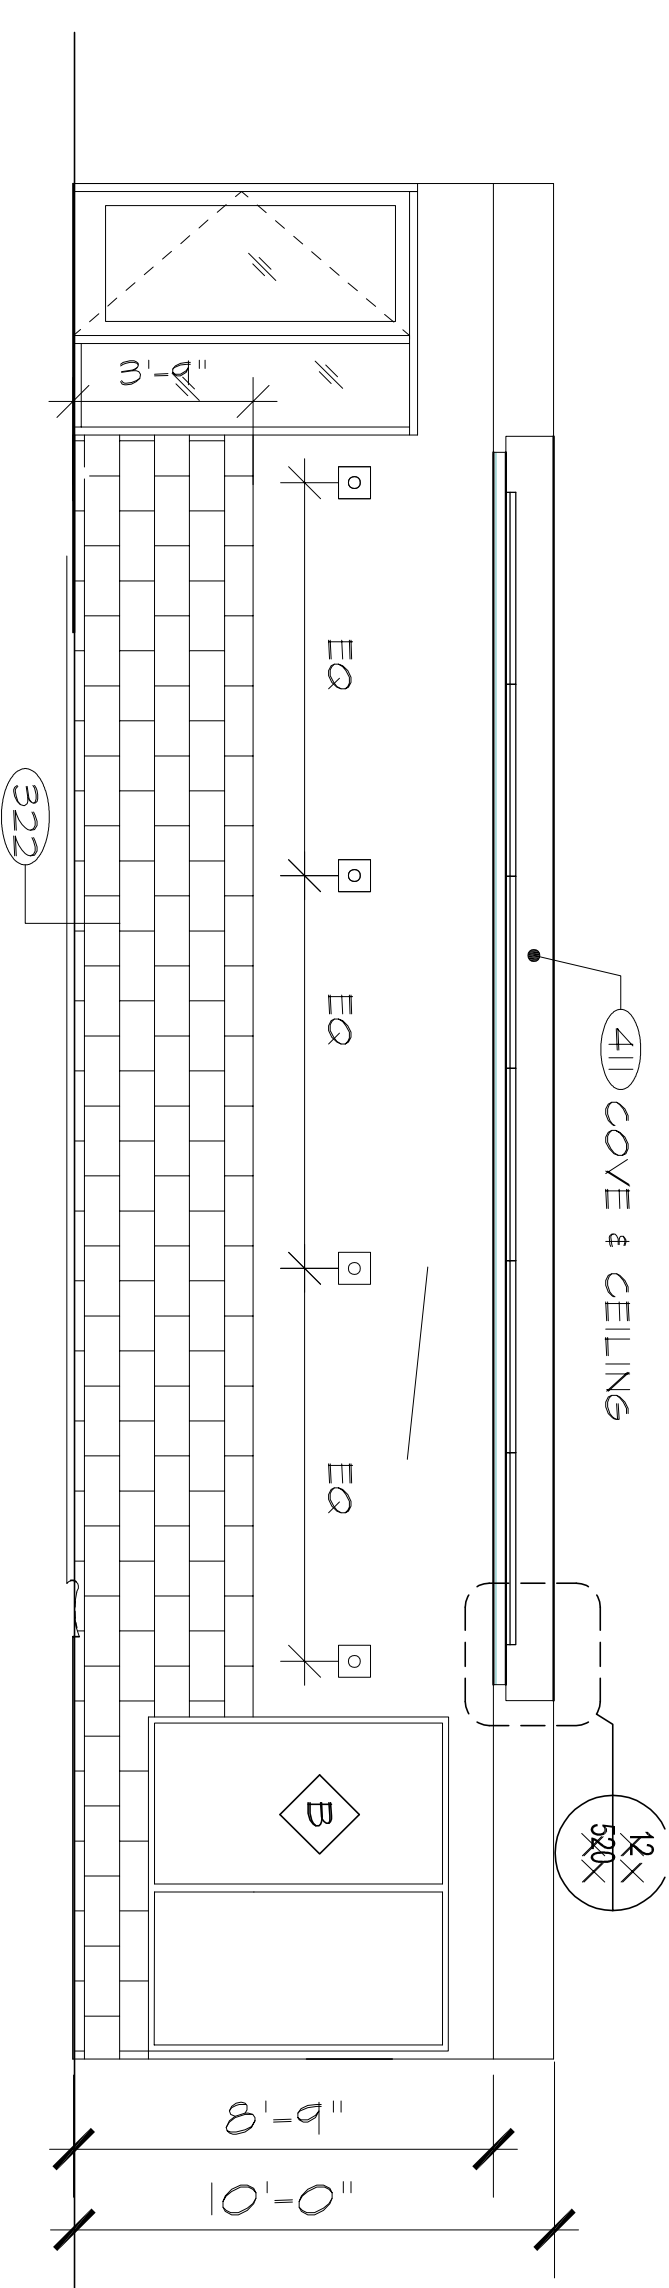
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DRAWING NUMBER:	
SHEET NAME:	
FITNESS ENLARGED PLAN	

DRAWN BY:	NK
CHECKED BY:	BB/C/NK
DATE:	7-30-14
SCALE:	AS NOTED
DRAWING NUMBER:	

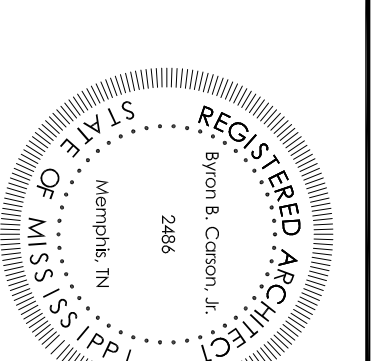
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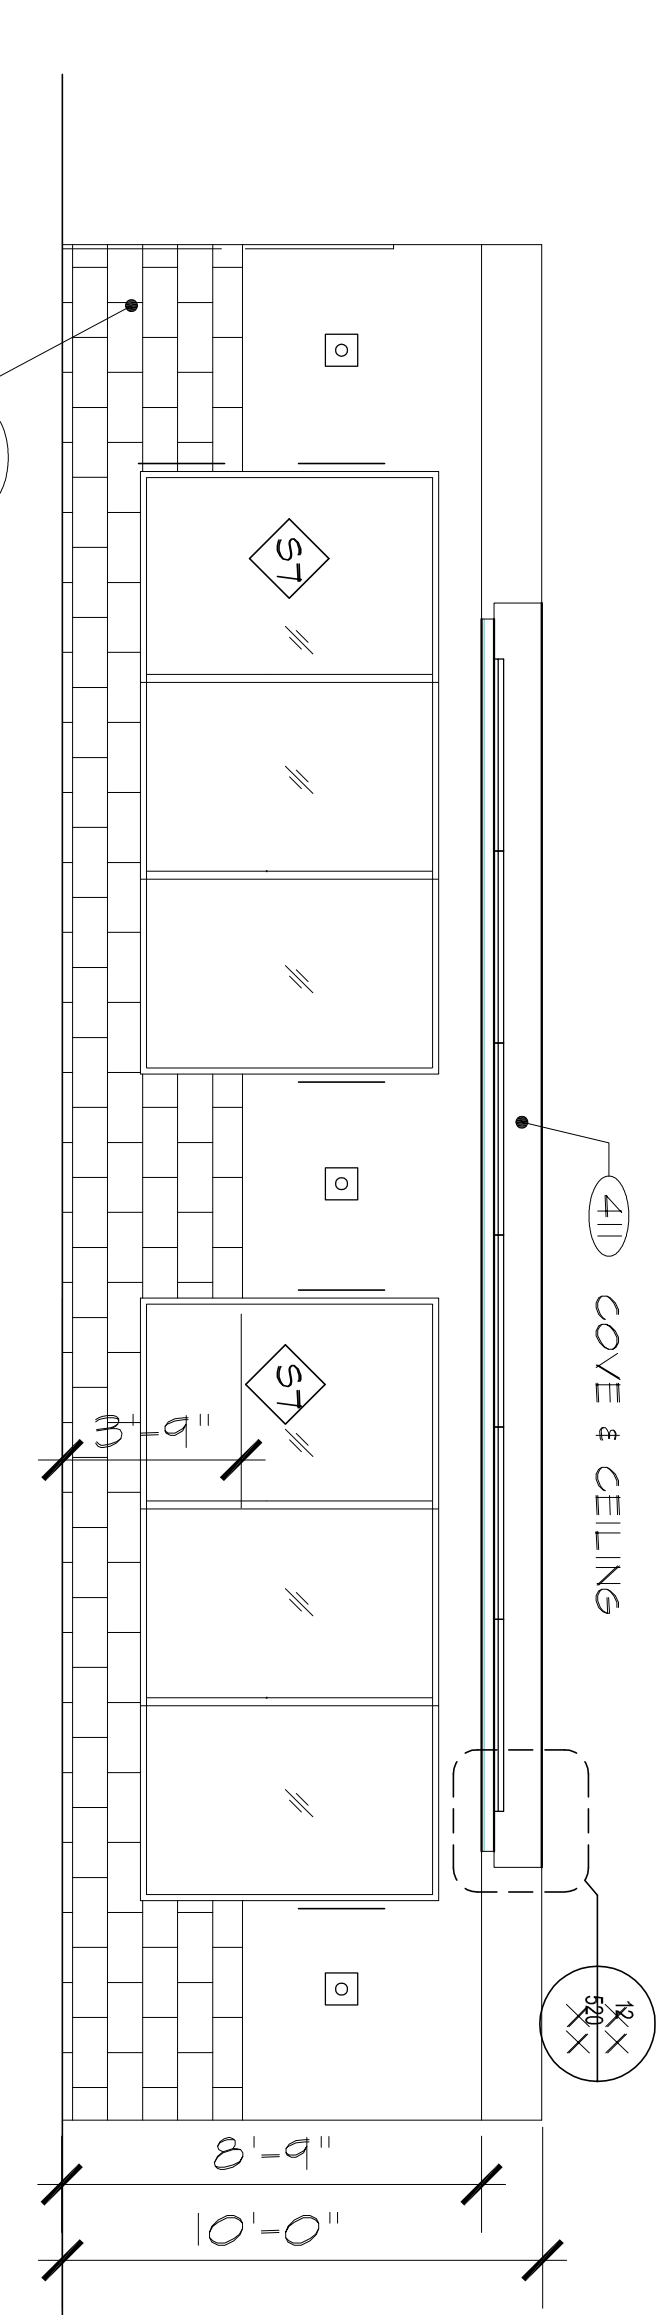
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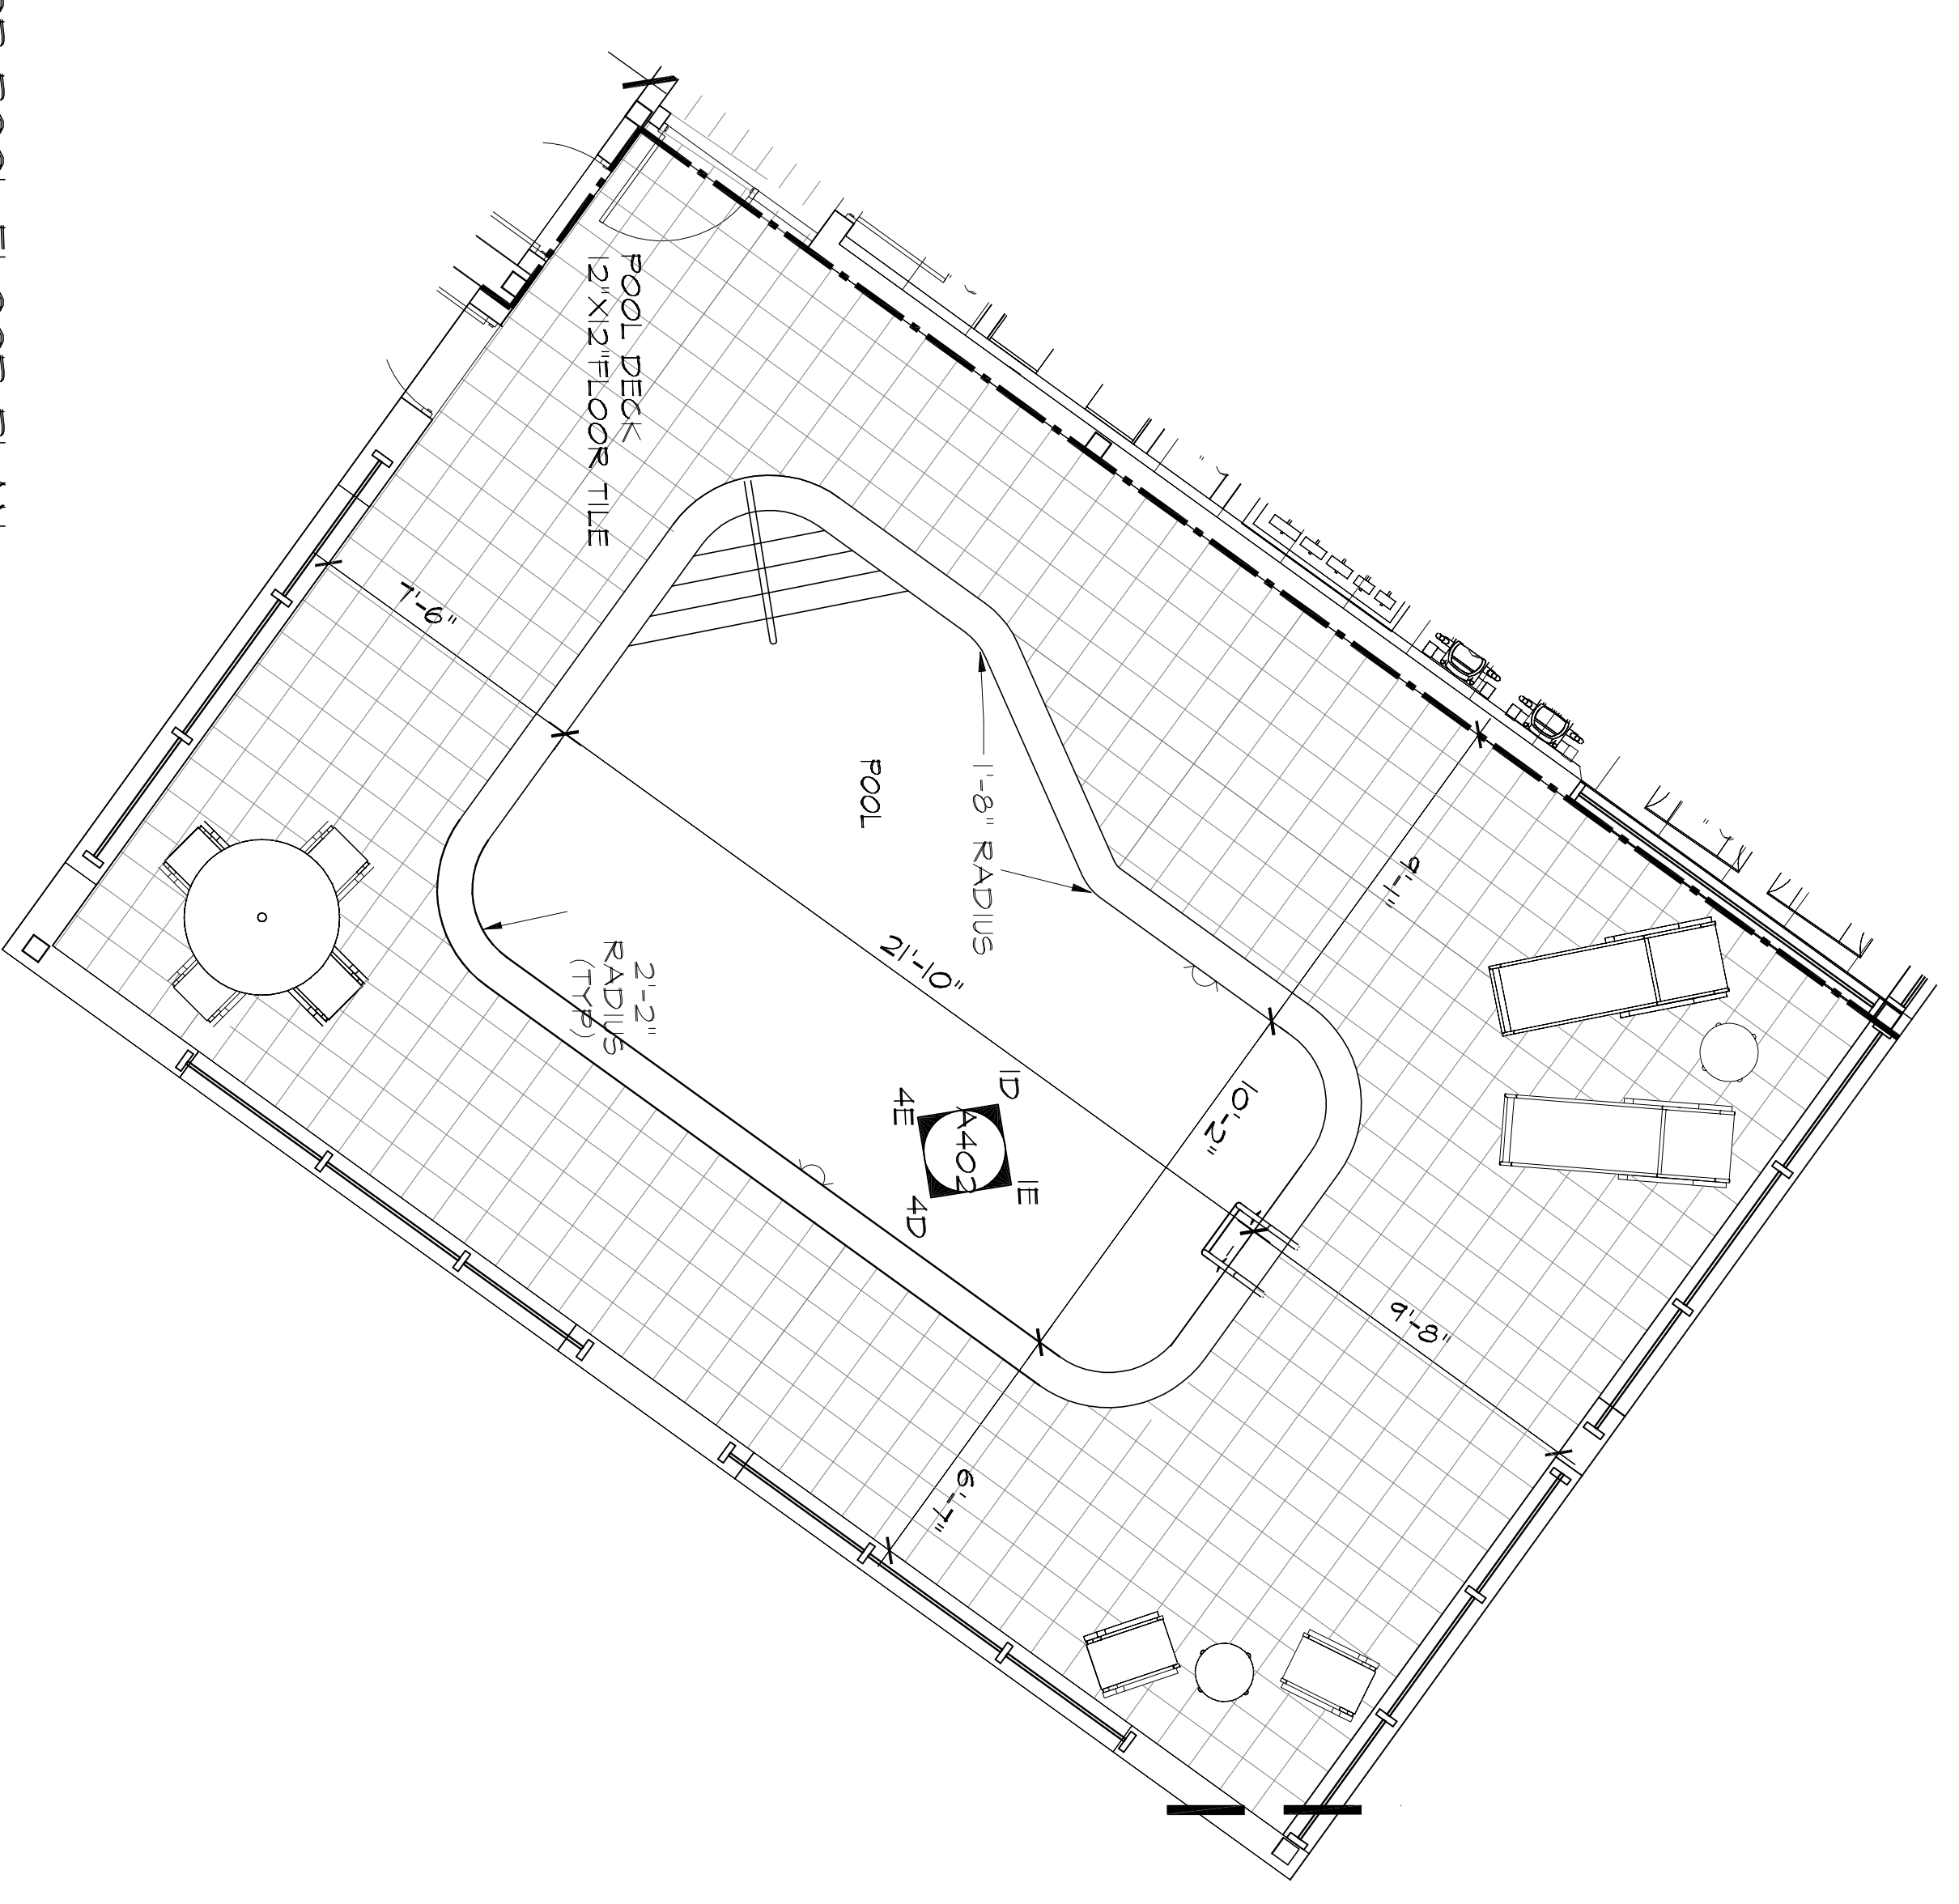
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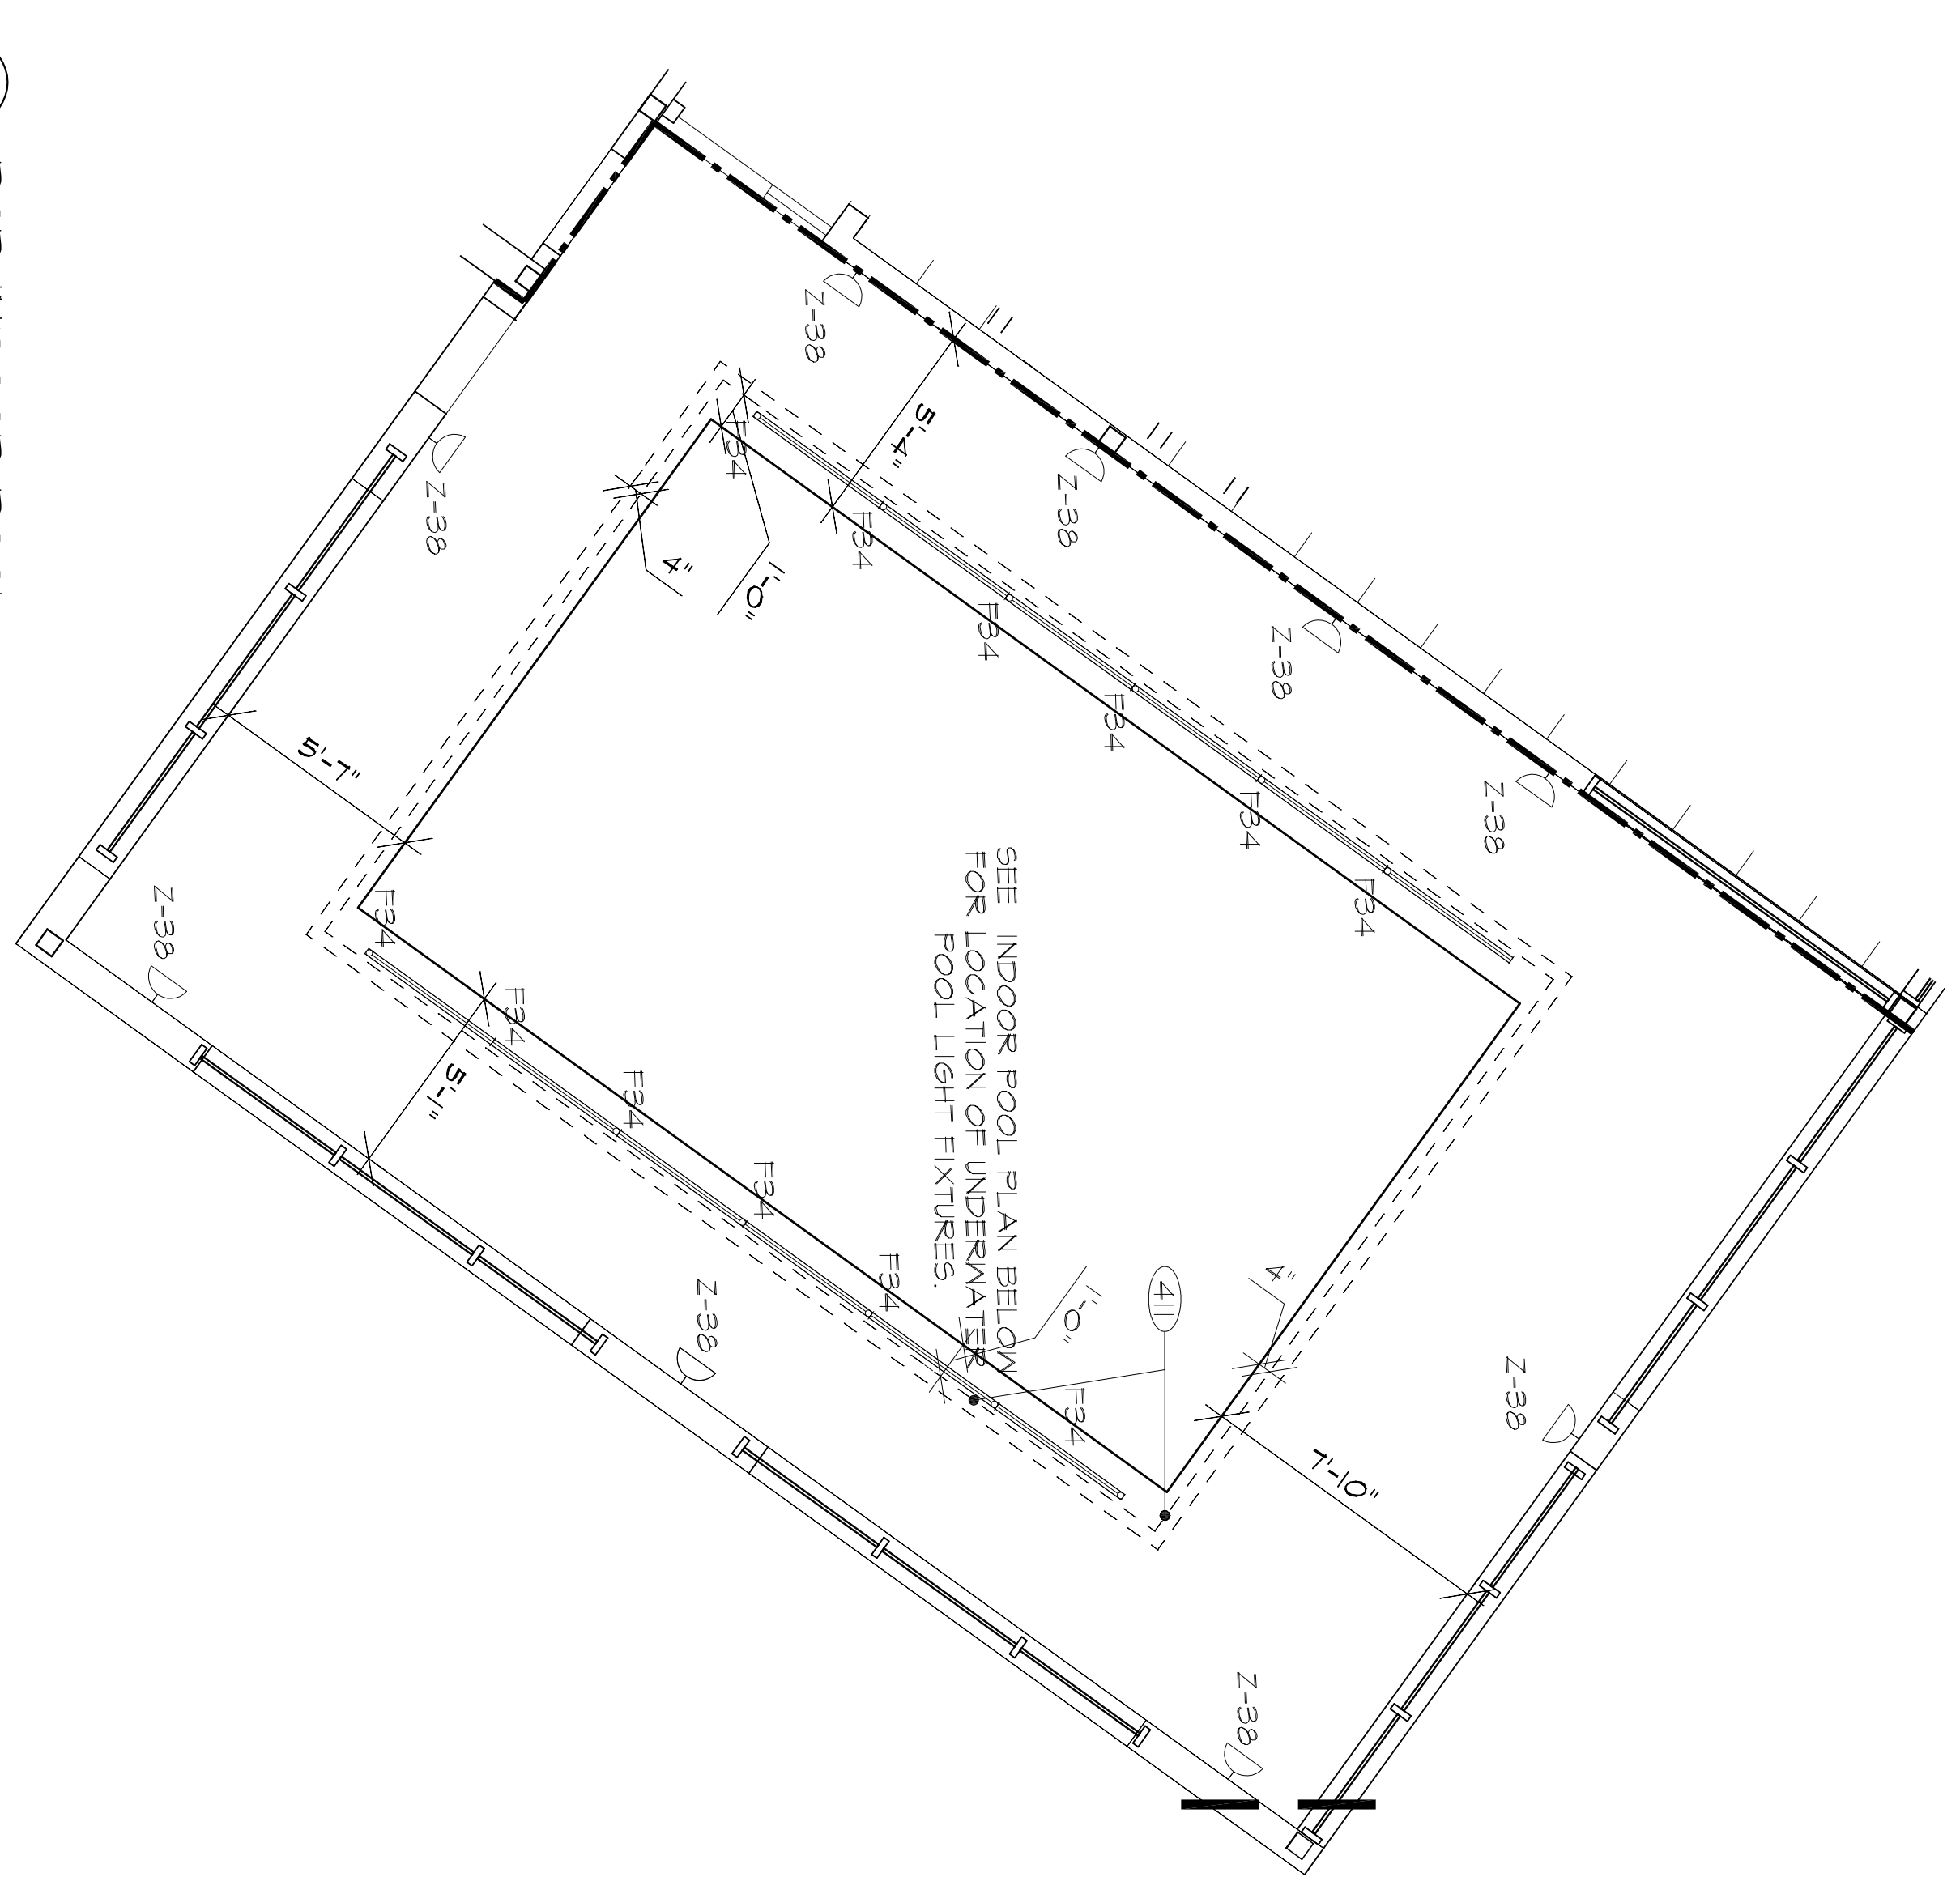
4E ELEVATION  
SCALE 1/4"=1'-0"



4D ELEVATION  
SCALE 1/4"=1'-0"



1A INDOOR POOL FLOOR PLAN  
SCALE 1/4"=1'-0"

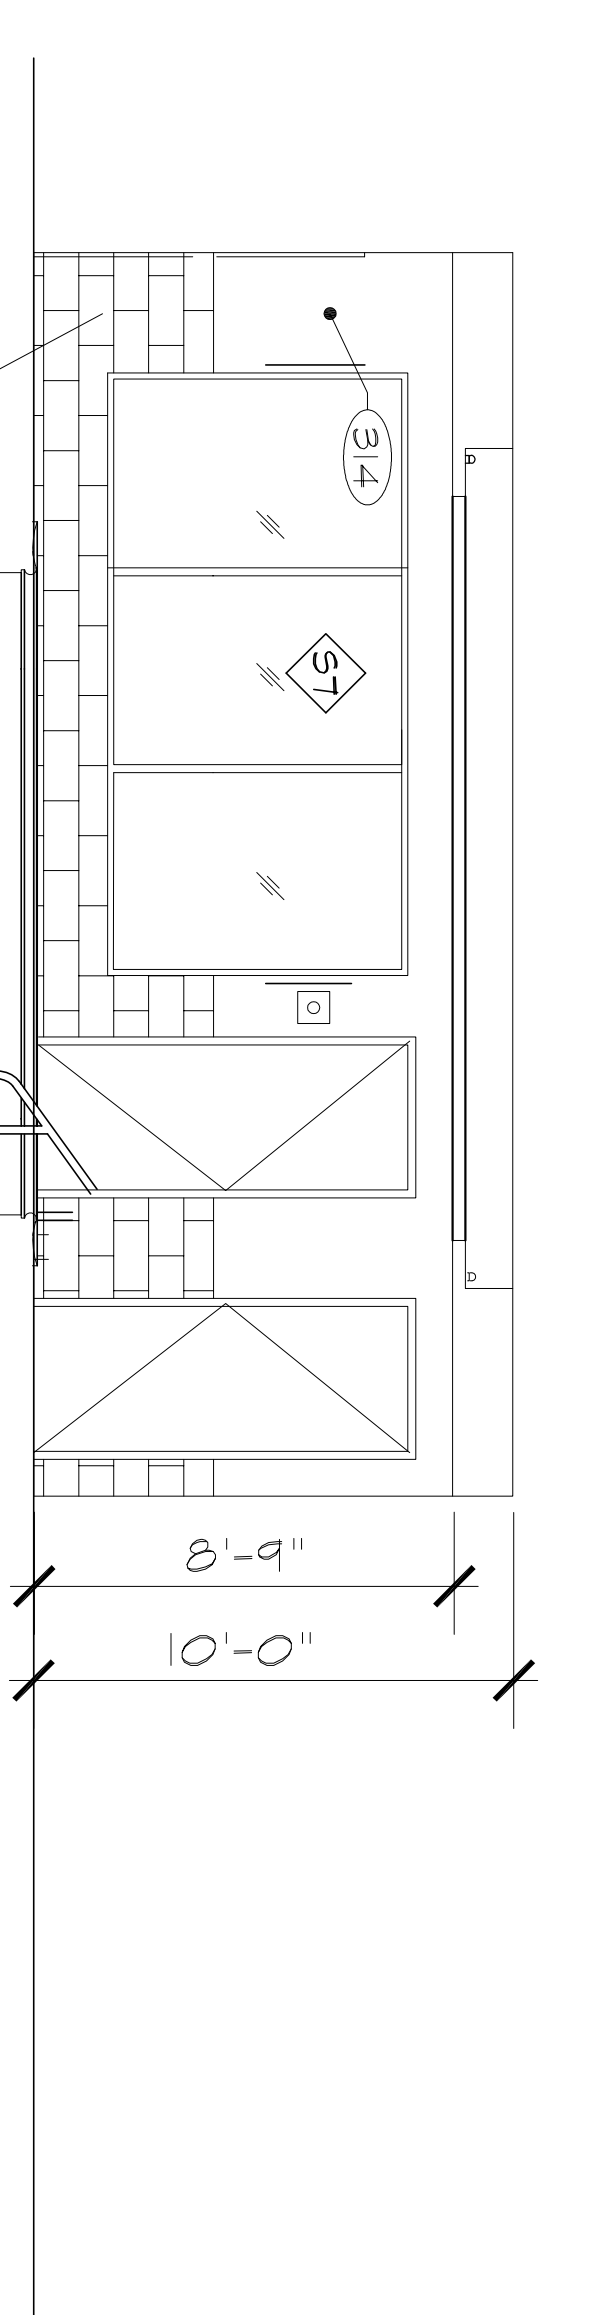

4A RCP-INDOOR POOL  
SCALE 1/4"=1'-0"

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NO.	DATE	DESCRIPTION
1	08/20/14	CODE SUBMITTAL

PROJECT NAME:	
PROJECT NUMBER:	
DRAWING NAME:	
SHEET NAME:	
POOL ENLARGED PLAN & DETAILS	

DRAWN BY:	NK
CHECKED BY:	BBC/ANK
DATE:	7-30-14
SCALE:	AS NOTED
DRAWING NUMBER:	

A402




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PROJECT NUMBER:

DRAWING NAME:


SHEET NAME:

LAUNDRY

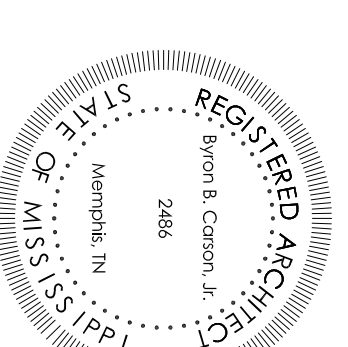
DRAWN BY: NK  
 CHECKED BY: BBC/ANK  
 DATE: 7-30-14  
 SCALE: AS NOTED

DRAWING NUMBER

A403

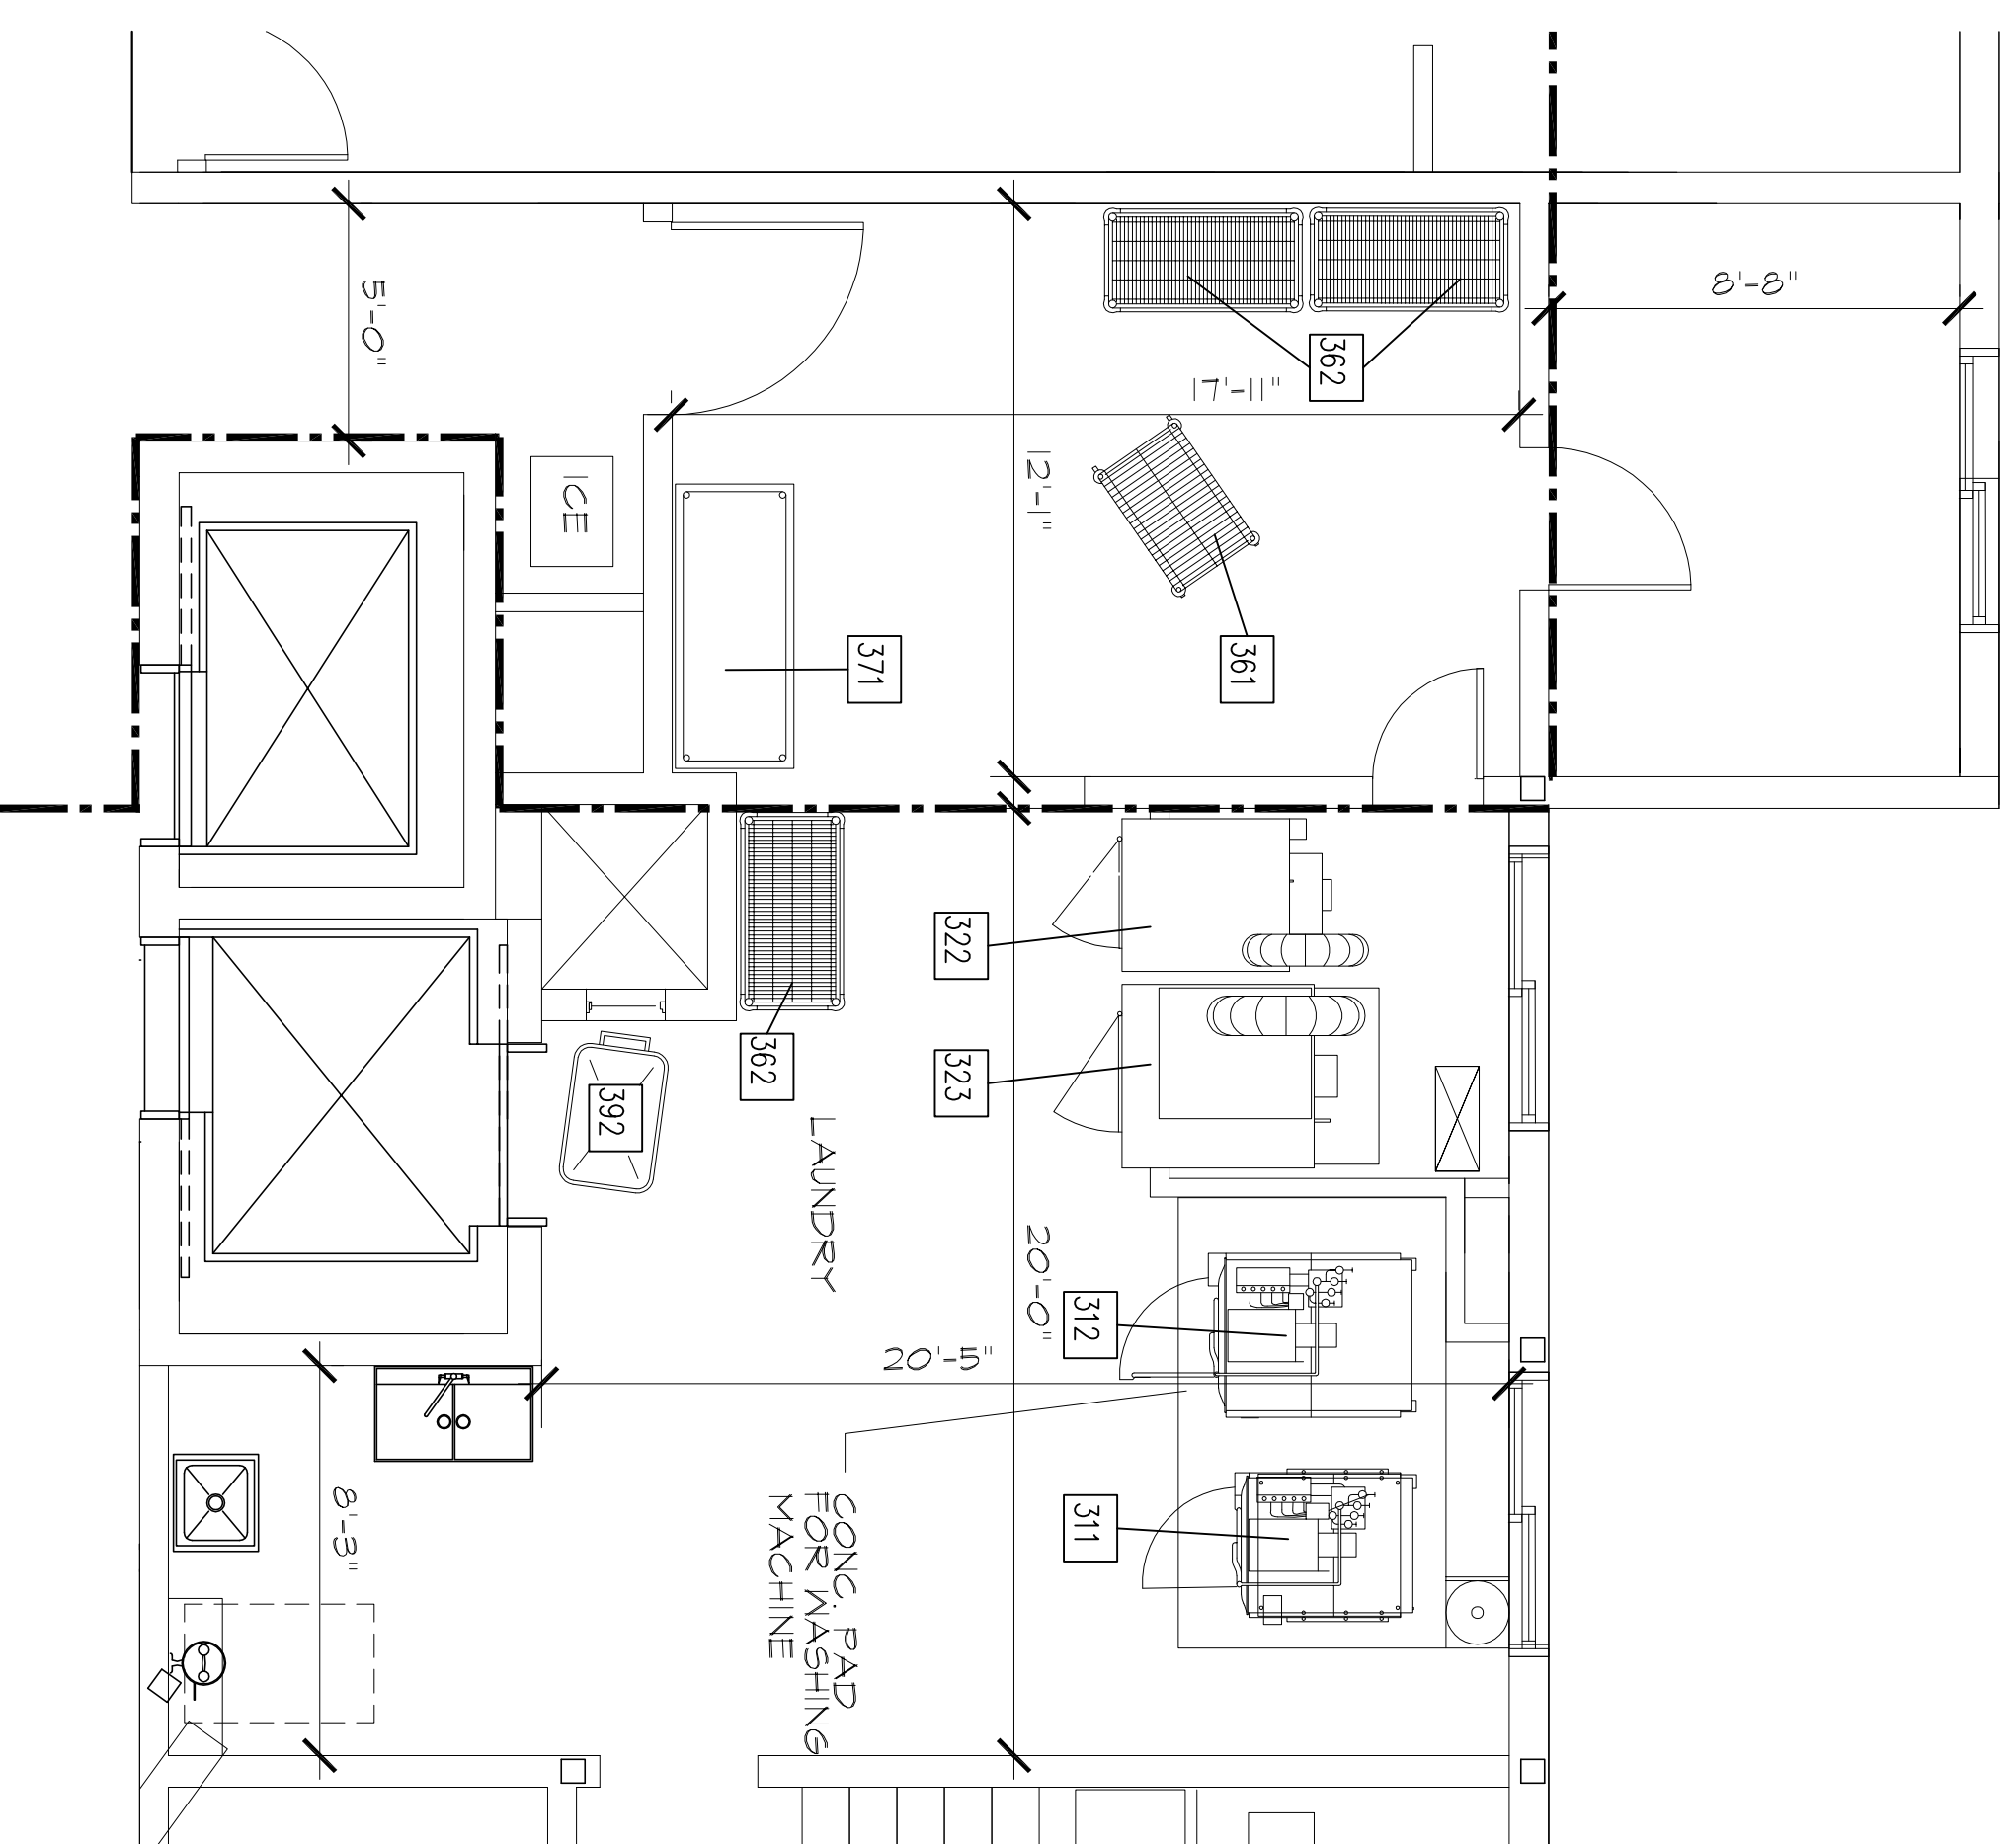

1C LAUNDRY  
 SCALE 1/4"=1'-0"

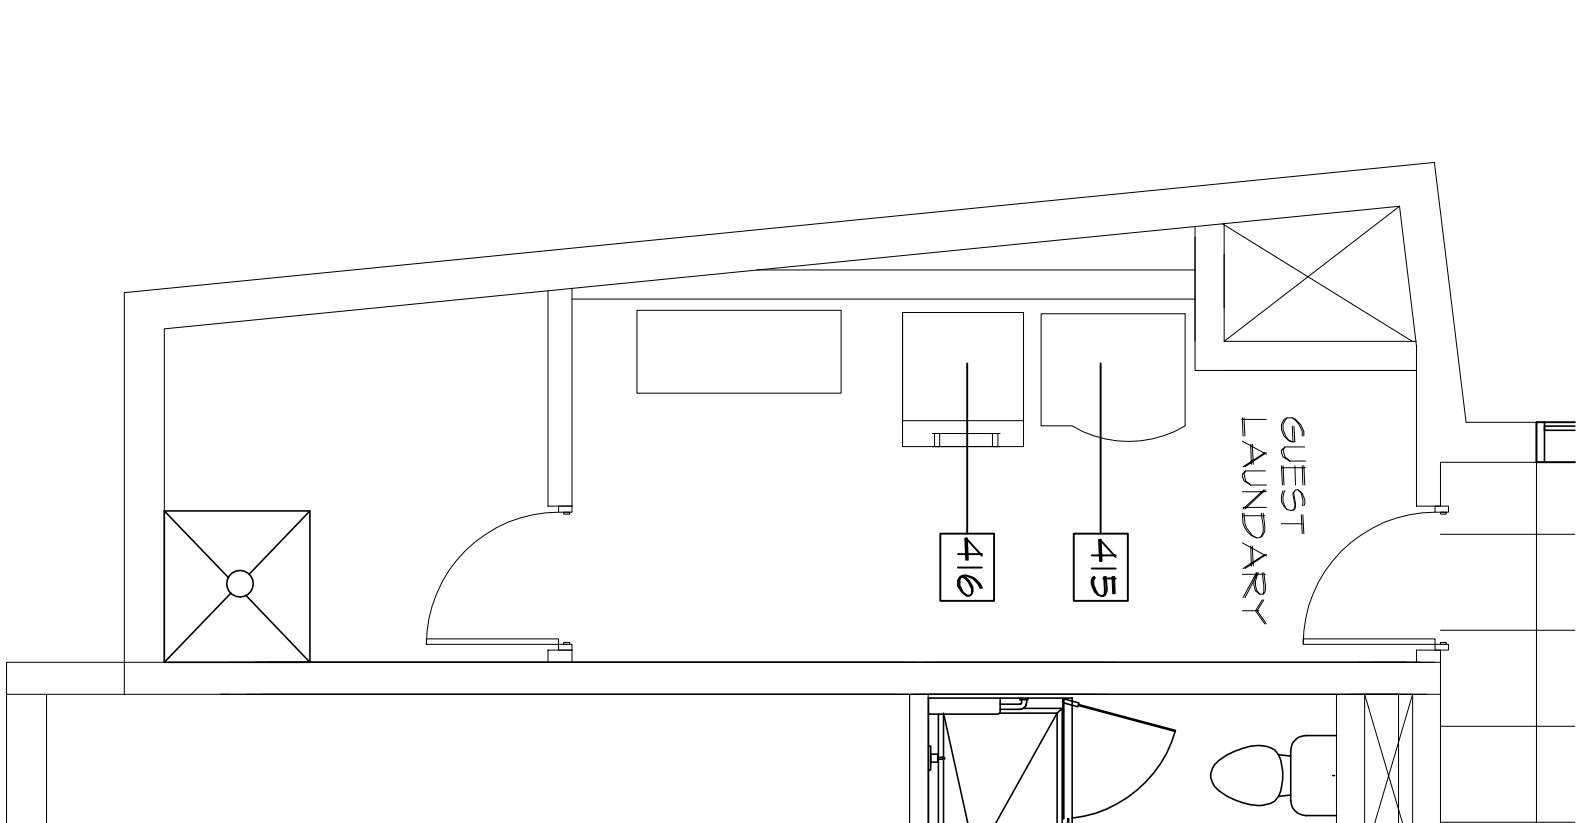

1A GUEST LAUNDRY  
 SCALE 1/4"=1'-0"

**EQUIPMENT SCHEDULE - LAUNDRY**

MARK	QTY.	DESCRIPTION	COMMENTS	LOCATION
311	1	Masher/Extractor 65 Lb. - Hard Mount	Bolt Down	Laundry
312	1	Masher/Extractor 80 Lb. - Hard Mount	Bolt Down	Laundry
313	1	Masher/Extractor 55 Lb. - Soft Mount	Bolt Down, Not Shown	Laundry
314	1	Masher/Extractor 75 Lb. - Soft Mount	Bolt Down, Not Shown;	Laundry
321	1	Dryer - Electric 75 Lb.	Bolt Down, Not Shown	Laundry
322	1	Dryer - Gas 75 Lb.	Bolt-Down	Laundry
323	1	Dryer - Gas 120 Lb.	Bolt-Down	Laundry
361	Vfy.	Shelves - Mobile		Laundry
362	Vfy.	Trucks - Mobile		Laundry
363	1	Chemical System	By Vendor; NIKEC	Laundry
371	1	Table - Folding		Laundry
372	2	Shelves - Mail		Laundry
381	1	Laundry Scale		Laundry
382	1	Helping Hand		Laundry
391	Vfy.	Linen Carrier - Soiled Linen		Laundry
392	Vfy.	Clean Linen Carrier		Laundry
393	Vfy.	Clean Linen Carrier - Nest Coost	Not Shown, Option to 392	Laundry
411	1	Guest Masher		Guest Laundry
412	1	Guest Dryer		Guest Laundry
413	1	Folding Table	By G.C.; NIKEC	Guest Laundry
414	1	Guest Dryer - Gas	Not Shown	Guest Laundry
415	1	Guest Masher (ADA)	Not Shown	Guest Laundry
416	1	Guest Dryer - Electric (ADA)	Not Shown	Guest Laundry
417	1	Guest Dryer - Gas (ADA)	Not Shown	Guest Laundry

NIKEC - Not in Kitchen Equipment Contract


3A  
 SCALE 3/8"=1'-0"

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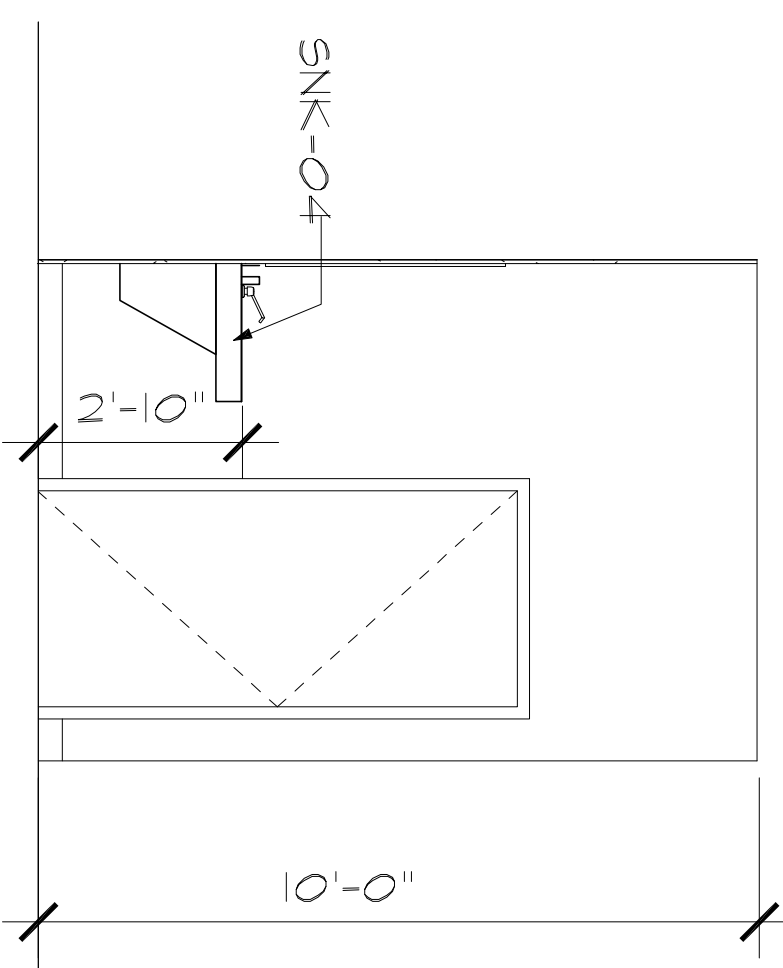
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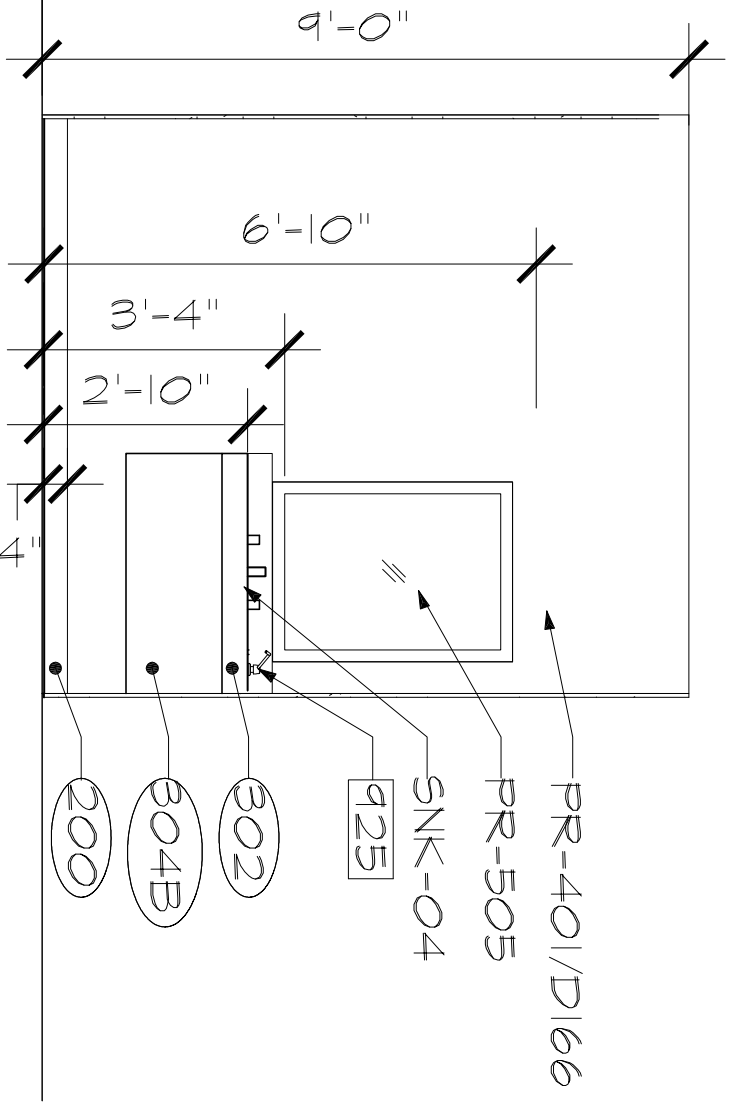
NO.	DATE	DESCRIPTION
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ISSUES & REVISIONS	
NO.	DESCRIPTION


PROJECT NAME:	MARRIOTT FAIRFIELD
DRAWING NO.:	A404
DRAWN BY:	NK
CHECKED BY:	BBC/ANK
DATE:	7-30-14
SCALE:	AS NOTED
DRAWING NUMBER:	A404




4D ELEVATION - MEN'S RESTROOM  
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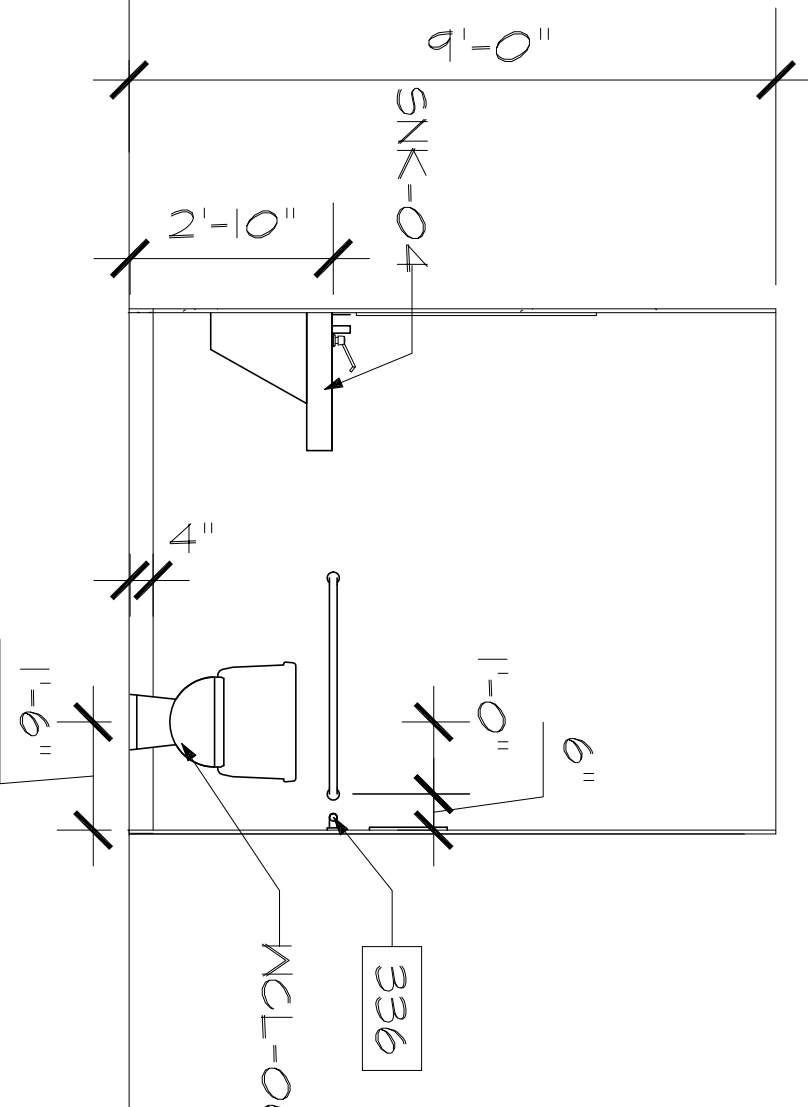
3D ELEVATION - MEN'S RESTROOM  
 SCALE 3/8"=1'-0"

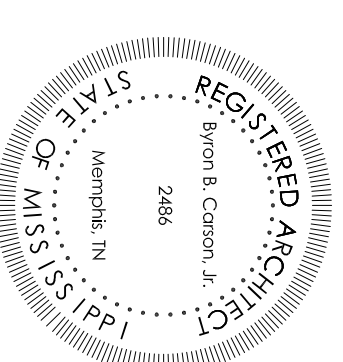


4C ELEVATION - WOMEN'S RESTROOM  
 SCALE 3/8"=1'-0"

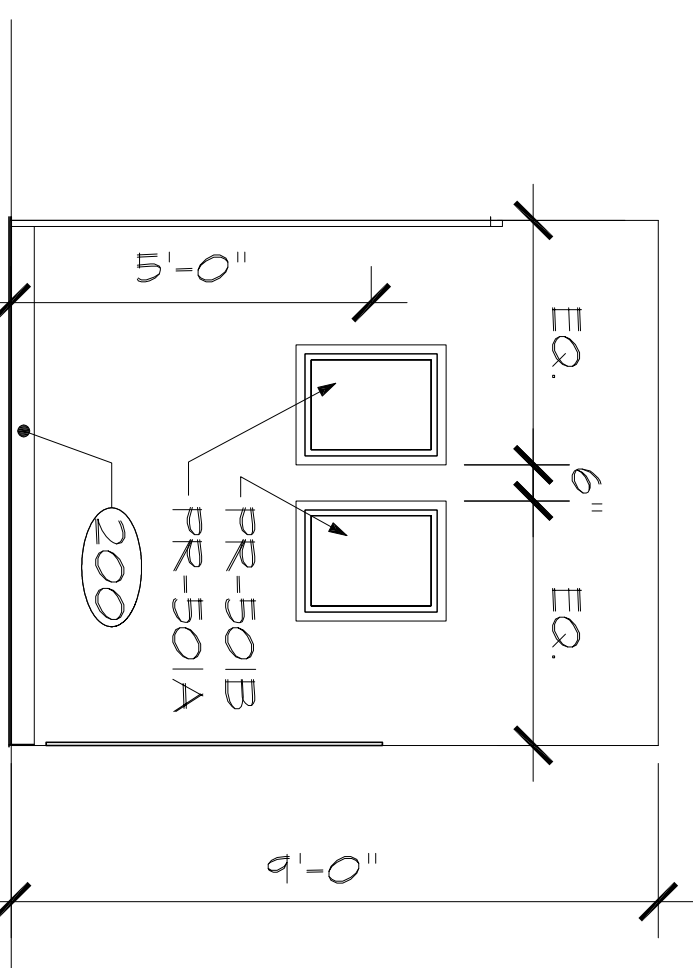


3C ELEVATION - WOMEN'S RESTROOM  
 SCALE 3/8"=1'-0"

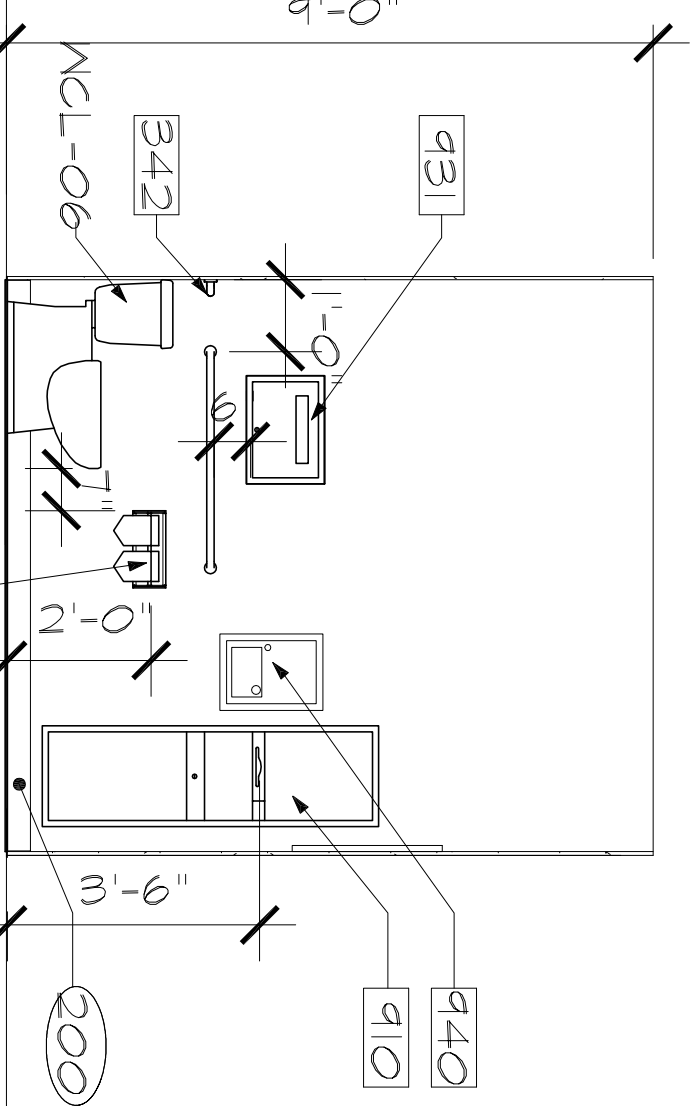


2C ELEVATION - WOMEN'S RESTROOM  
 SCALE 3/8"=1'-0"

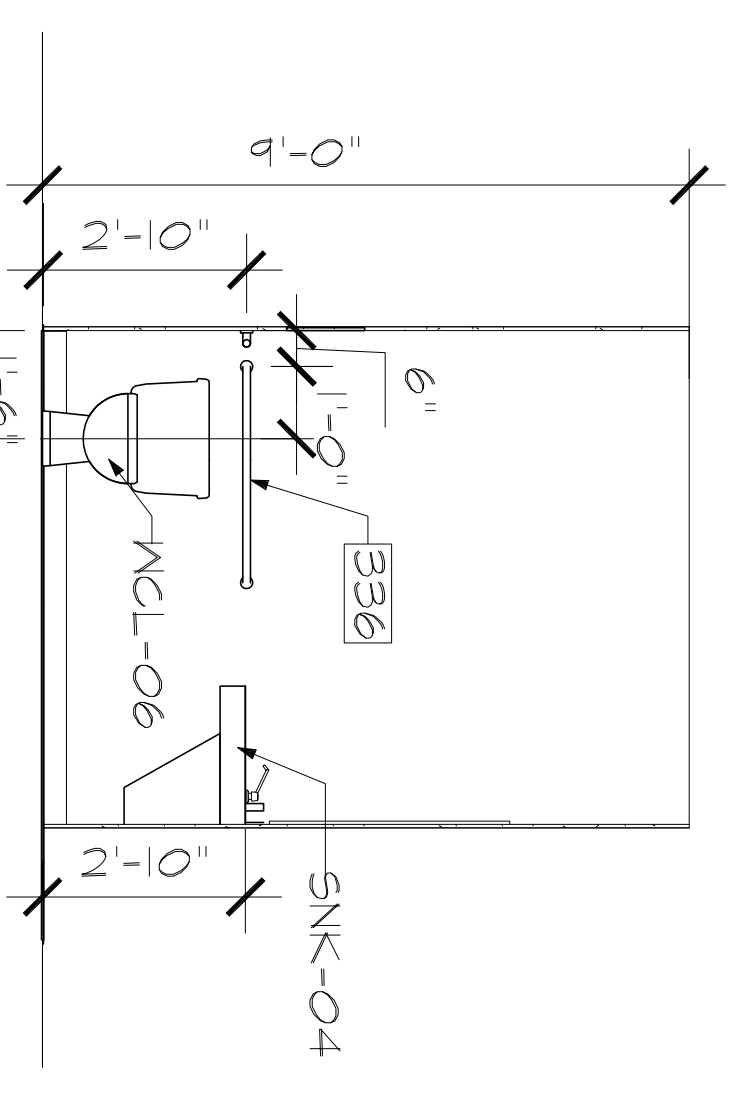


2D ELEVATION - MEN'S RESTROOM  
 SCALE 3/8"=1'-0"

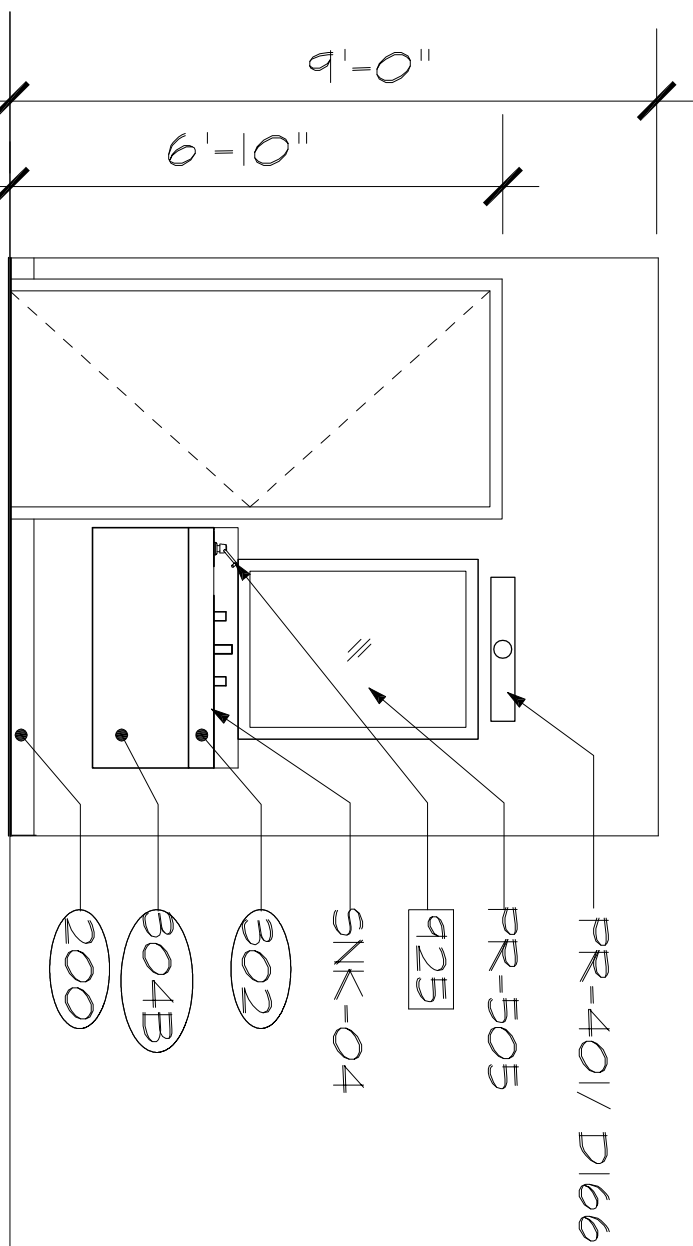


1C ELEVATION - WOMEN'S RESTROOM  
 SCALE 3/8"=1'-0"

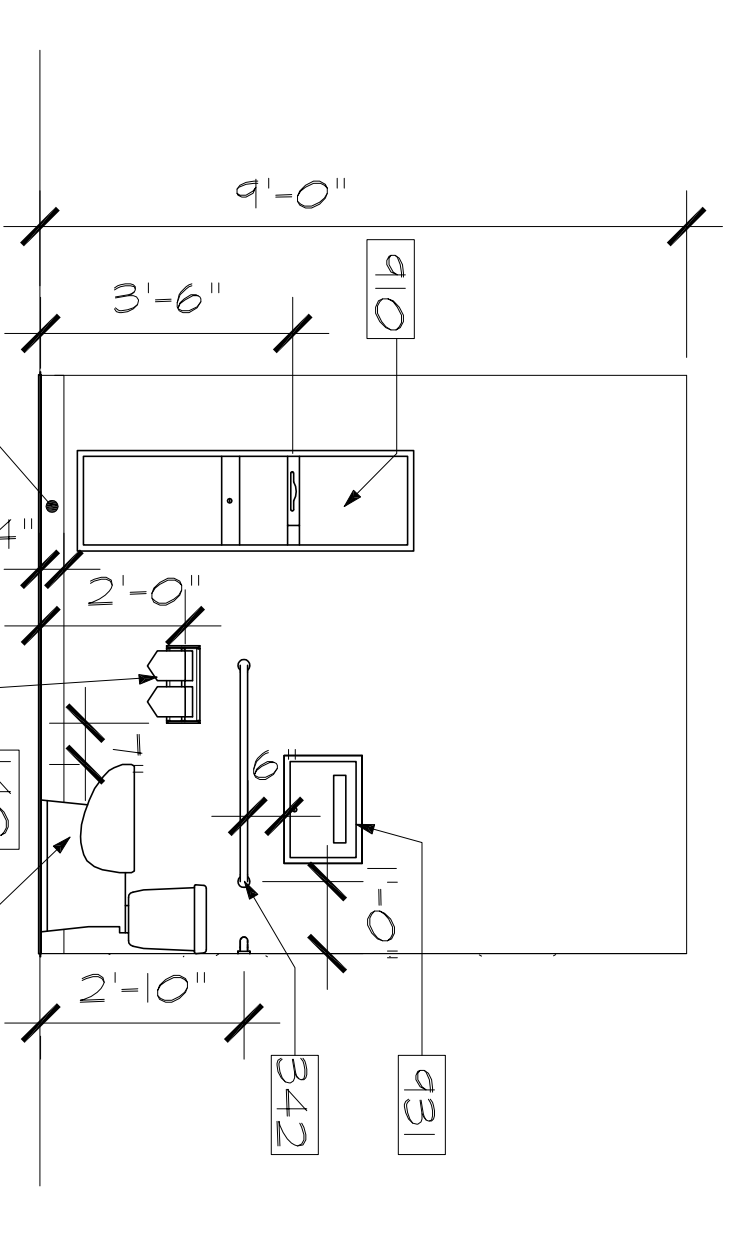

1D ELEVATION - MEN'S RESTROOM  
 SCALE 3/8"=1'-0"

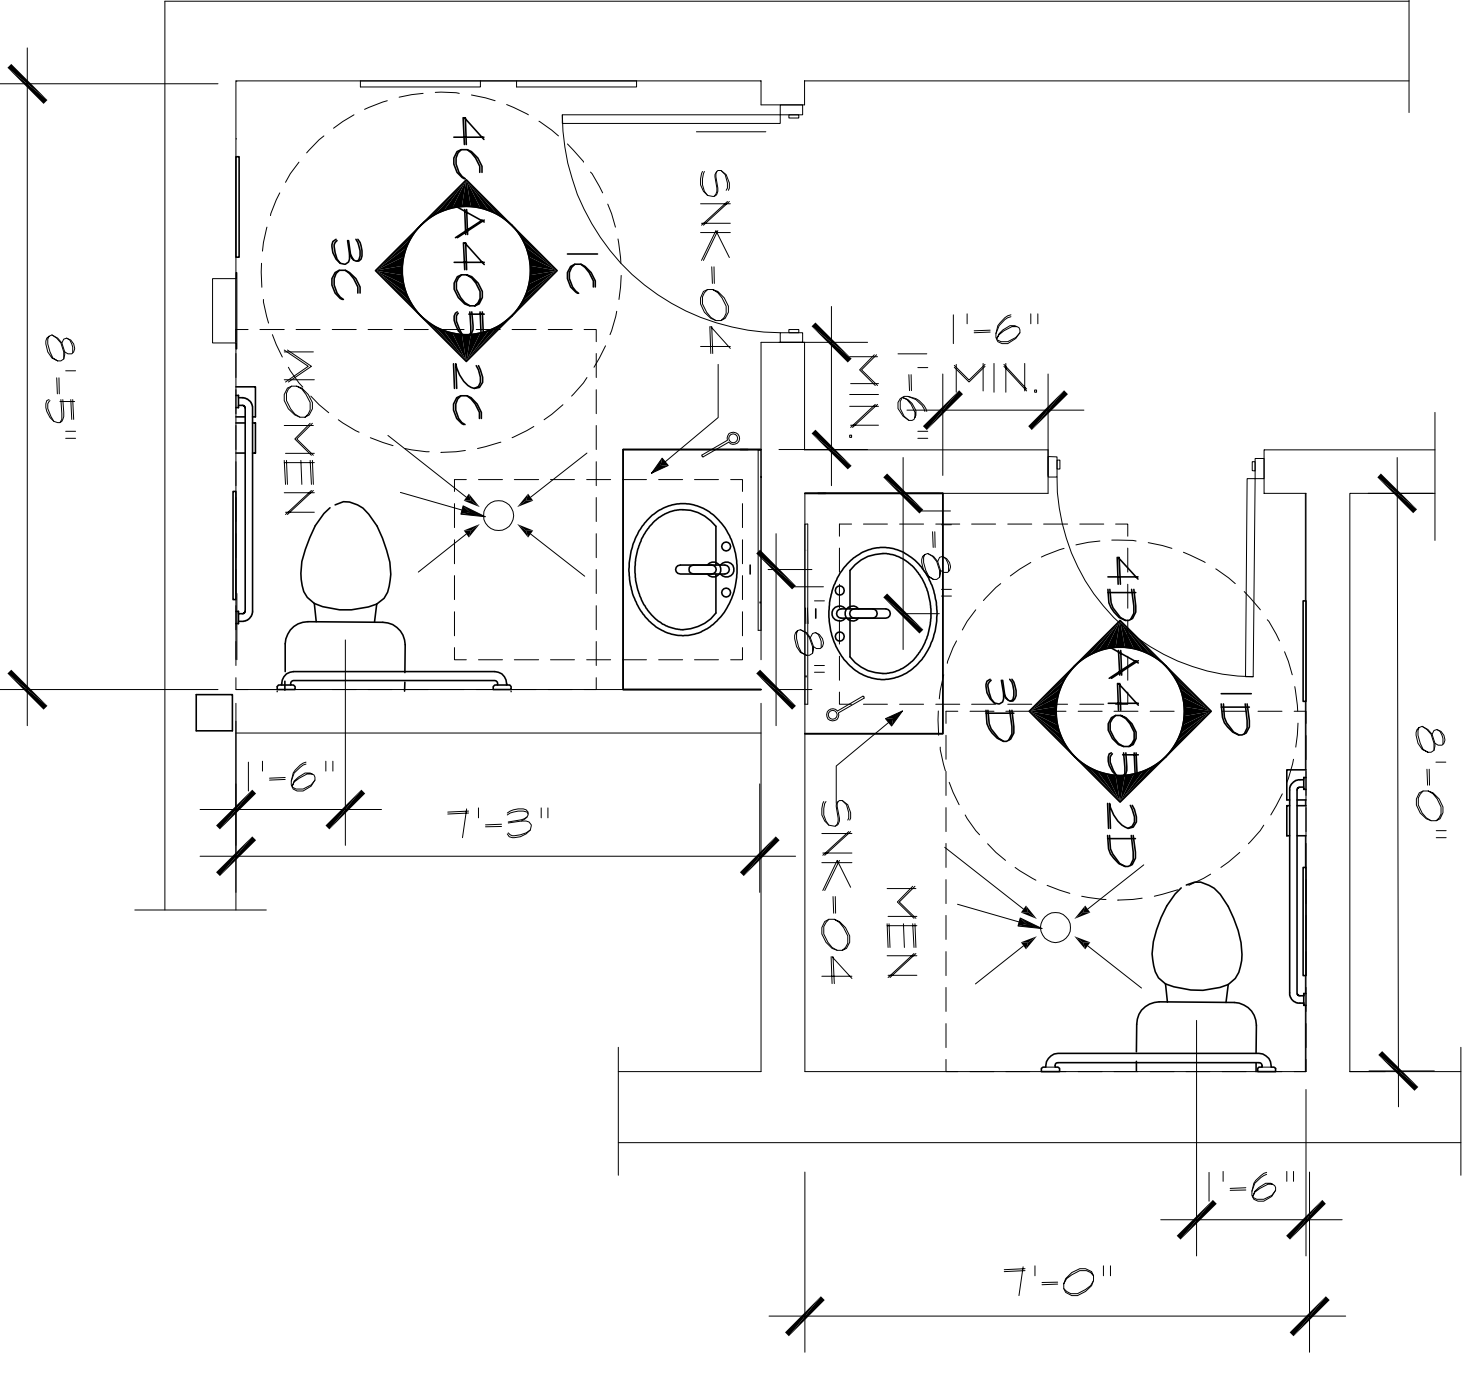

1A PLAN - PUBLIC SPACE BATHROOMS  
 SCALE 3/8"=1'-0"

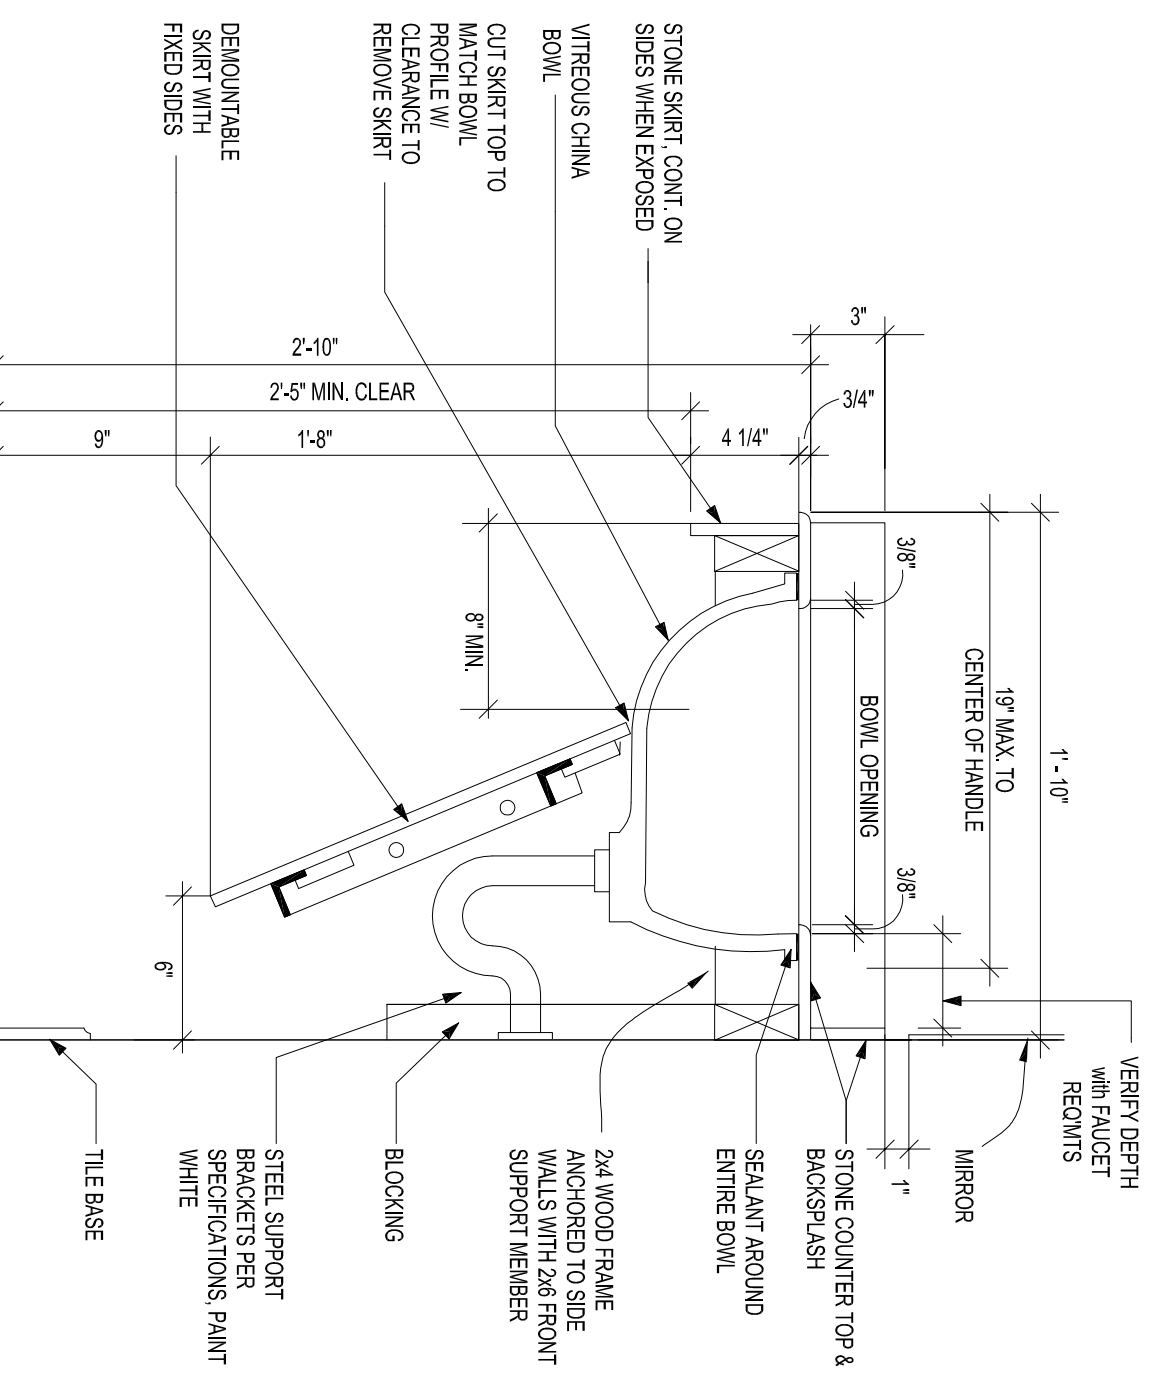


2A DETAILS  
 SCALE 1 1/2"=1'-0"

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5134 ELMORE, SUITE 6  
MEMPHIS, TN 38134  
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FAX: 901.208.8842  
bcarson.carsoninc@comcast.net


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290 POWER DRIVE,  
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CONSULTANTS



1A EQUIPMENT - FOOD PREP KITCHEN  
SCALE 1/4"=1'-0"

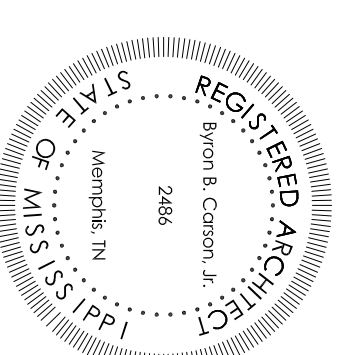
ISSUES & REVISIONS	
NO.	DESCRIPTION
1	04/27/2014 CODE SUBMITTAL


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DRAWING NUMBER:	
DRAWING NAME:	
SHEET NAME:	KITCHEN

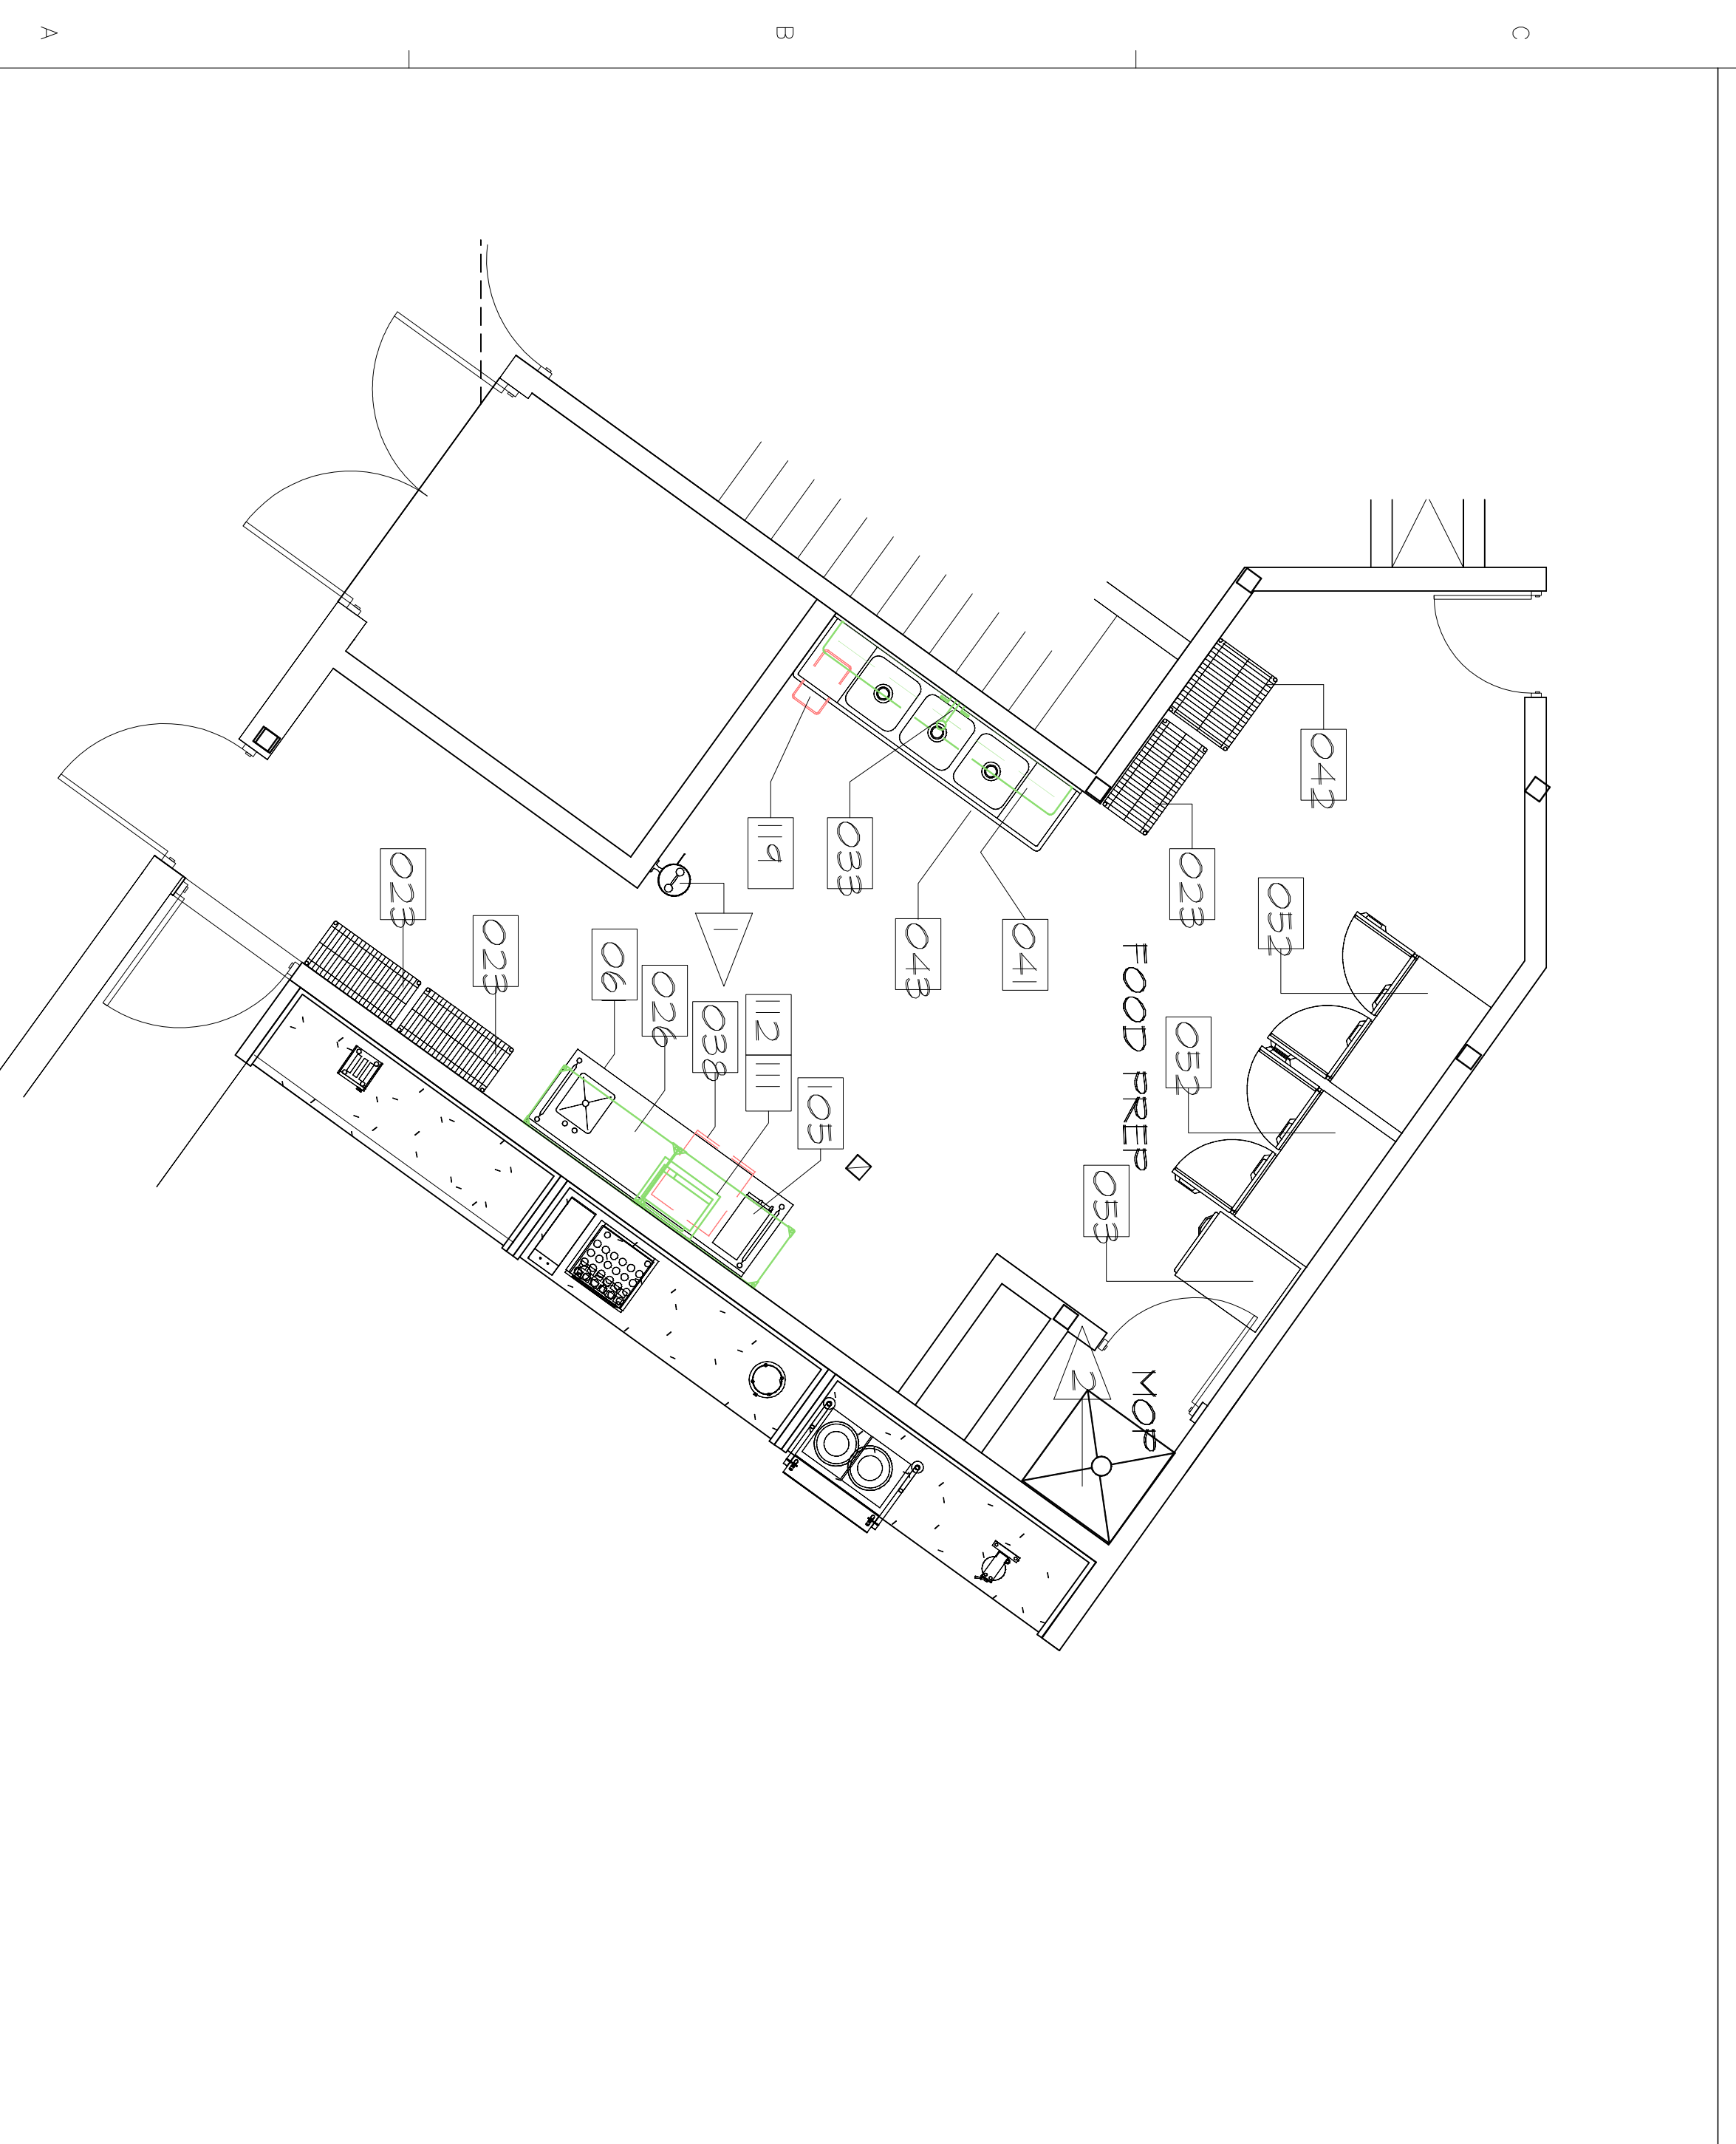
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CHECKED BY:	BBC/ANK
DATE:	7-30-14
SCALE:	AS NOTED
DRAWING NUMBER:	A405




1C PLAN - KING  
SCALE 1/4"=1'-0"

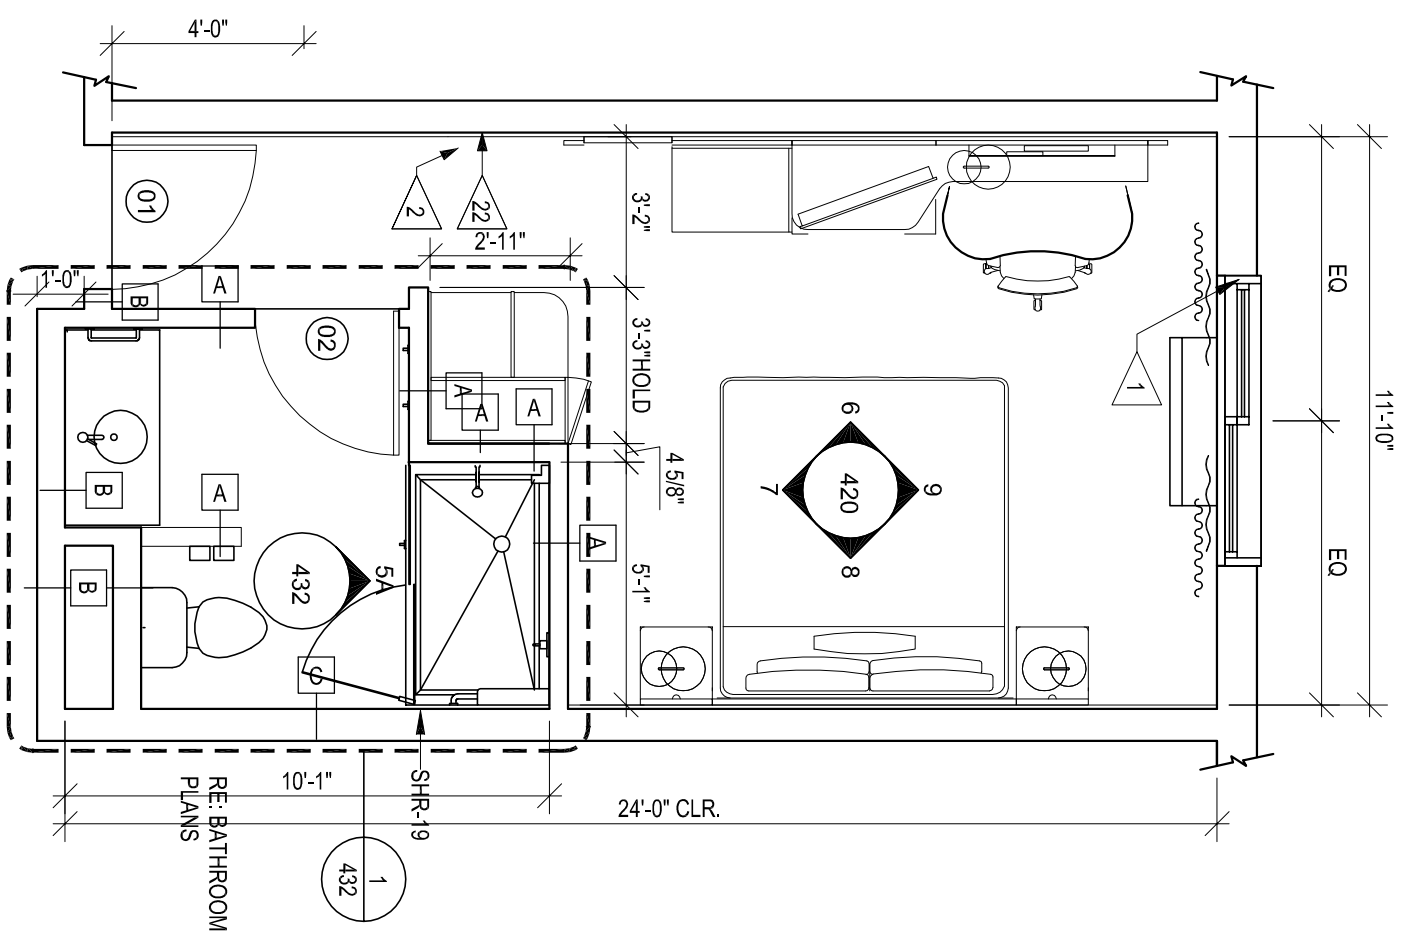

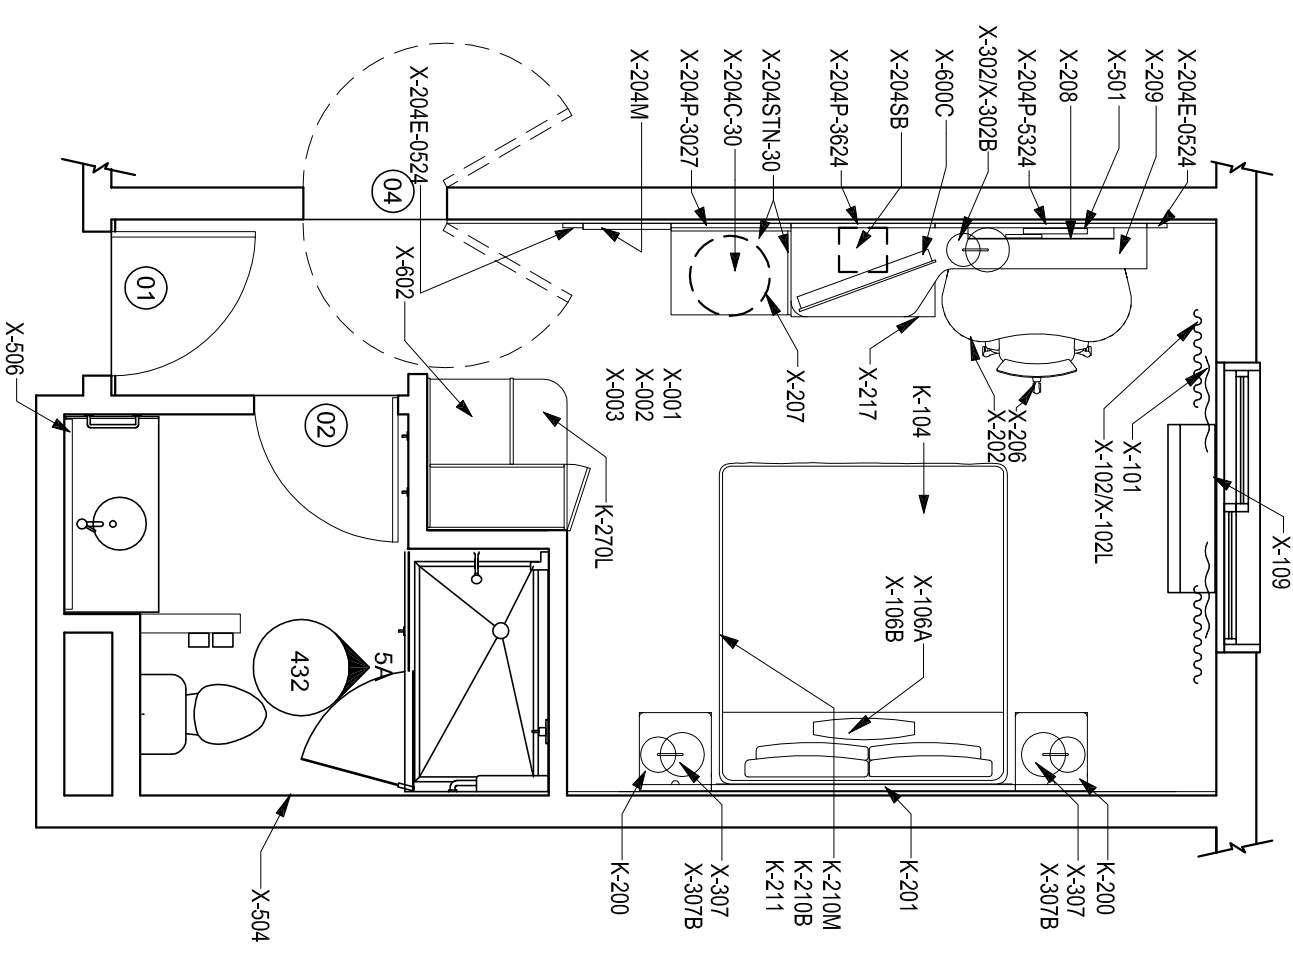
2C PLAN - FURNITURE LEFT  
SCALE 1/4"=1'-0"

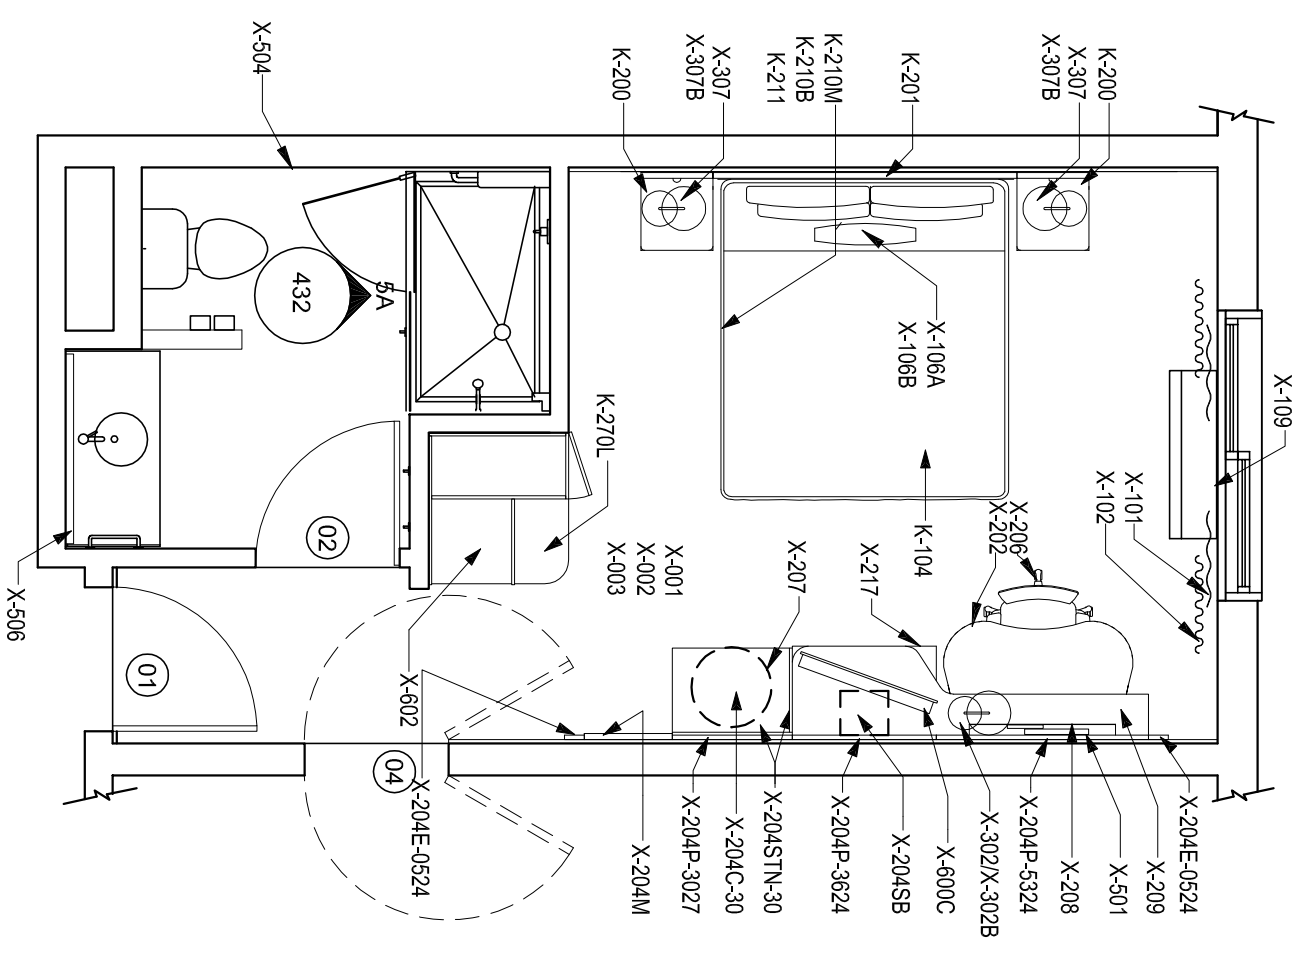


3C PLAN - FURNITURE RIGHT  
SCALE 1/4"=1'-0"

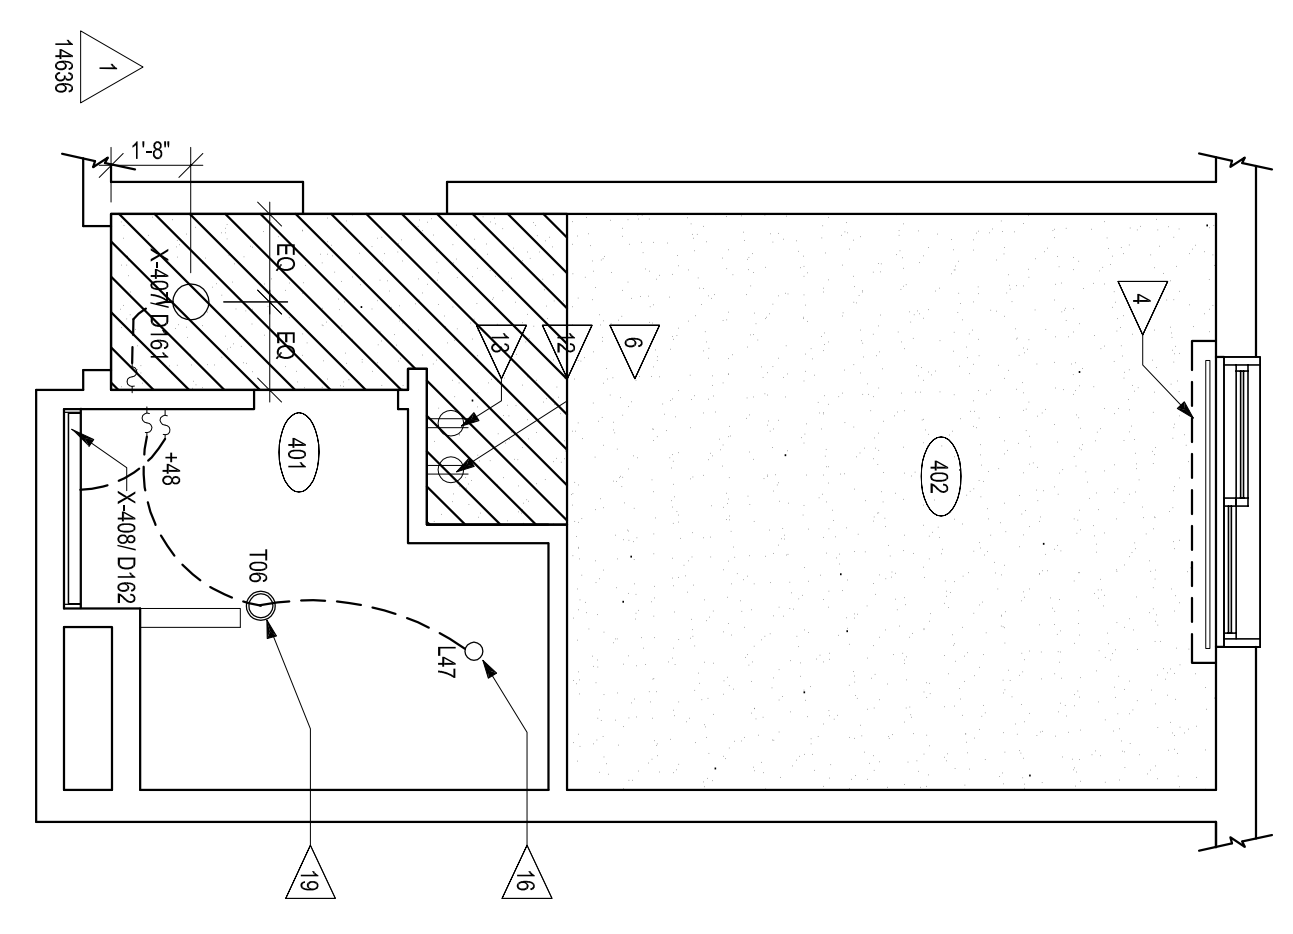


4C REFLECTED CEILING PLAN  
SCALE 1/4"=1'-0"

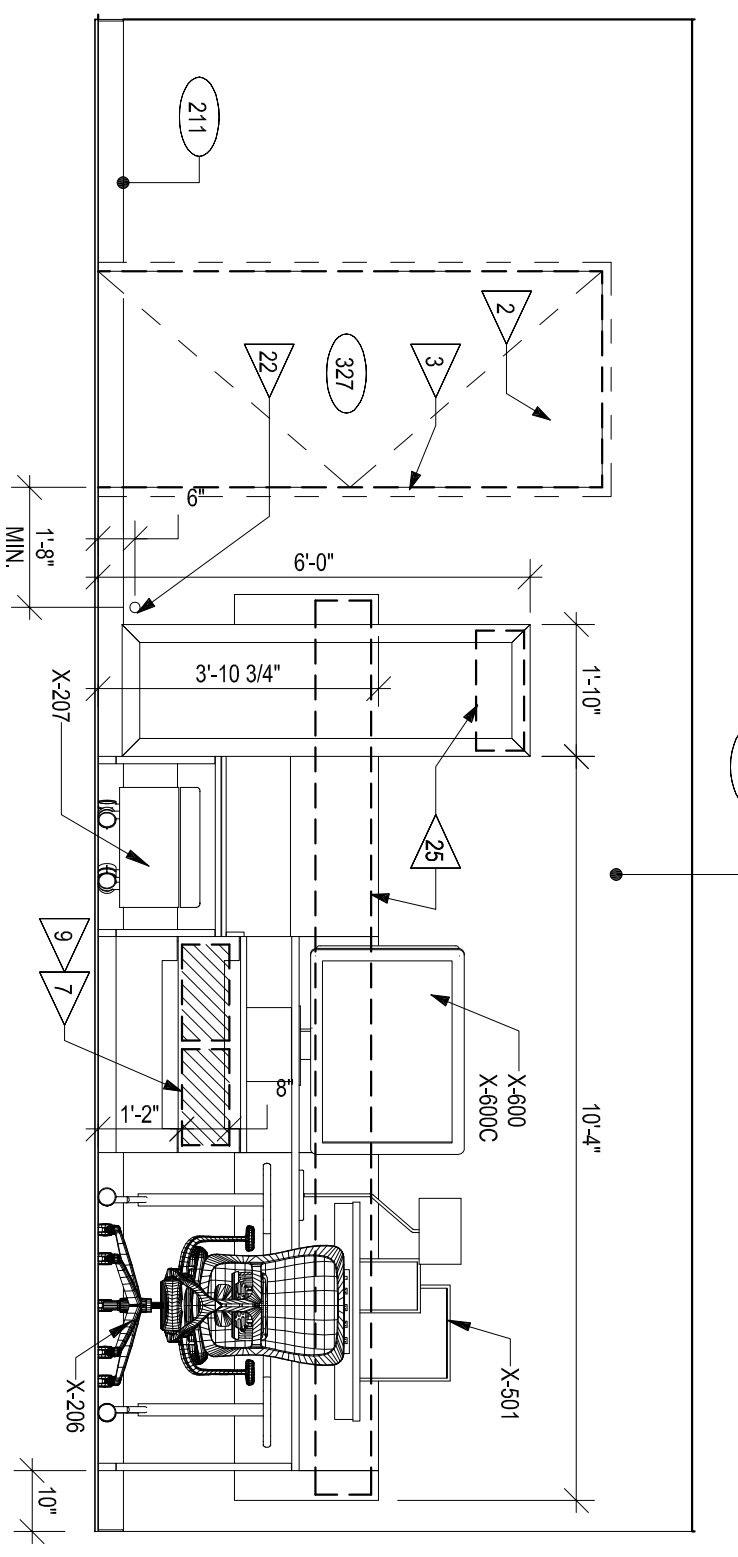


1B INTERIOR ELEVATION  
SCALE 3/8"=1'-0"

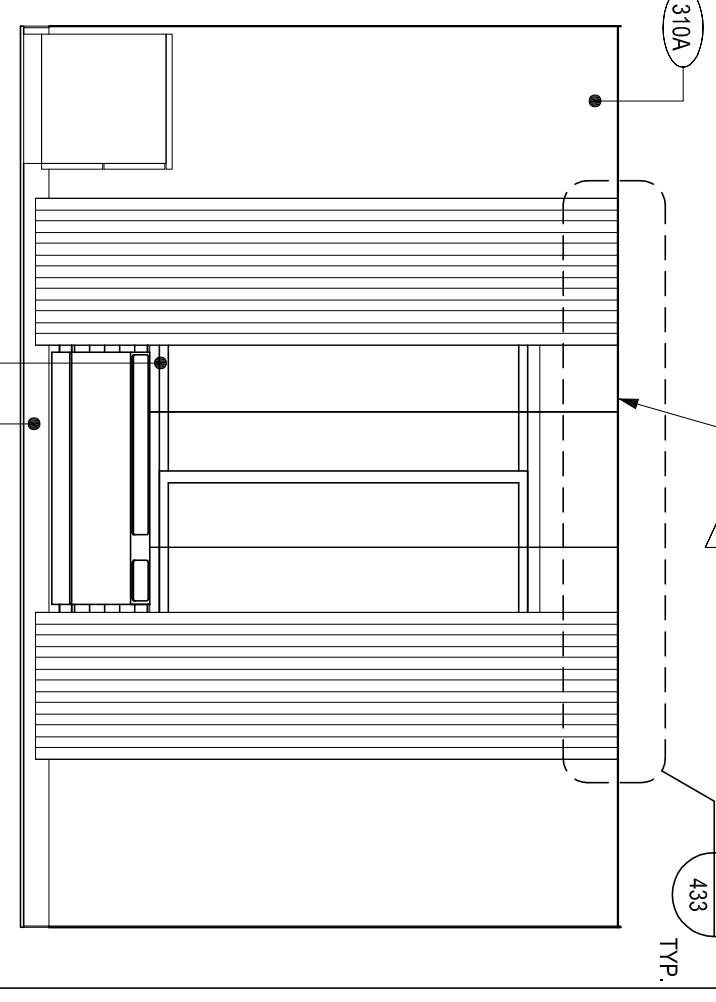

3B INTERIOR ELEVATION  
SCALE 3/8"=1'-0"

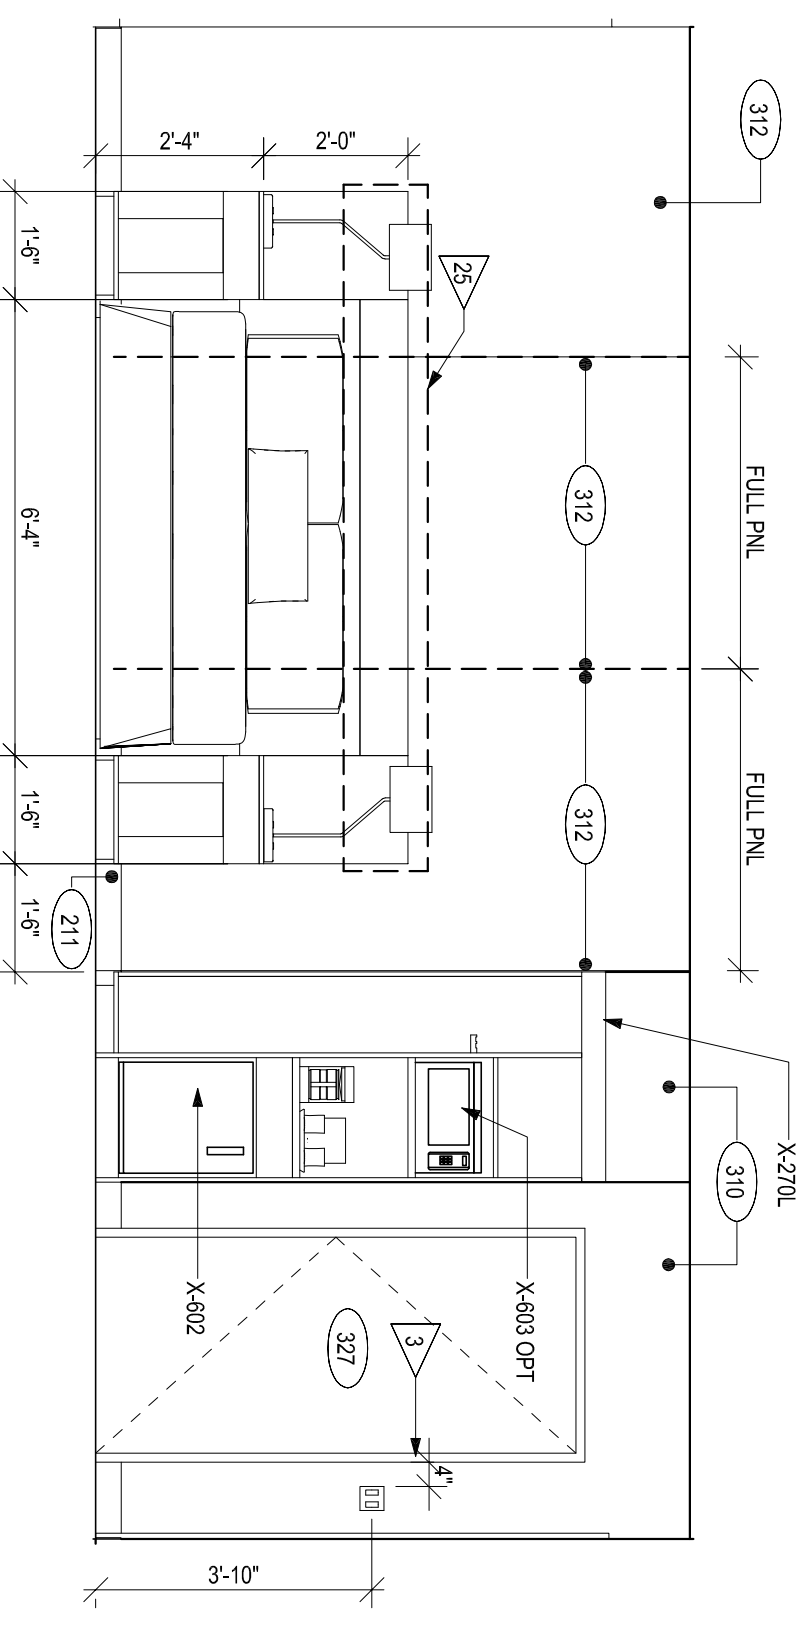

1A INTERIOR ELEVATION  
SCALE 3/8"=1'-0"

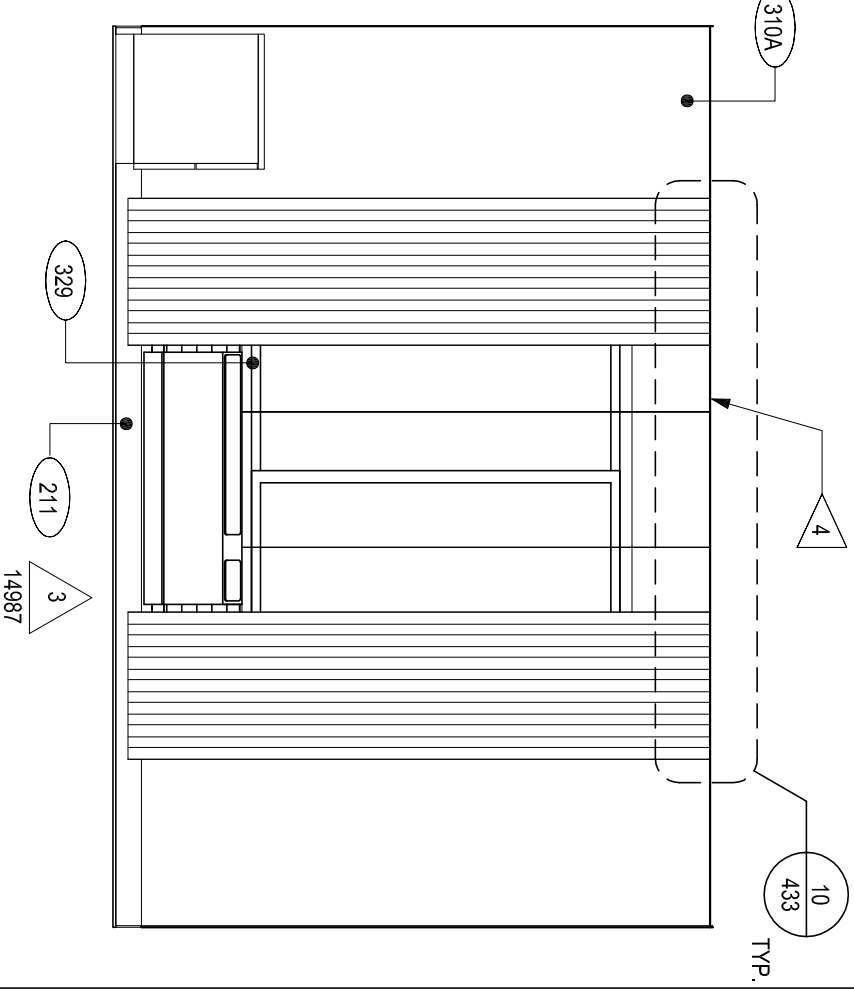

3A INTERIOR ELEVATION  
SCALE 3/8"=1'-0"

PROJECT NUMBER: 15180  
DRAWING NUMBER: A500

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3	12/22/2015	100% REVIEW SET


100% REVIEW SET  
CONSTRUCTION

ISSUES & REVISIONS


CONSULTANTS

290 POWER DRIVE,  
BATESVILLE, MS 38606


BYRON B. CARSON, JR., AIA  
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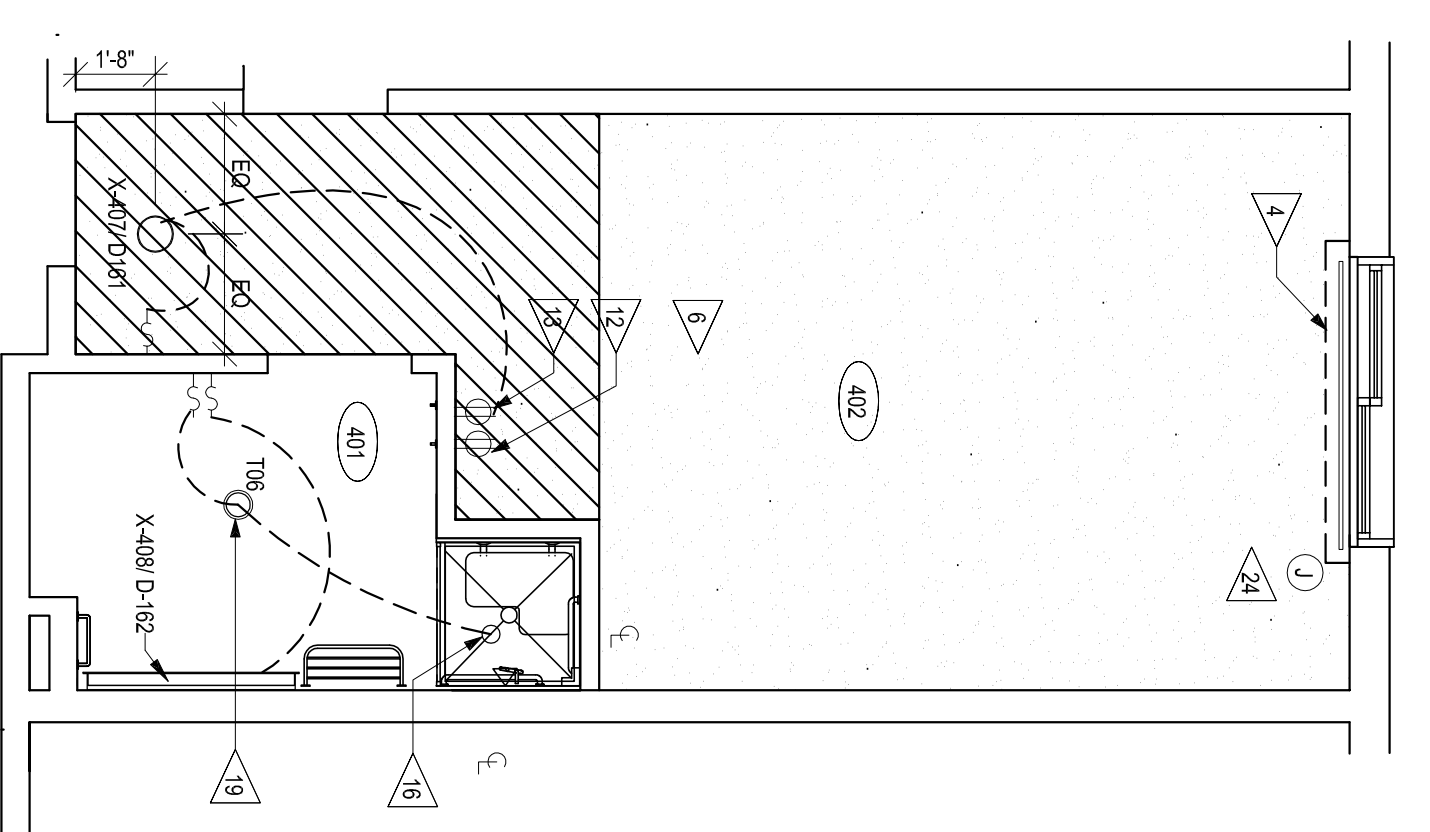
1C PLAN - KING ADA - ROLL IN SHOWER  
SCALE 1/4"=1'-0"

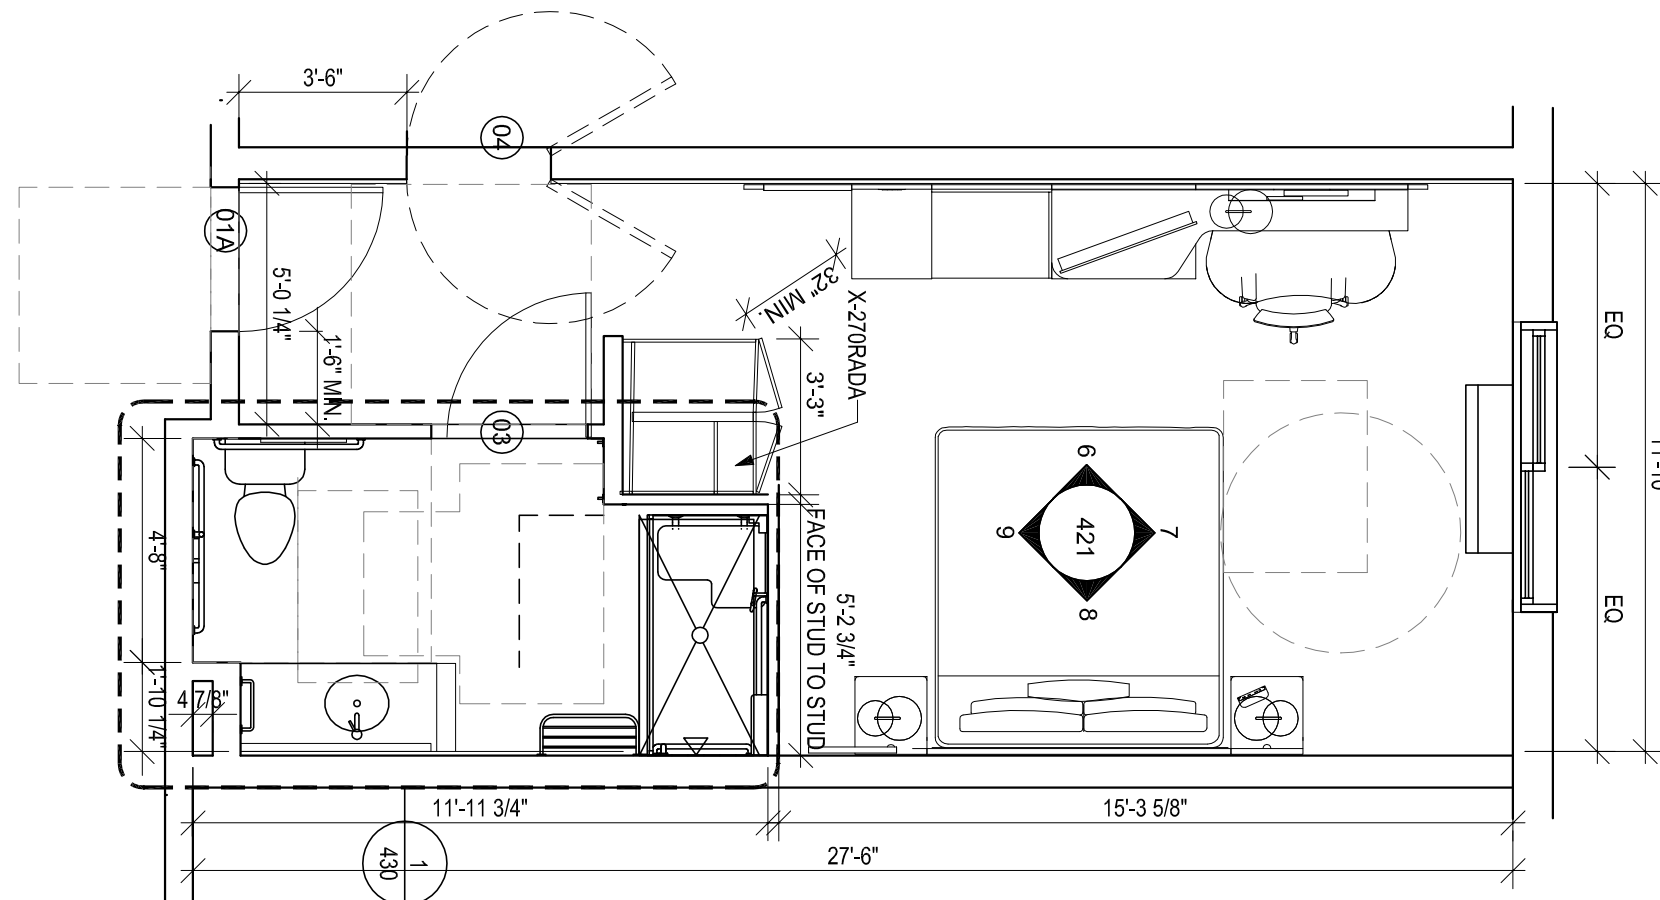


2C PLAN - FURNITURE TRANSFER SHOWER  
SCALE 1/4"=1'-0"

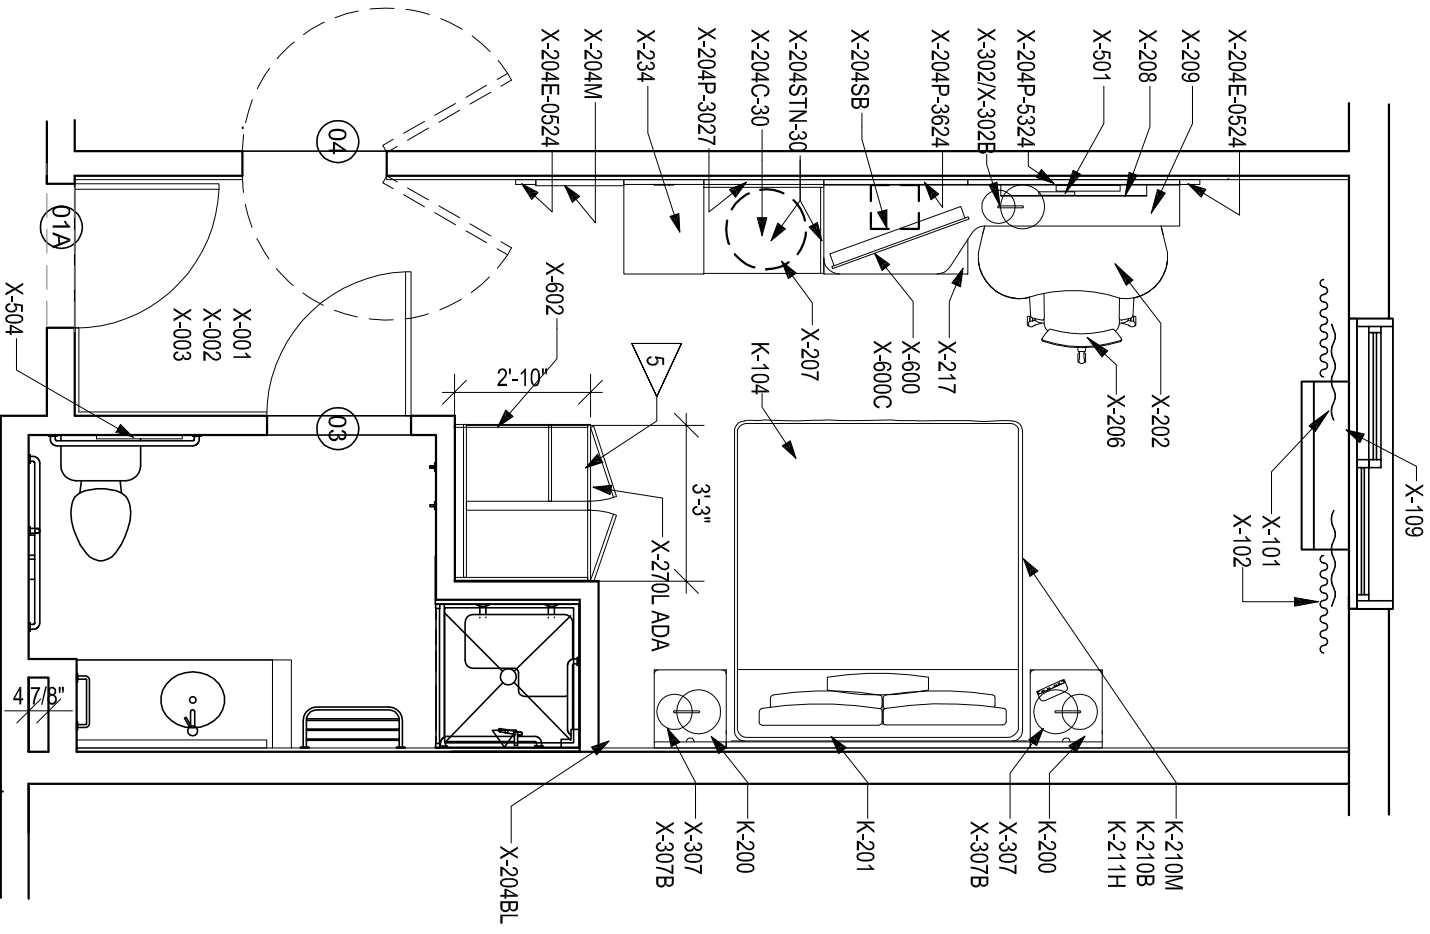


3C PLAN - FURNITURE RIGHT  
SCALE 1/4"=1'-0"

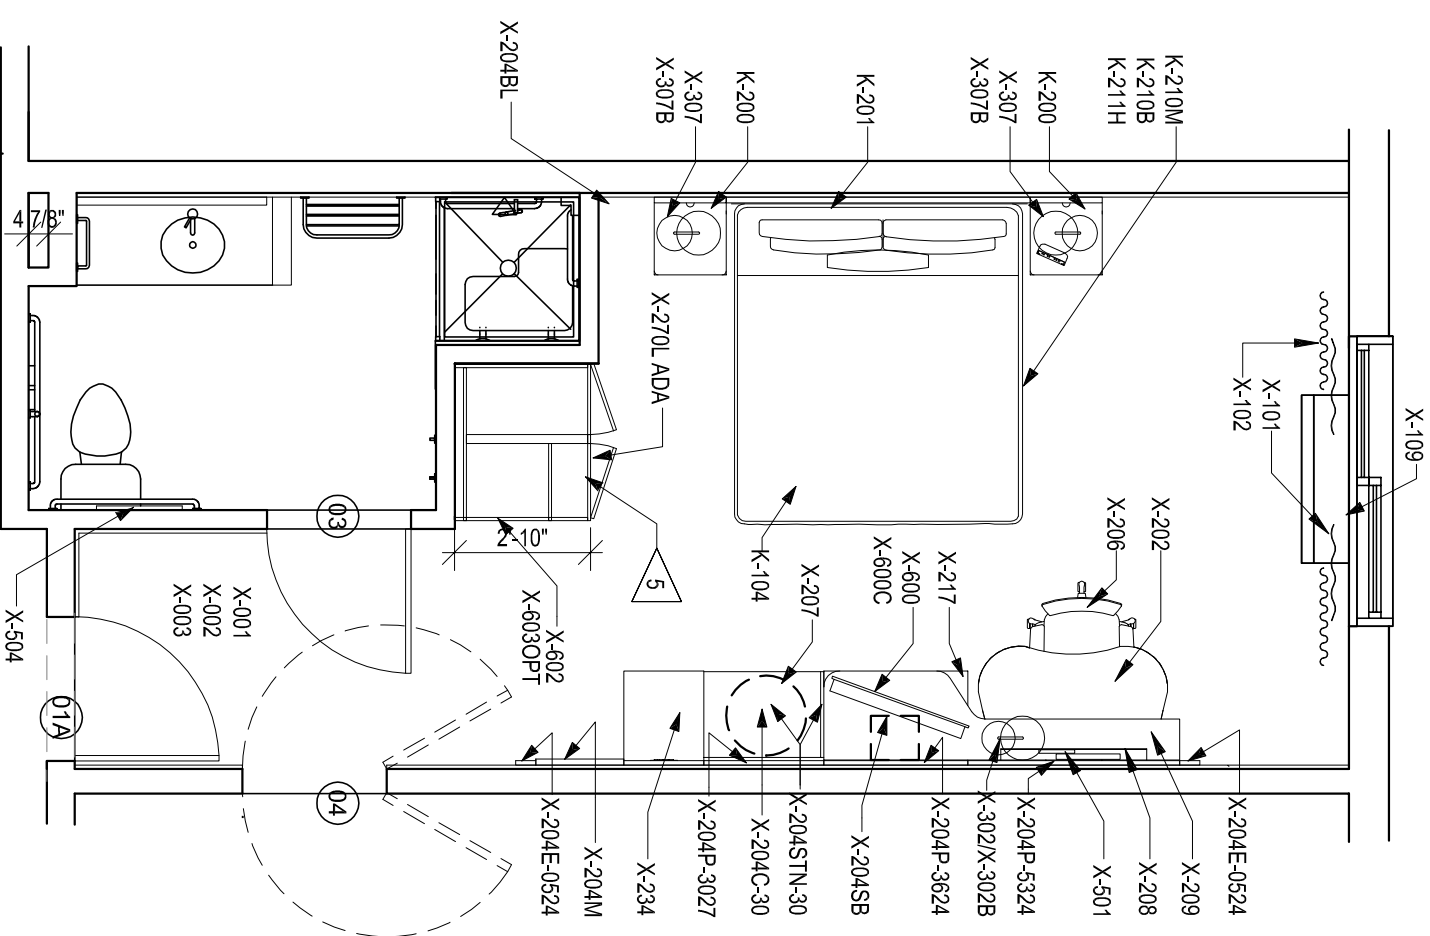


4C REFLECTED CEILING PLAN  
SCALE 1/4"=1'-0"

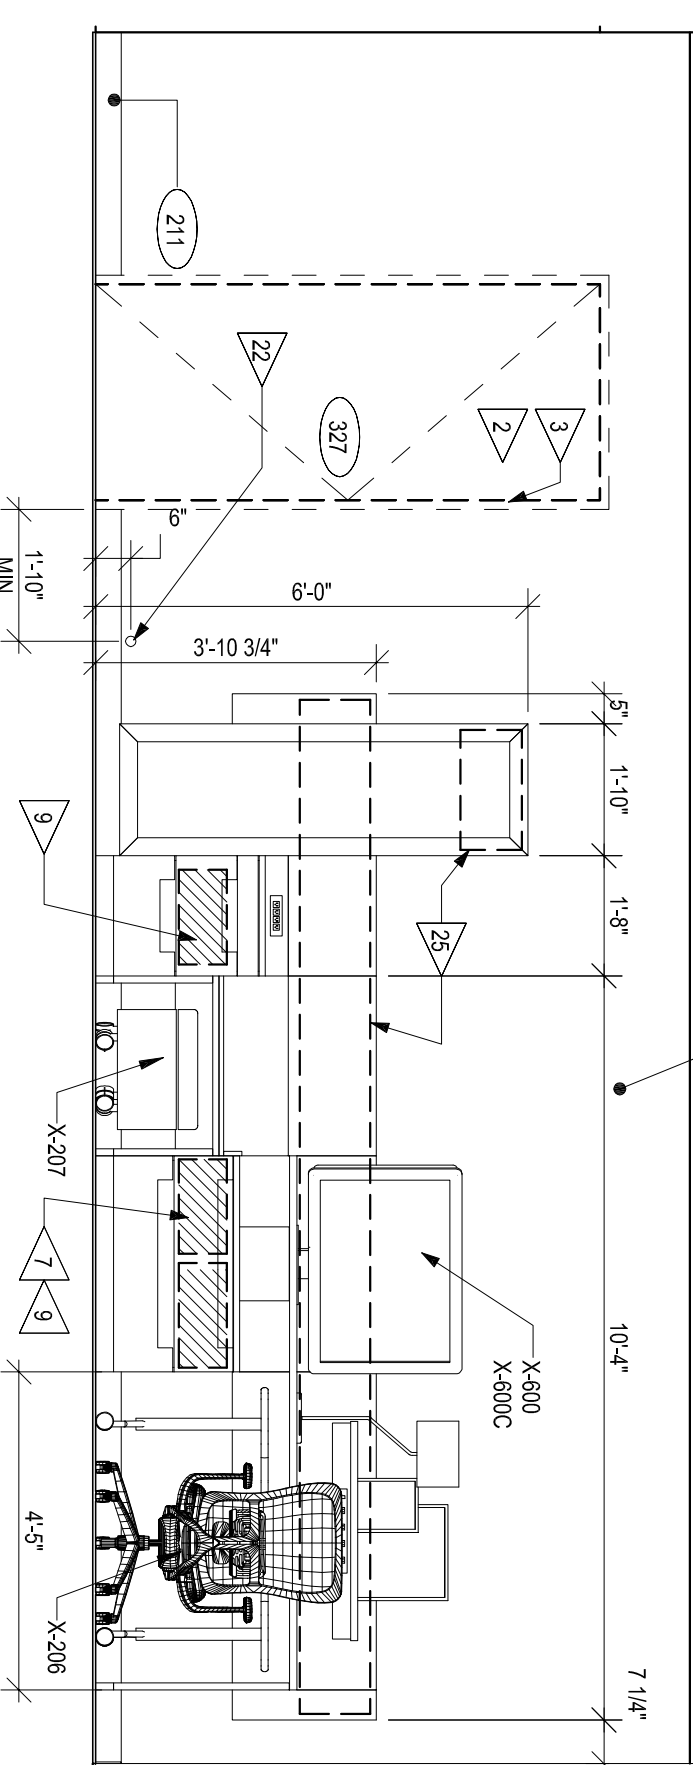


1B INTERIOR ELEVATION  
SCALE 3/8"=1'-0"

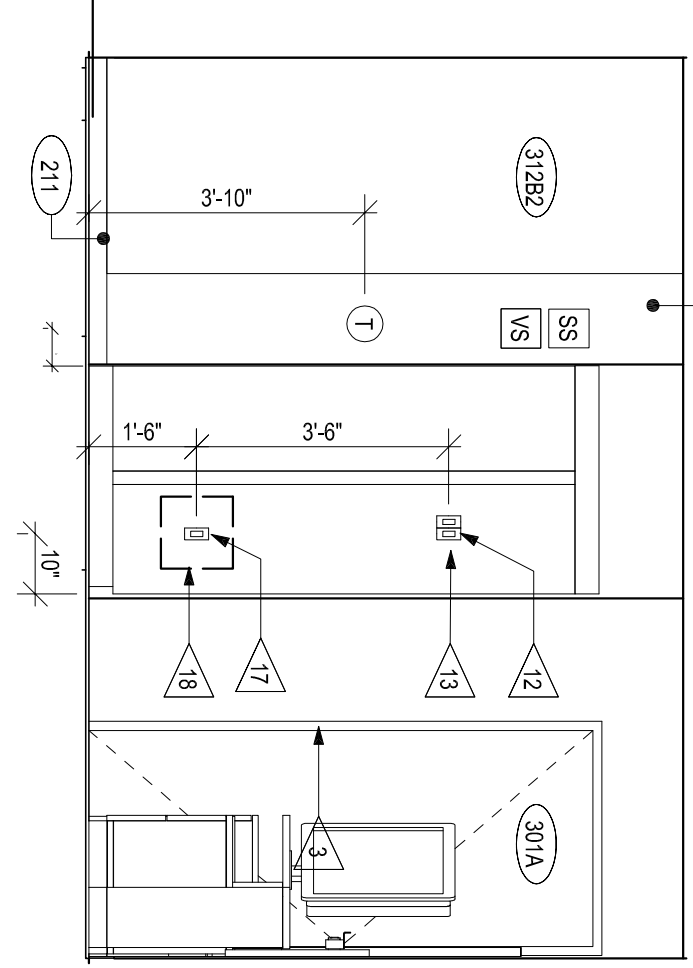

3B INTERIOR ELEVATION  
SCALE 3/8"=1'-0"

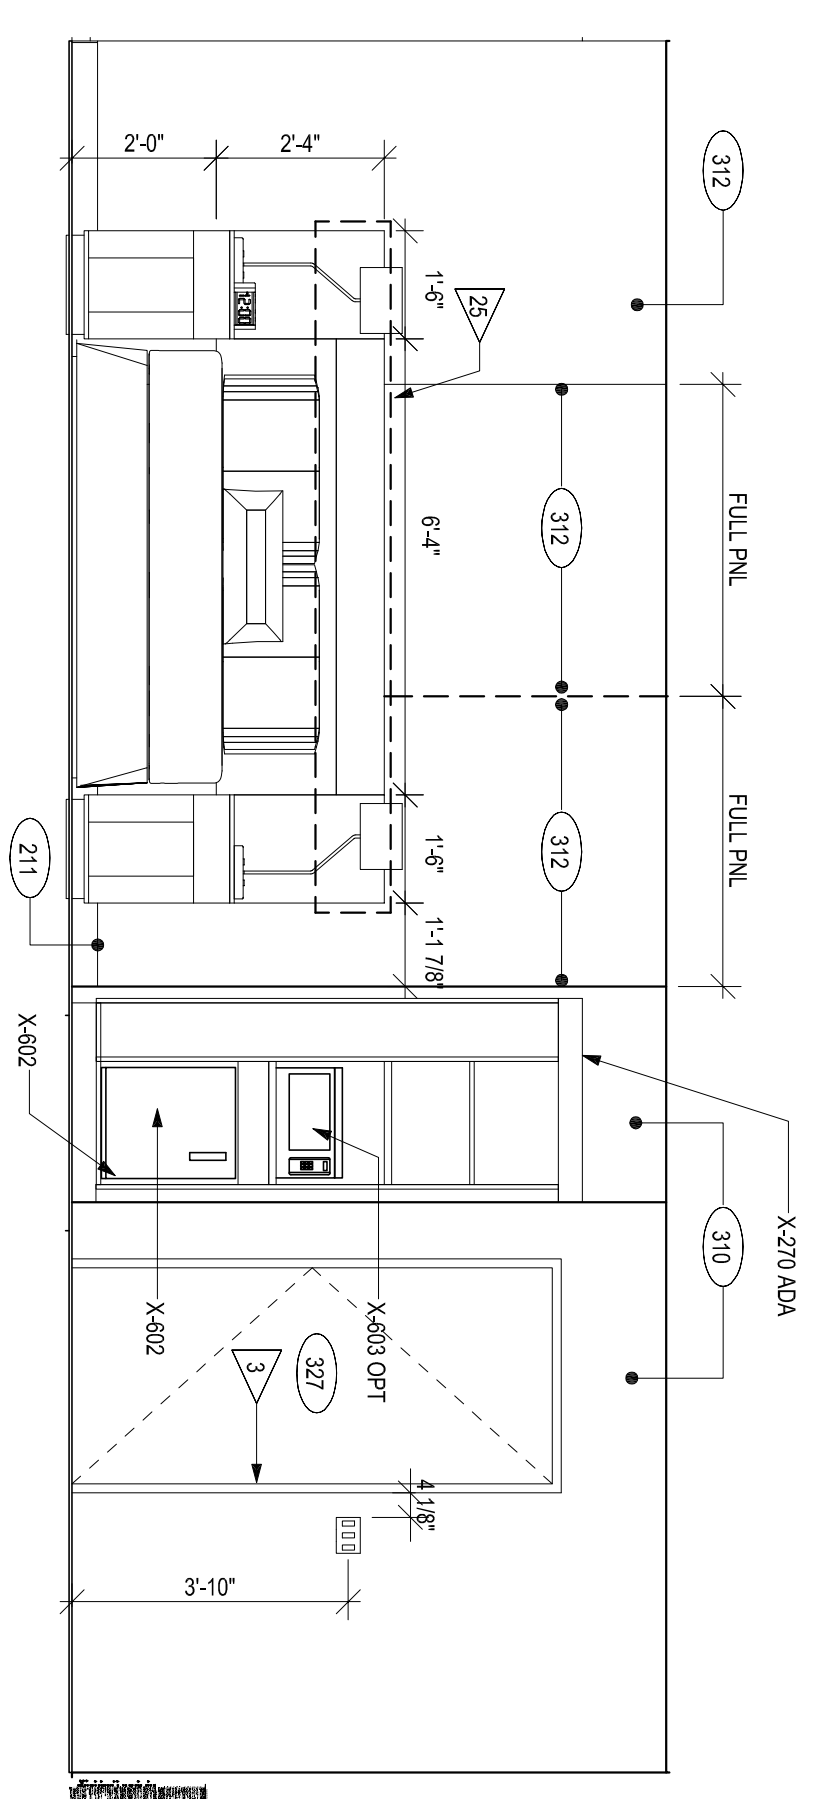

1A INTERIOR ELEVATION  
SCALE 3/8"=1'-0"

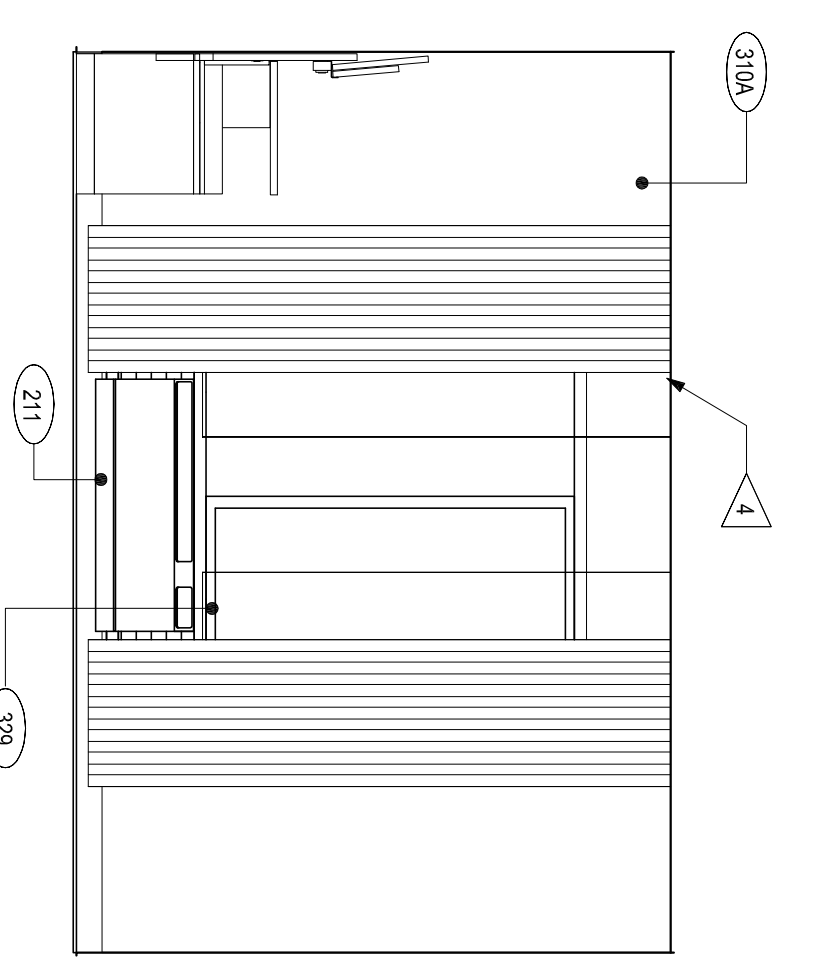

3A INTERIOR ELEVATION  
SCALE 3/8"=1'-0"

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2	11/23/2015	50% REVIEW SET
3	12/22/2015	100% REVIEW SET


PROJECT NAME:

PROJECT NUMBER: 15186


DRAWING NAME:  
SHEET NAME  
KING ADA

DRAWN BY: NK, BBC  
CHECKED BY: BBC  
DATE: 12-22-15  
SCALE: AS NOTED


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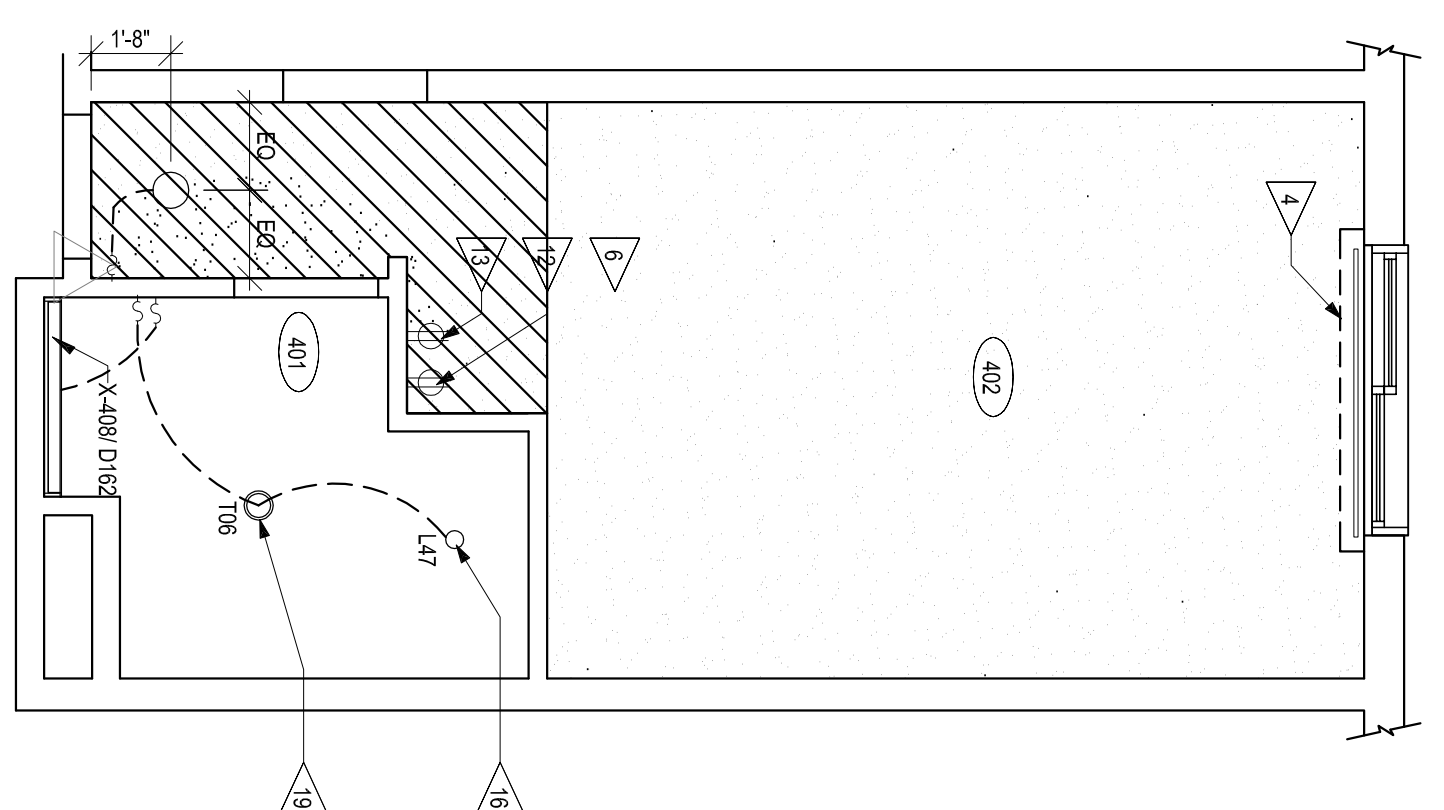
1C PLAN - QUEEN/QUEEN  
SCALE 1/4"=1'-0"

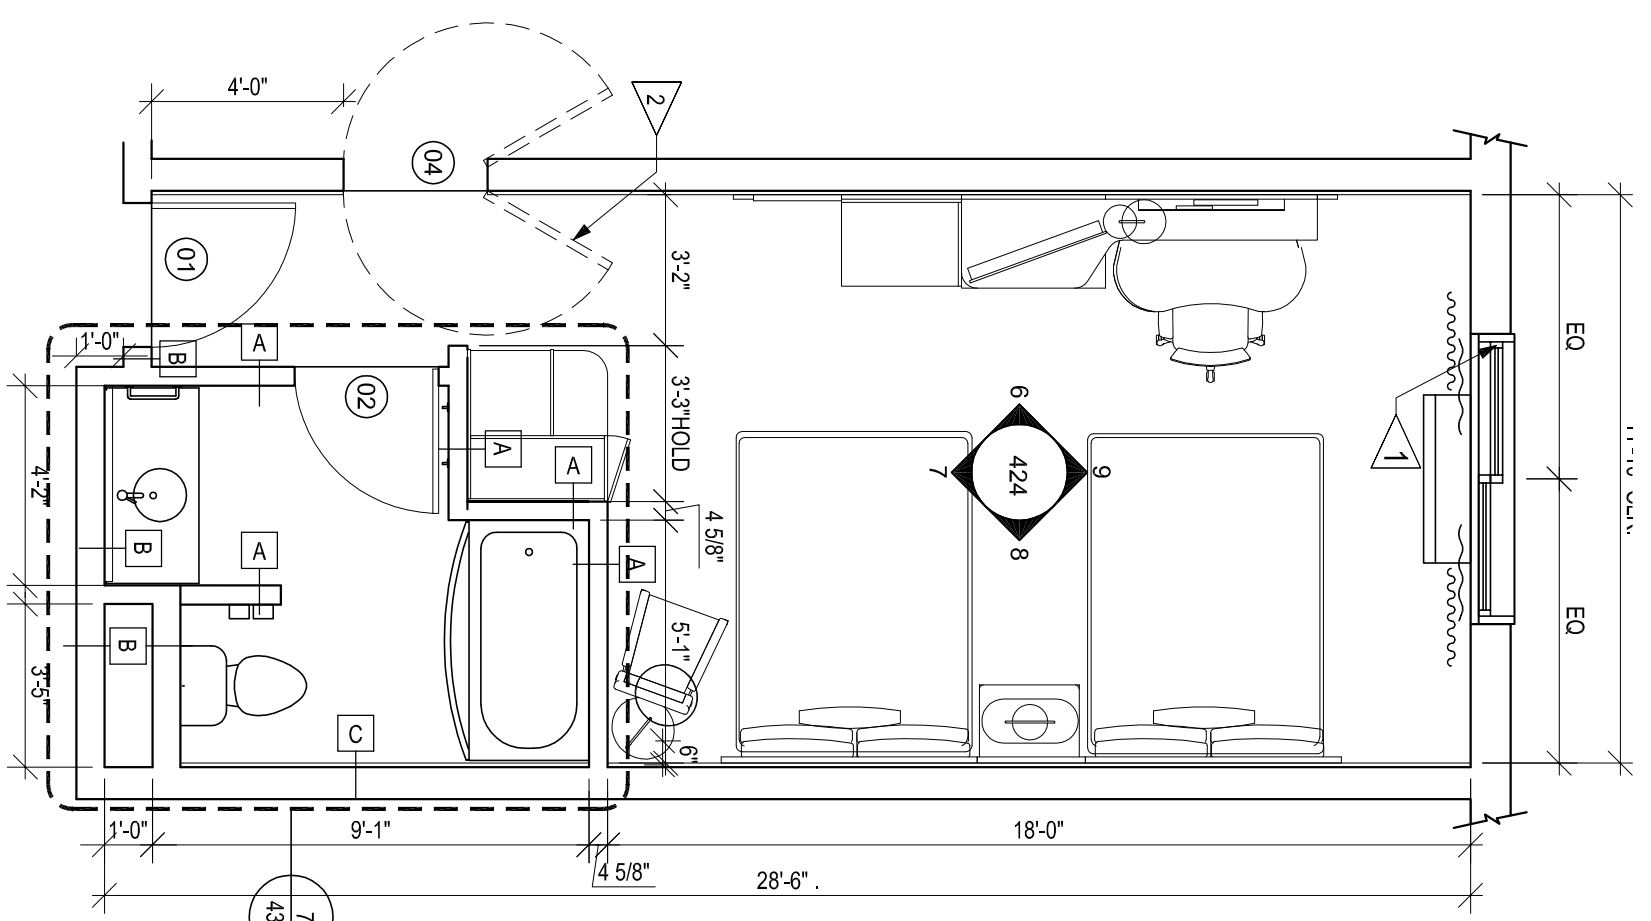


2C PLAN - FURNITURE LEFT  
SCALE 1/4"=1'-0"

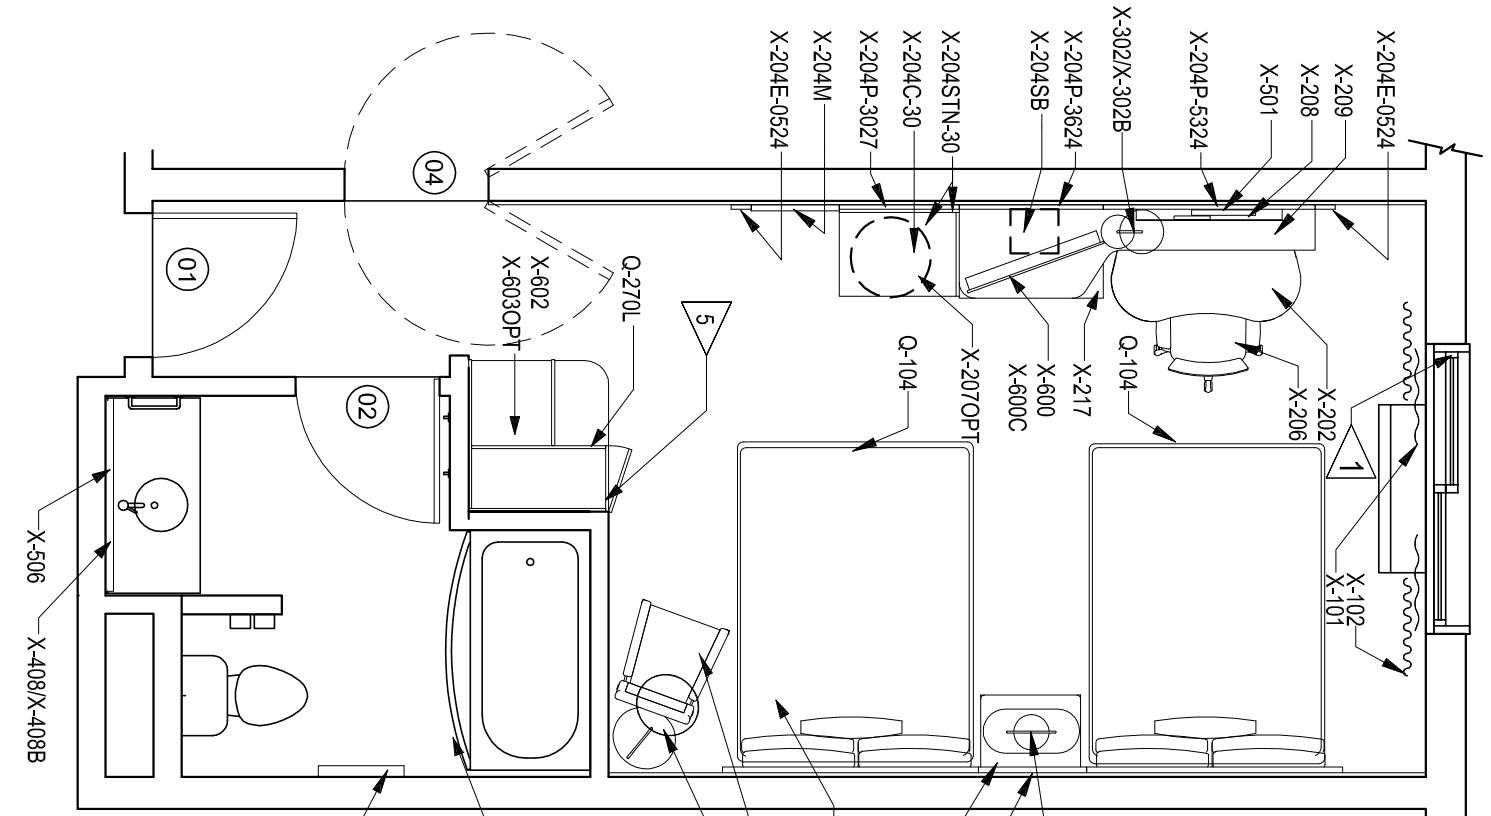


3C PLAN - FURNITURE RIGHT  
SCALE 1/4"=1'-0"

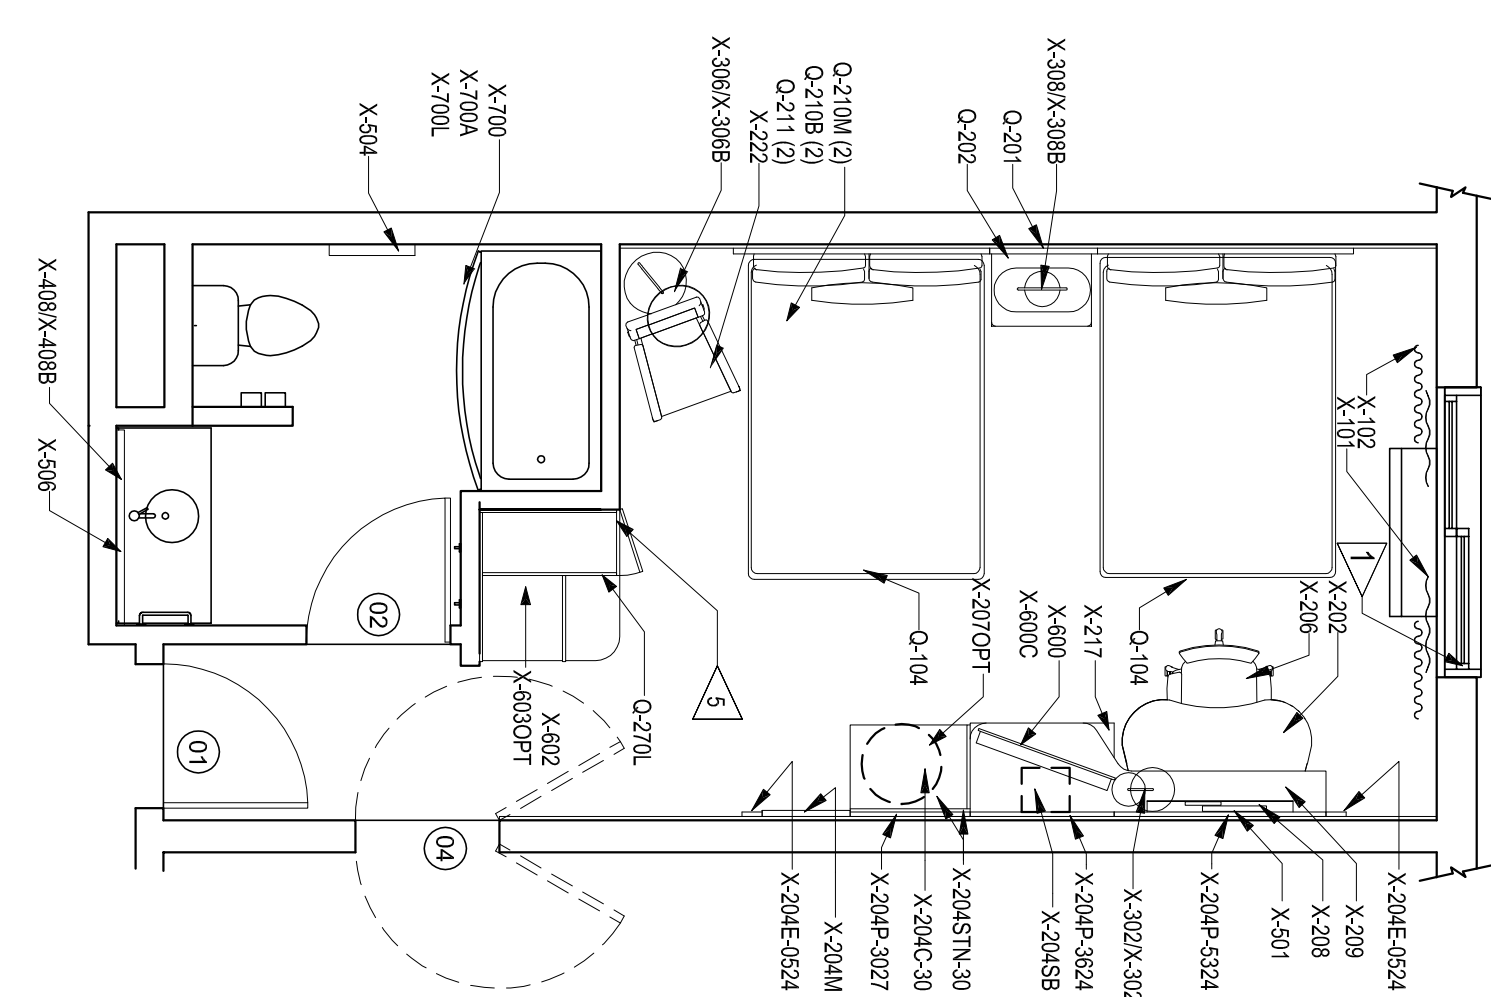


4C REFLECTED CEILING PLAN  
SCALE 1/4"=1'-0"

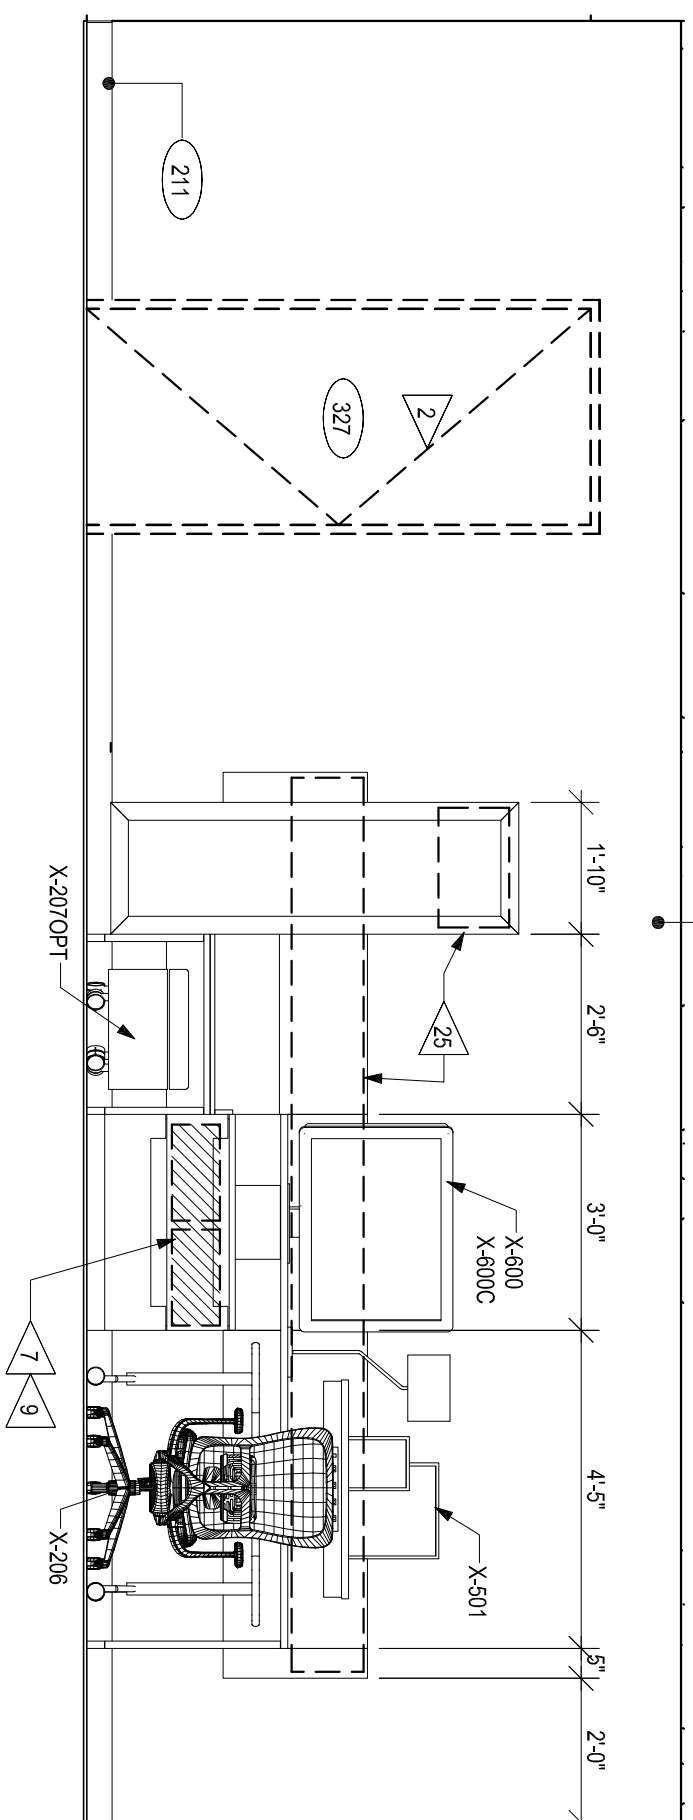


1B INTERIOR ELEVATION  
SCALE 3/8"=1'-0"

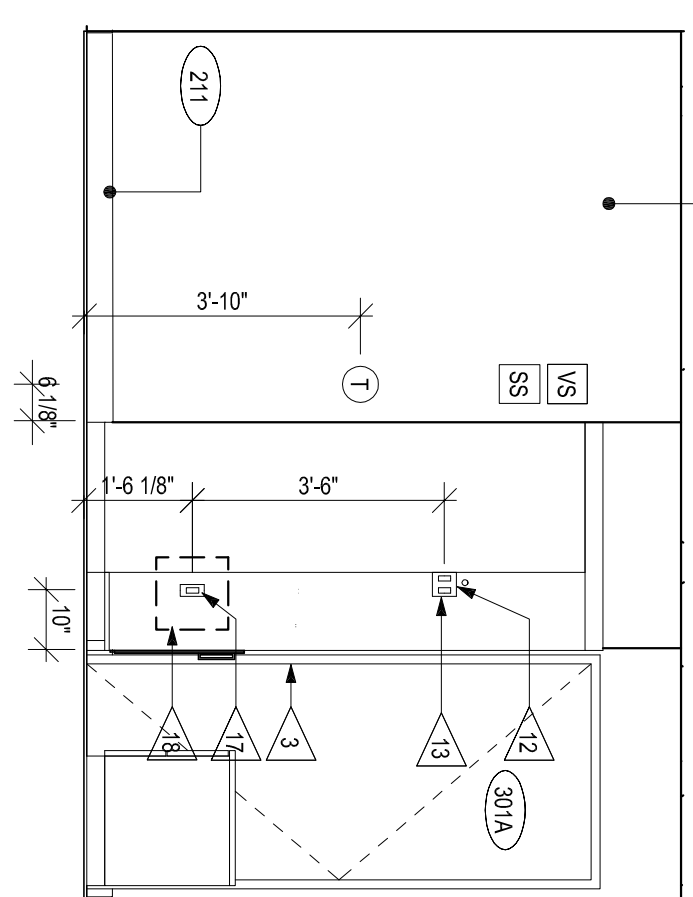

3B INTERIOR ELEVATION  
SCALE 3/8"=1'-0"

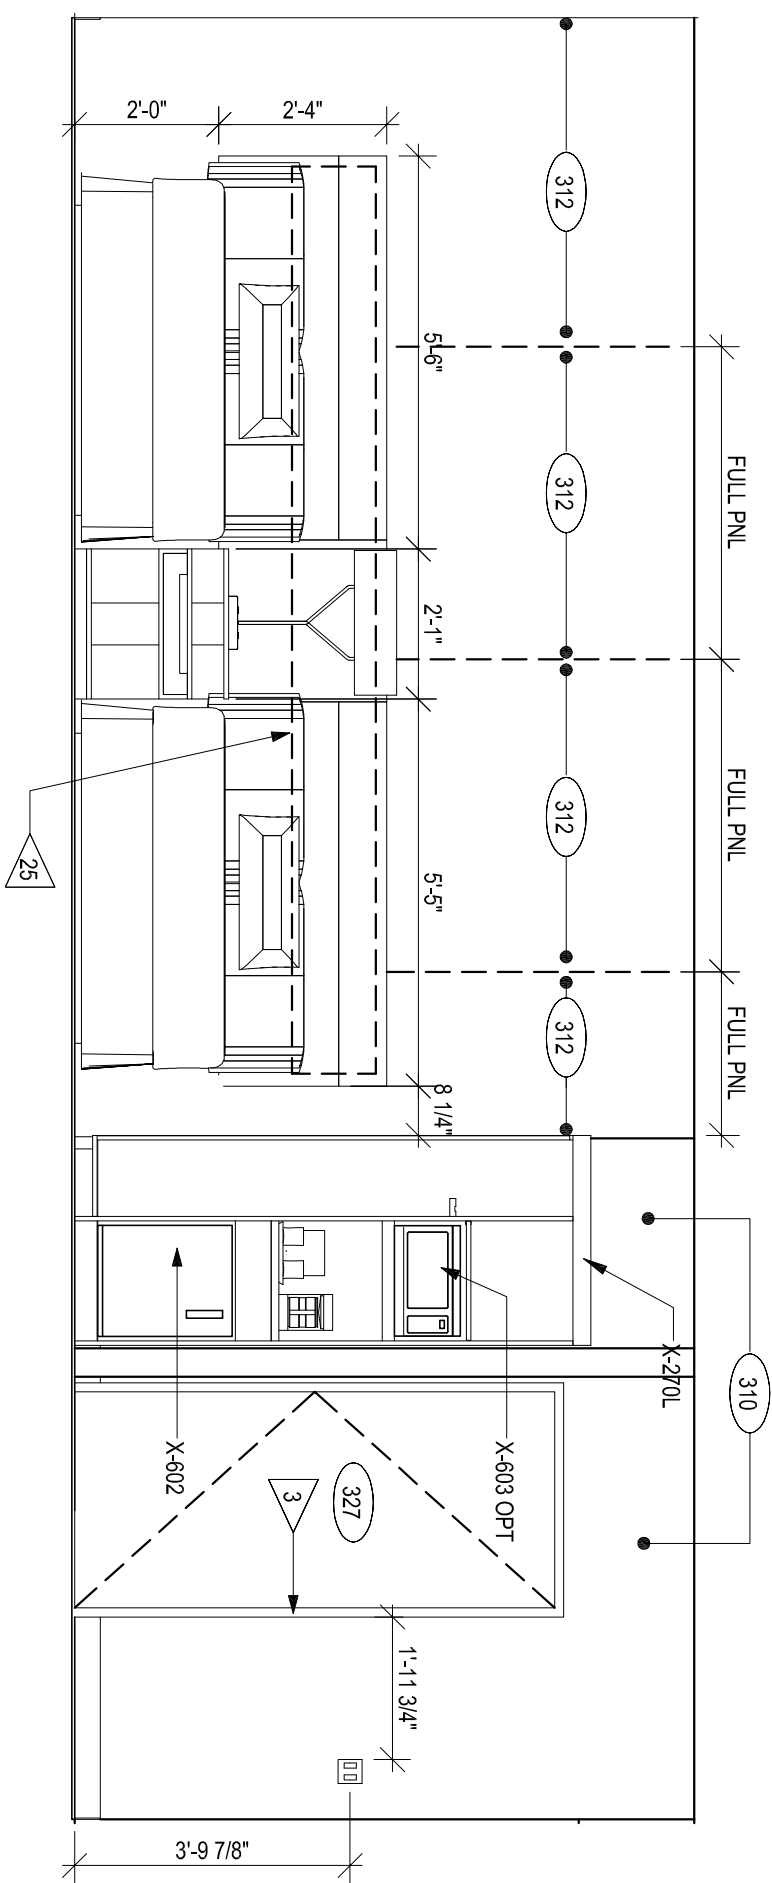

1A INTERIOR ELEVATION  
SCALE 3/8"=1'-0"

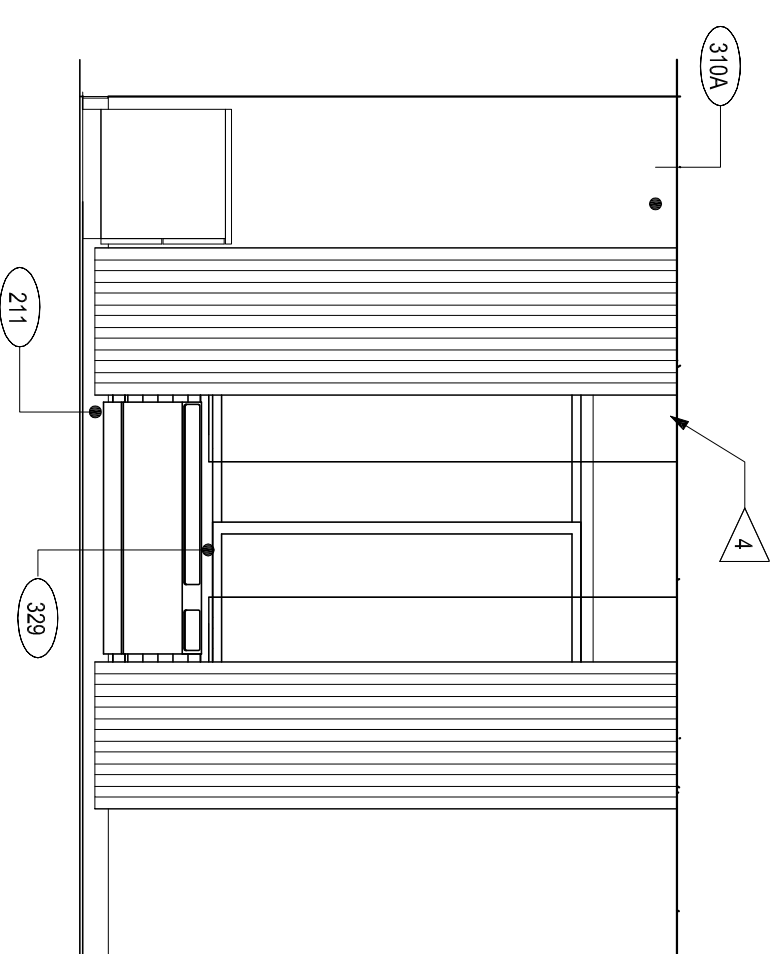

3A INTERIOR ELEVATION  
SCALE 3/8"=1'-0"

100% REVIEW SET  
CONSTRUCTION


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3	12/22/2015	100% REVIEW SET

PROJECT NAME:	
DRAWING NUMBER:	
PROJECT NUMBER: 15180	
DRAWING NAME:	
SHEET NAME:	
QUEEN/QUEEN	
DRAWN BY: NK, BBC	
CHECKED BY: BBC	
DATE: 12-22-15	
SCALE: AS NOTED	
DRAWING NUMBER:	
A502	


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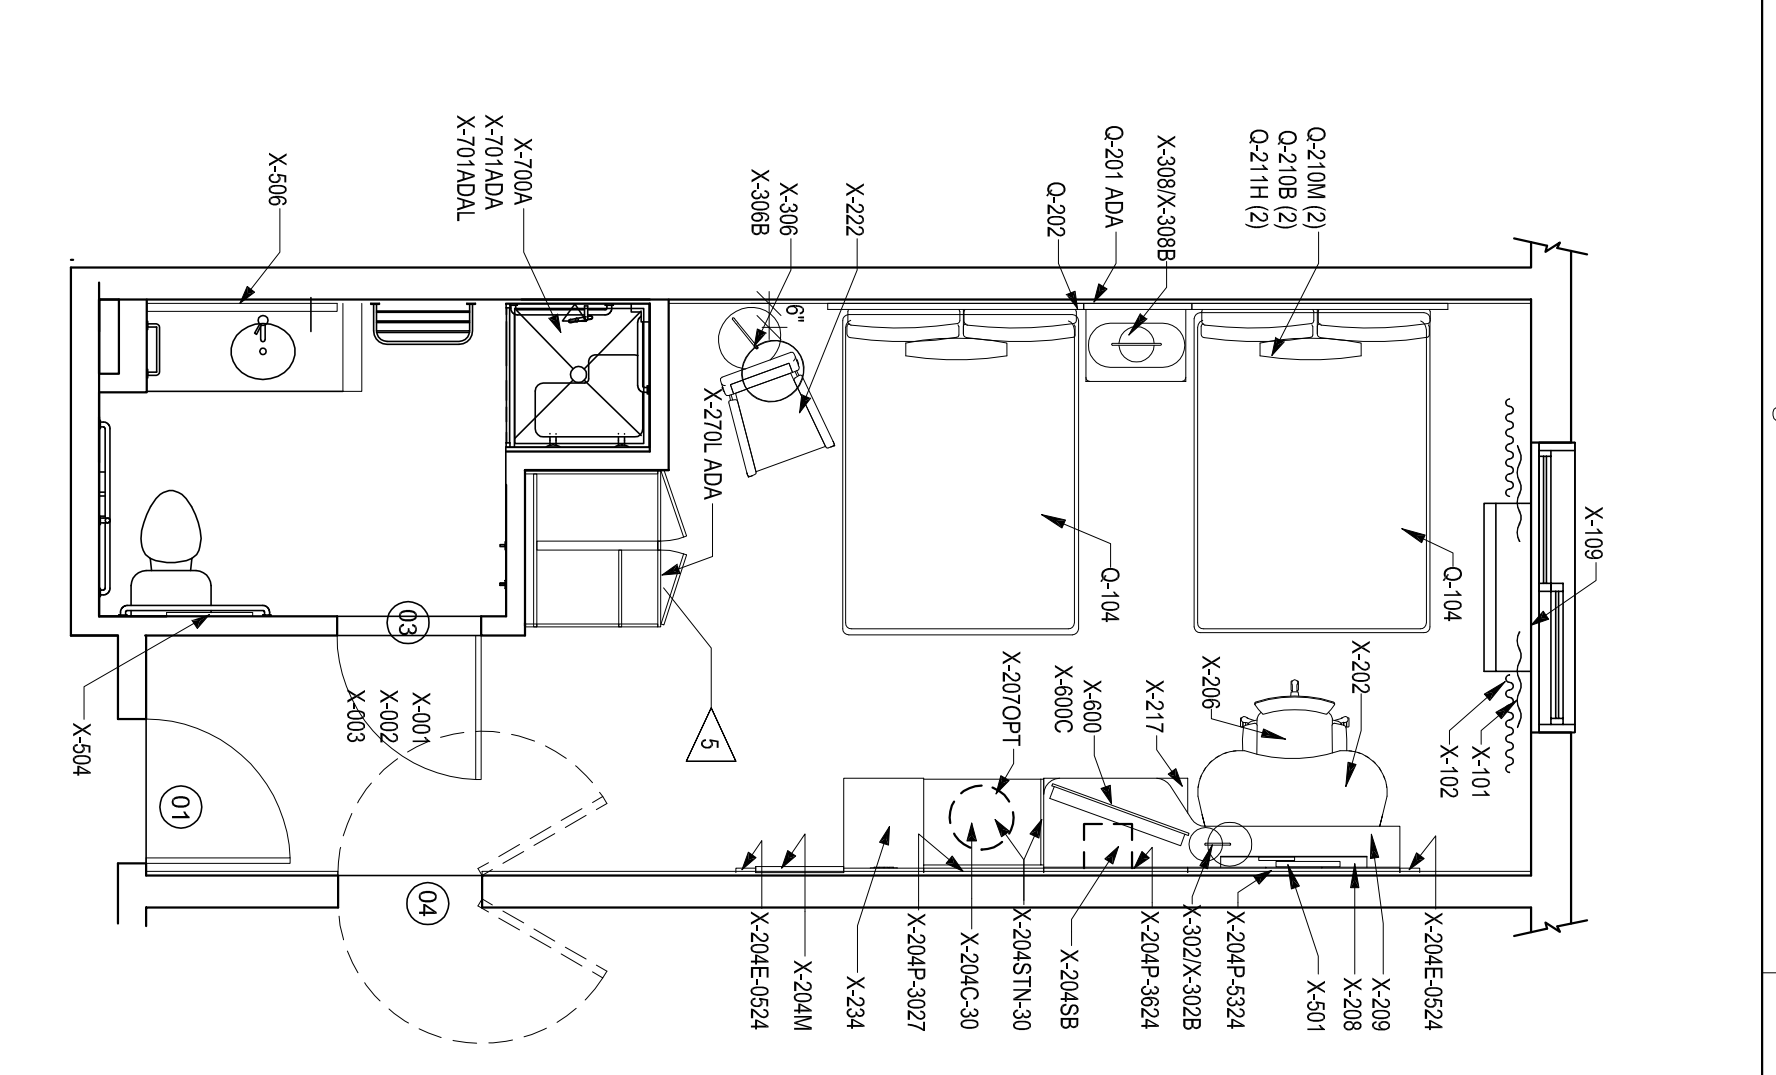
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SUITES  
BY  
MARRIOTT  
290 POWER DRIVE,  
BATESVILLE, MS 38606




1C PLAN - QUEEN QUEEN ADA ROLL IN  
SCALE 1/4"=1'-0"

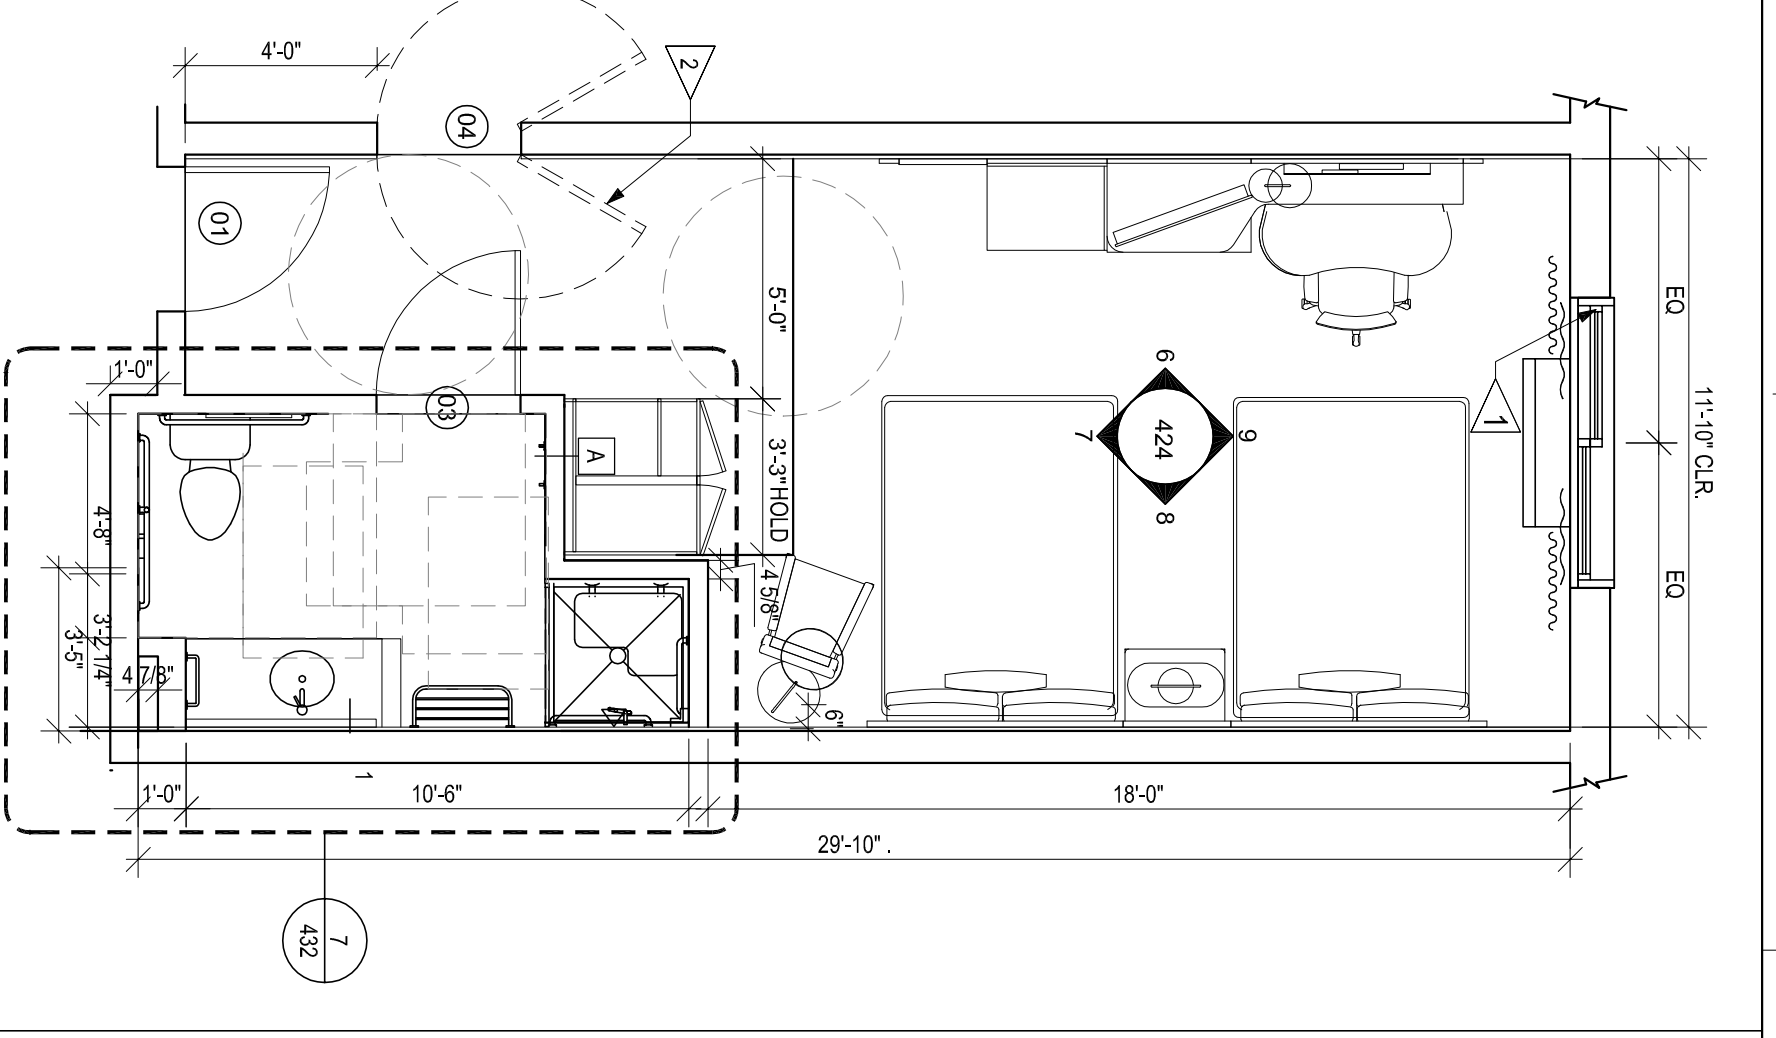


2C PLAN - FURNITURE TRANSFER SHOWER  
SCALE 1/4"=1'-0"

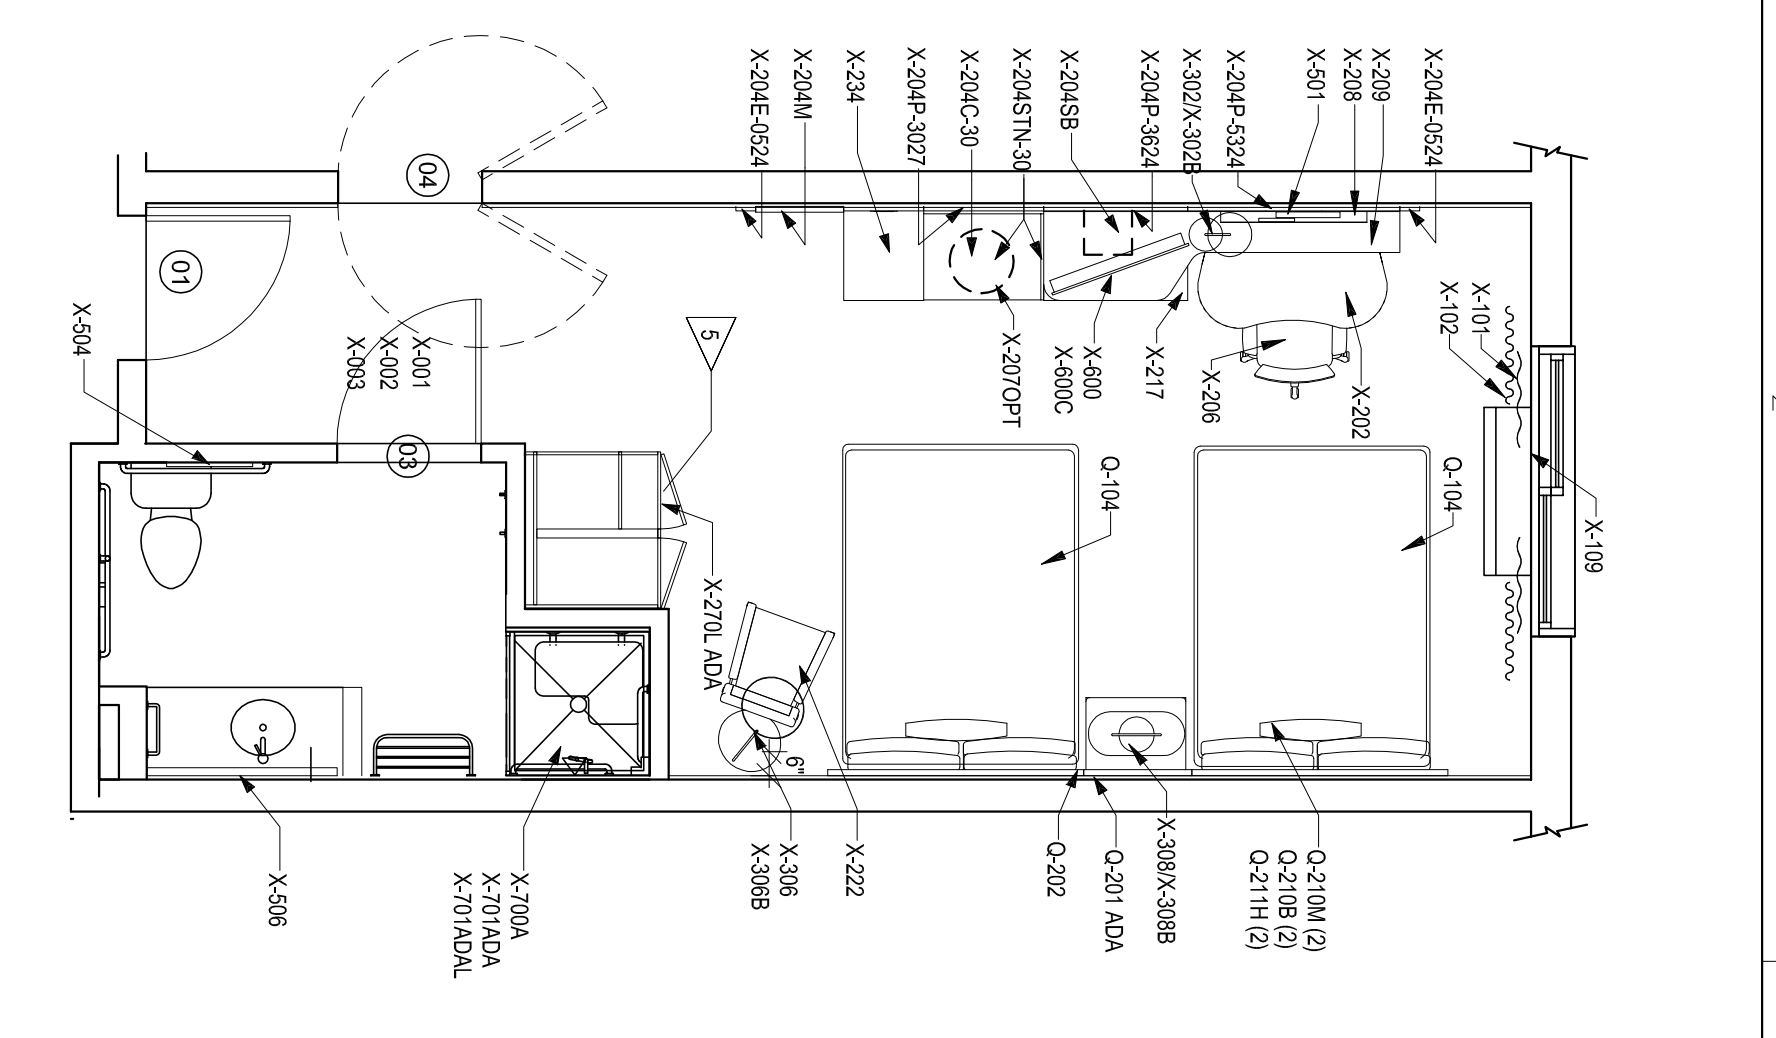


3C PLAN - FURNITURE RIGHT  
SCALE 1/4"=1'-0"

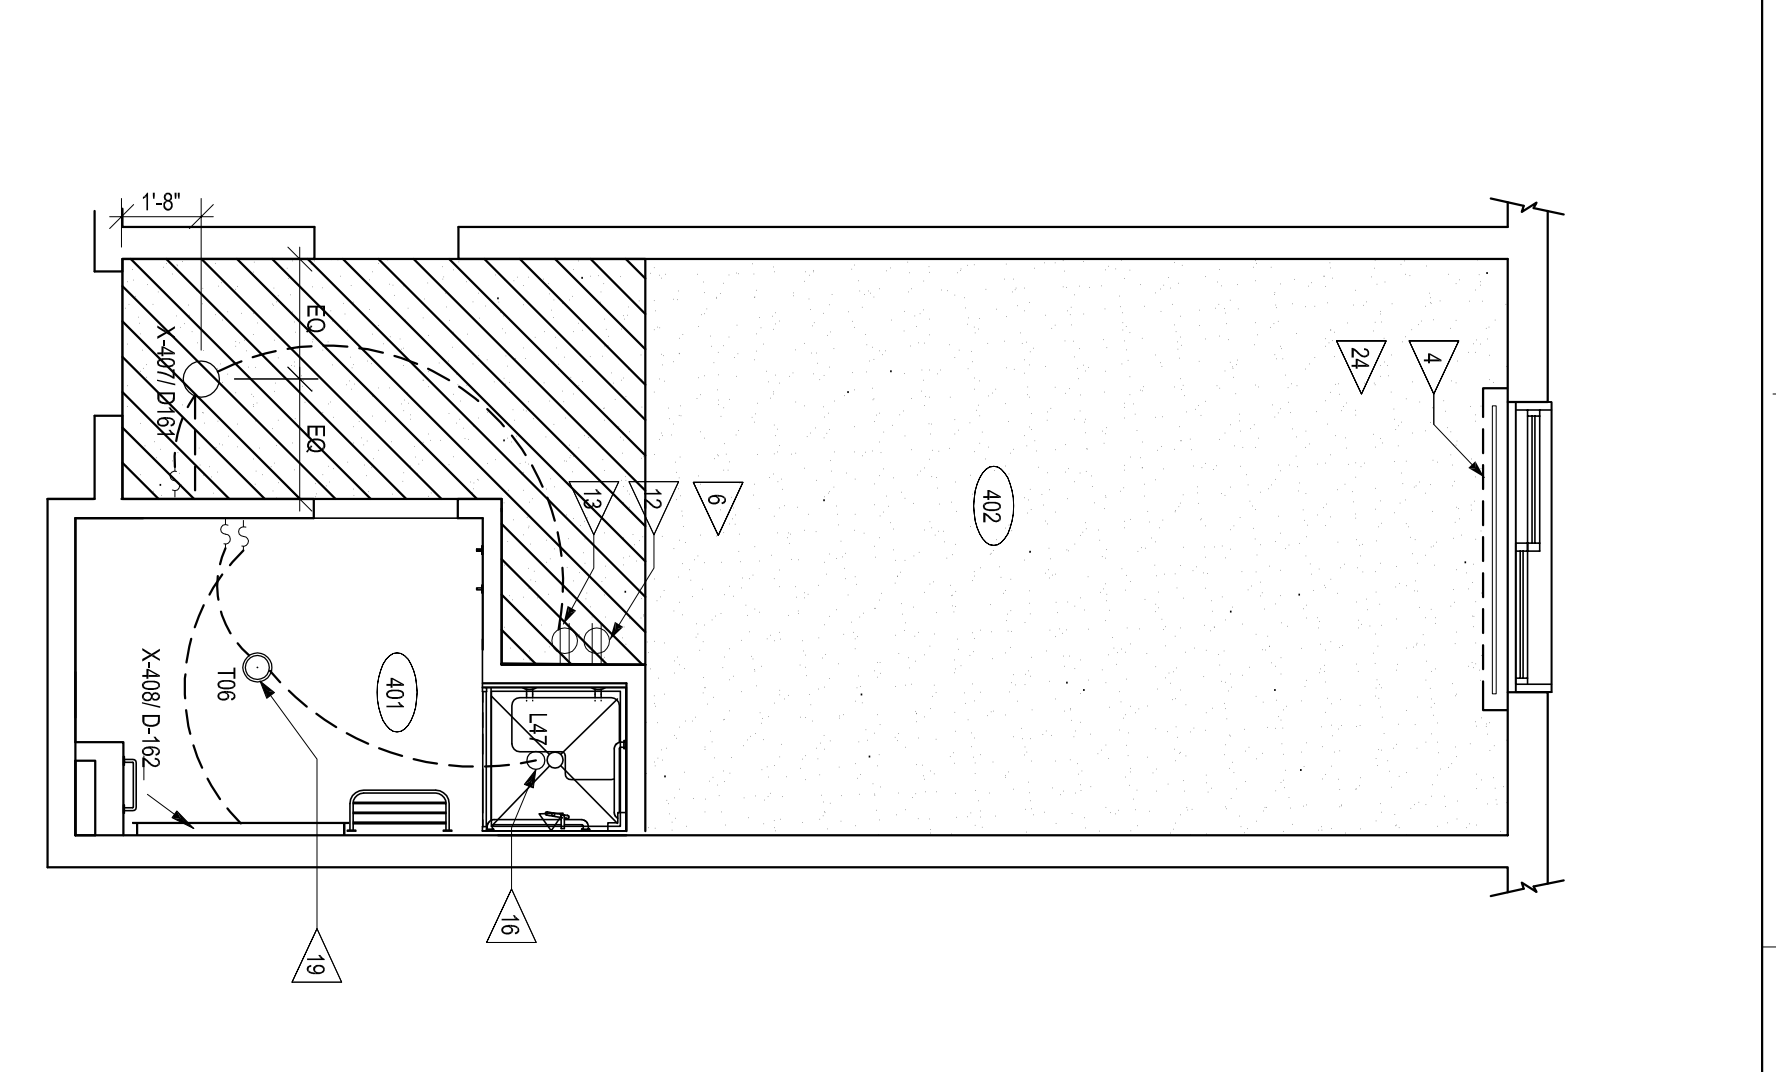


4C REFLECTED CEILING PLAN  
SCALE 1/4"=1'-0"

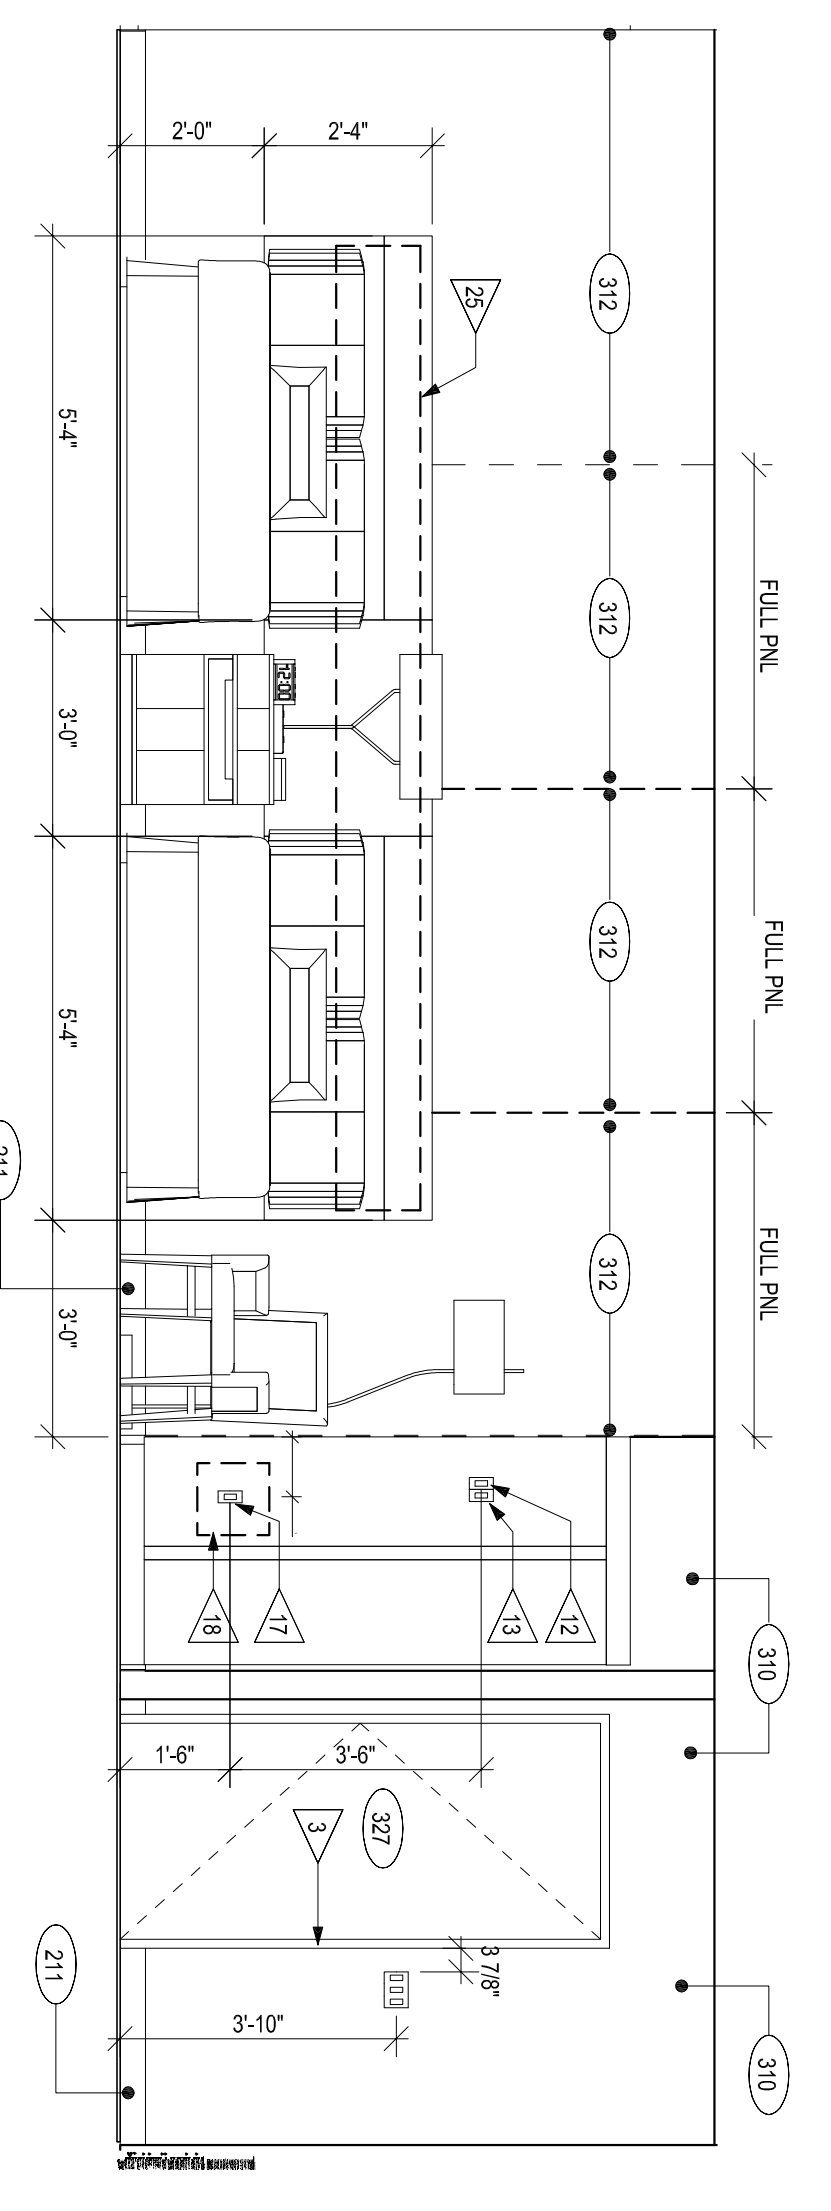


1A INTERIOR ELEVATION  
SCALE 3/8"=1'-0"

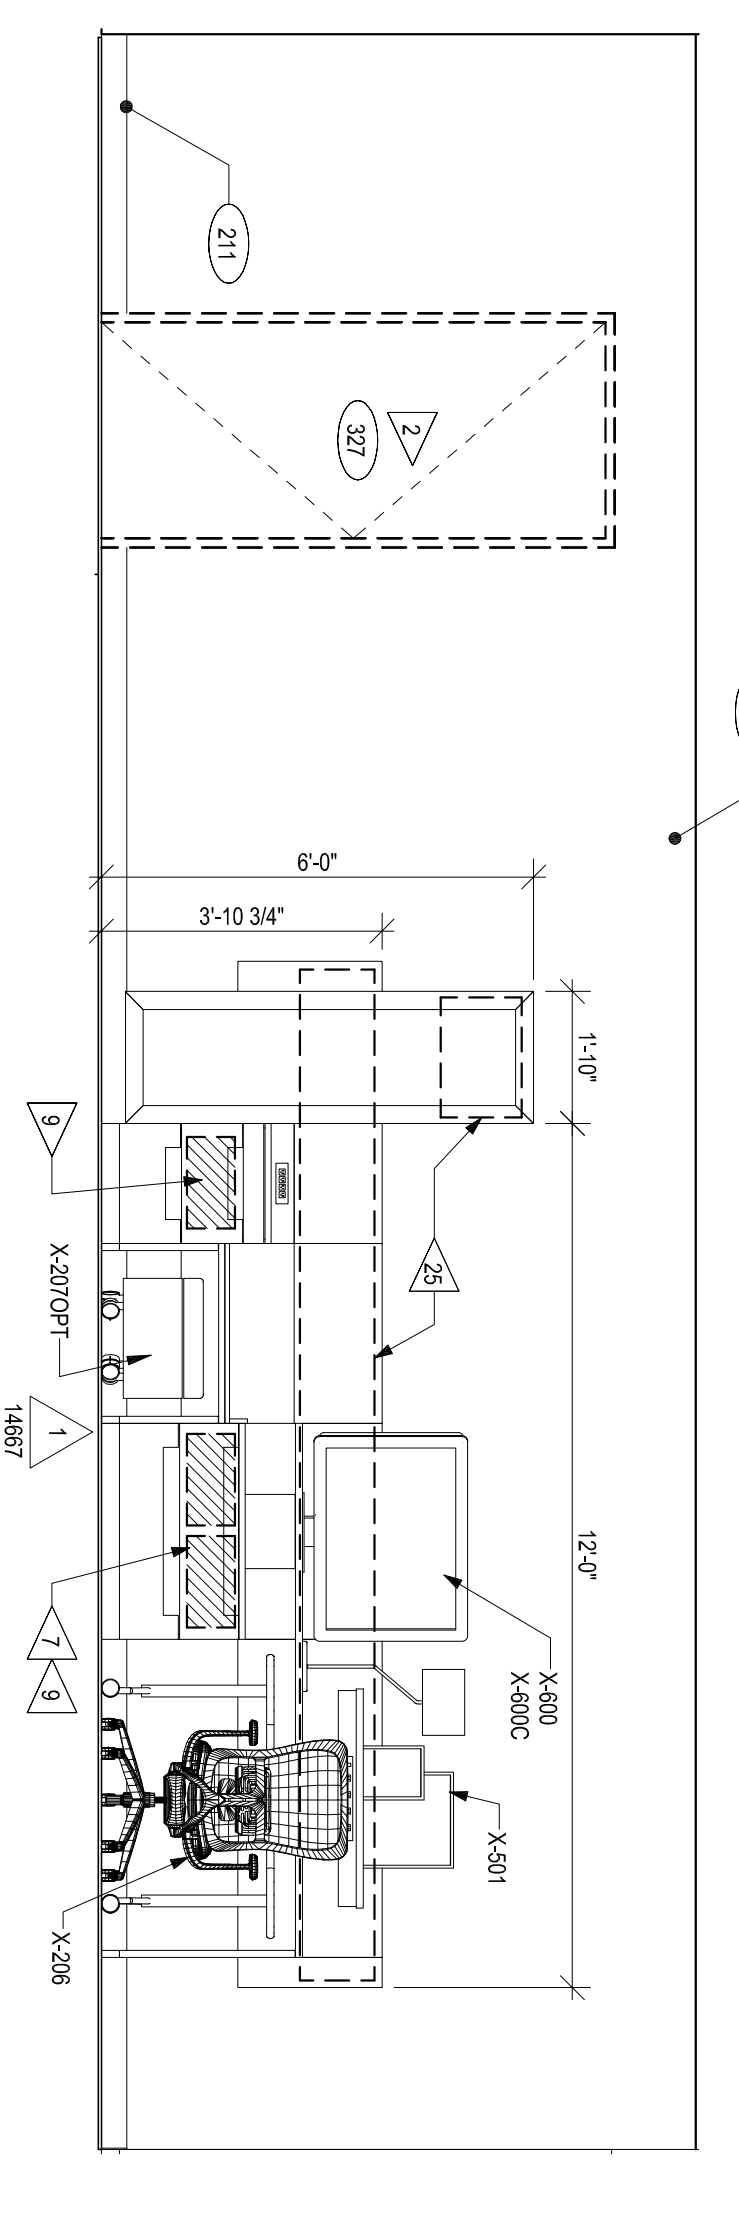

1B INTERIOR ELEVATION  
SCALE 3/8"=1'-0"

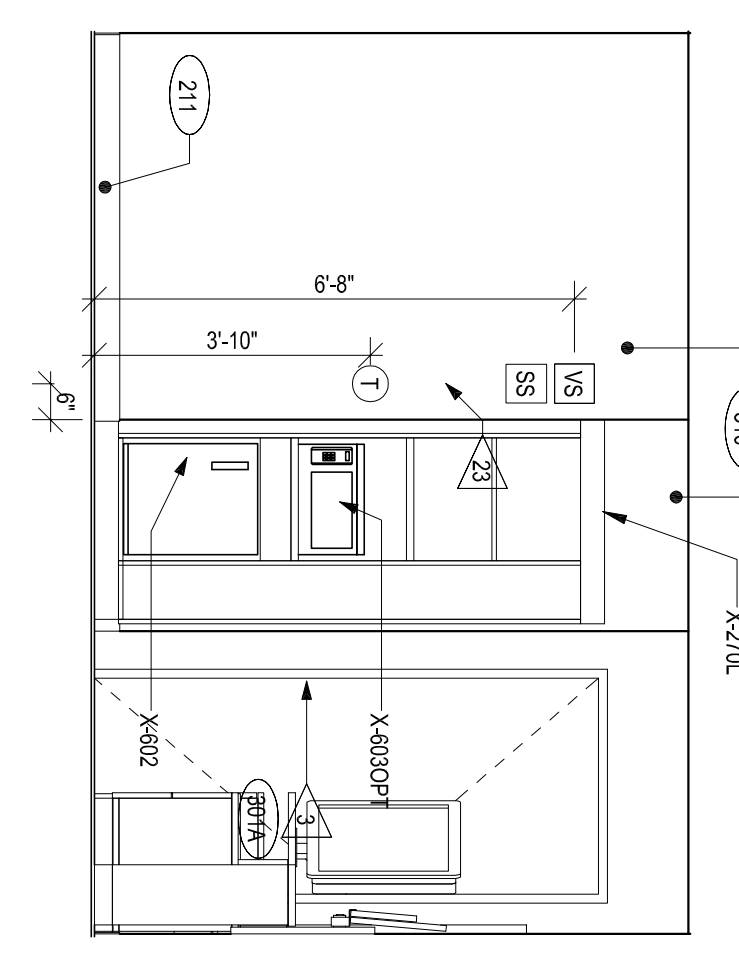

3B INTERIOR ELEVATION  
SCALE 3/8"=1'-0"

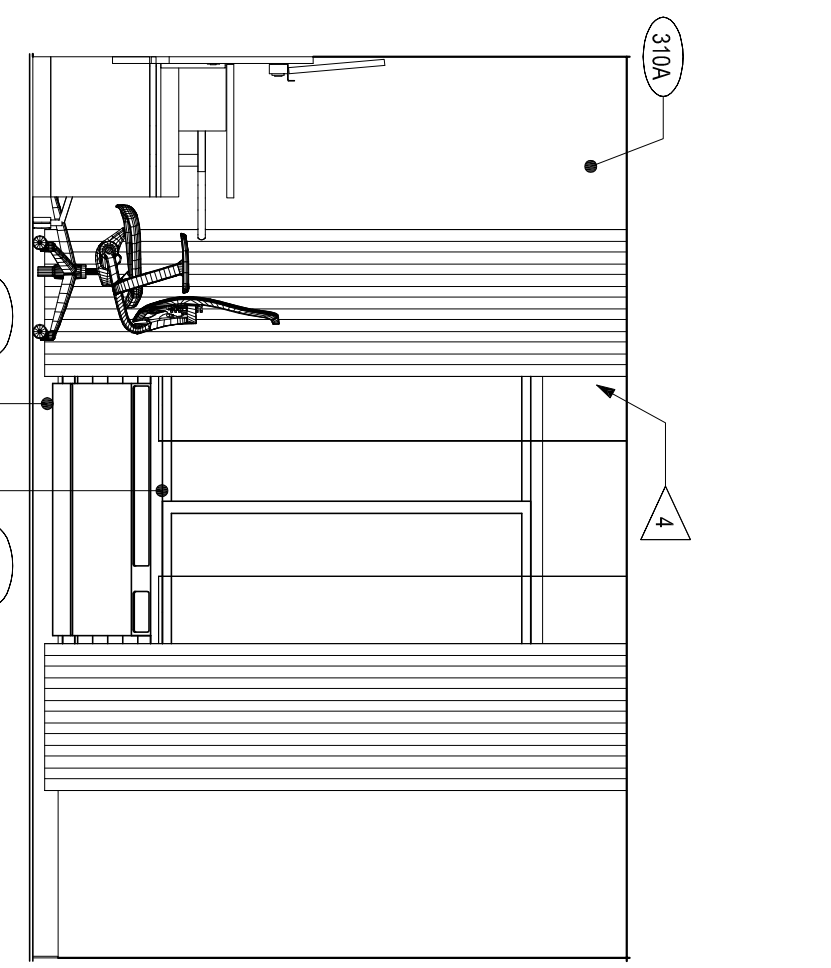

3A INTERIOR ELEVATION  
SCALE 3/8"=1'-0"

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NO.	DATE	DESCRIPTION
1	09/21/2015	30% REVIEW SET
2	11/22/2015	50% REVIEW SET
3	12/22/2015	100% REVIEW SET

PROJECT NAME:  
**QUEEN QUEEN ADA**

DRAWN BY: **BBC**  
CHECKED BY: **BBC**  
DATE: **12-22-15**  
SCALE: **AS NOTED**


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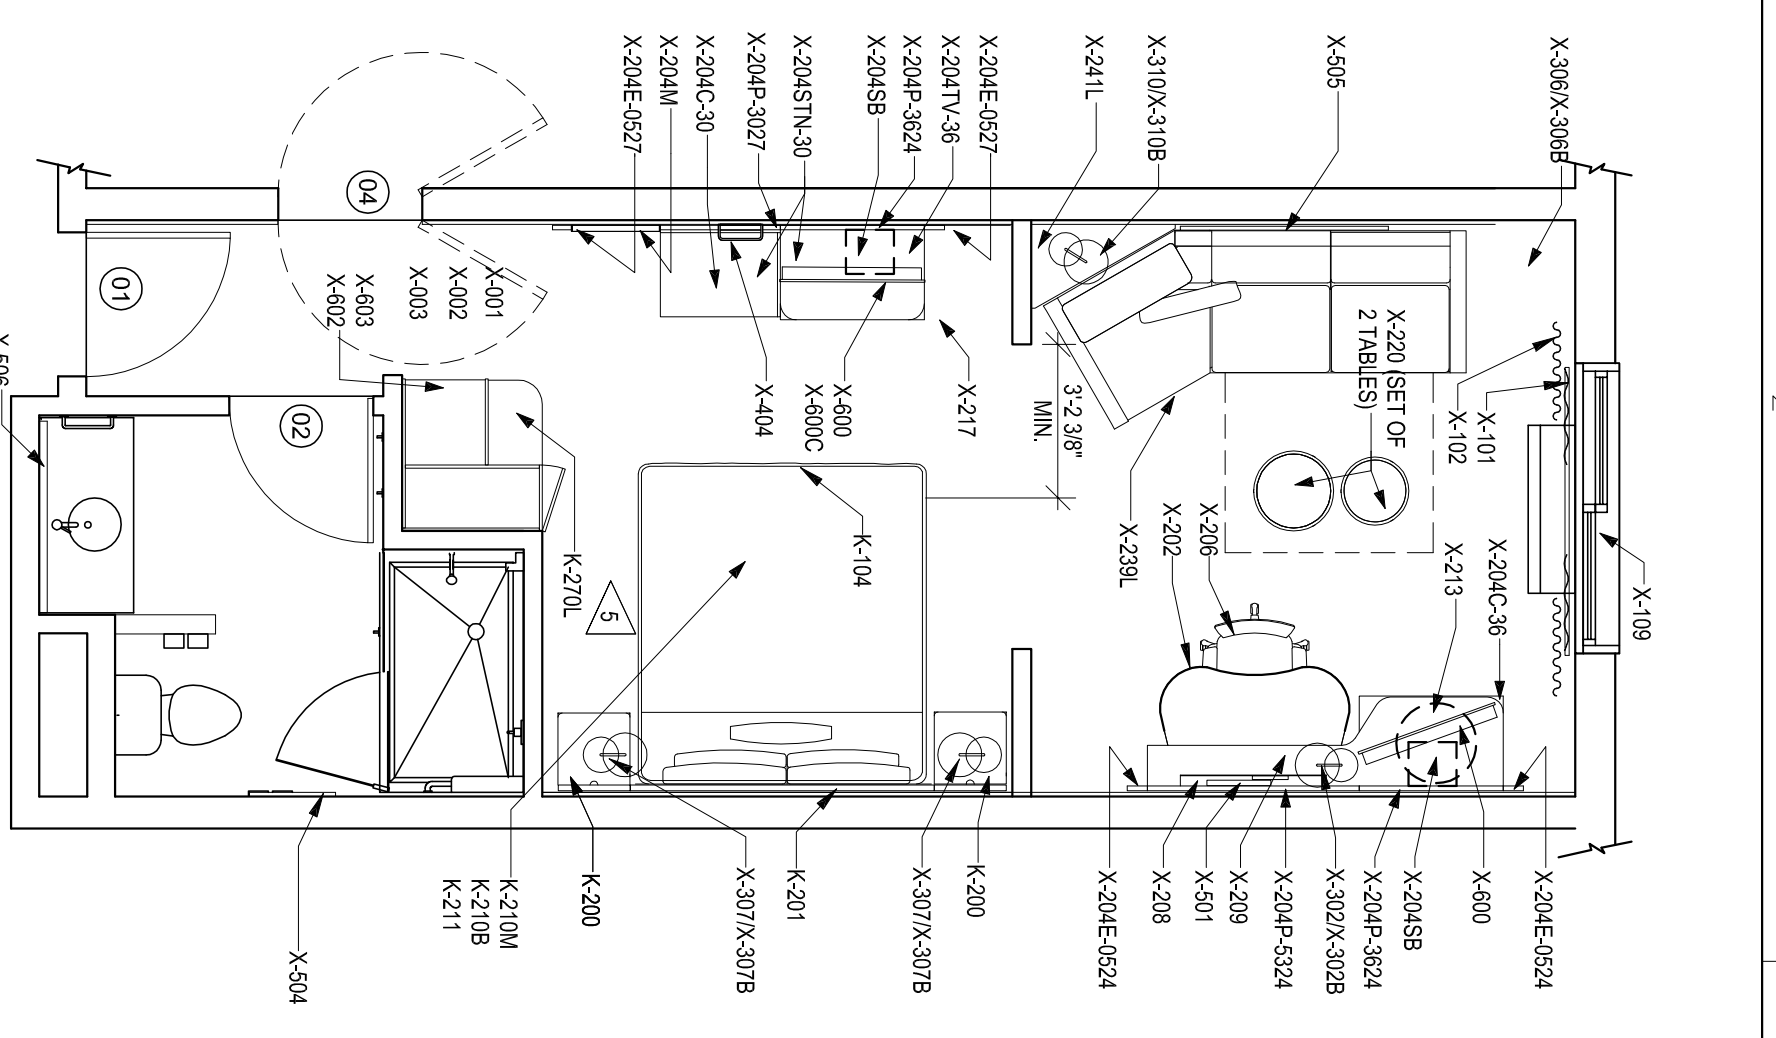
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MEMPHIS, TN 38134  
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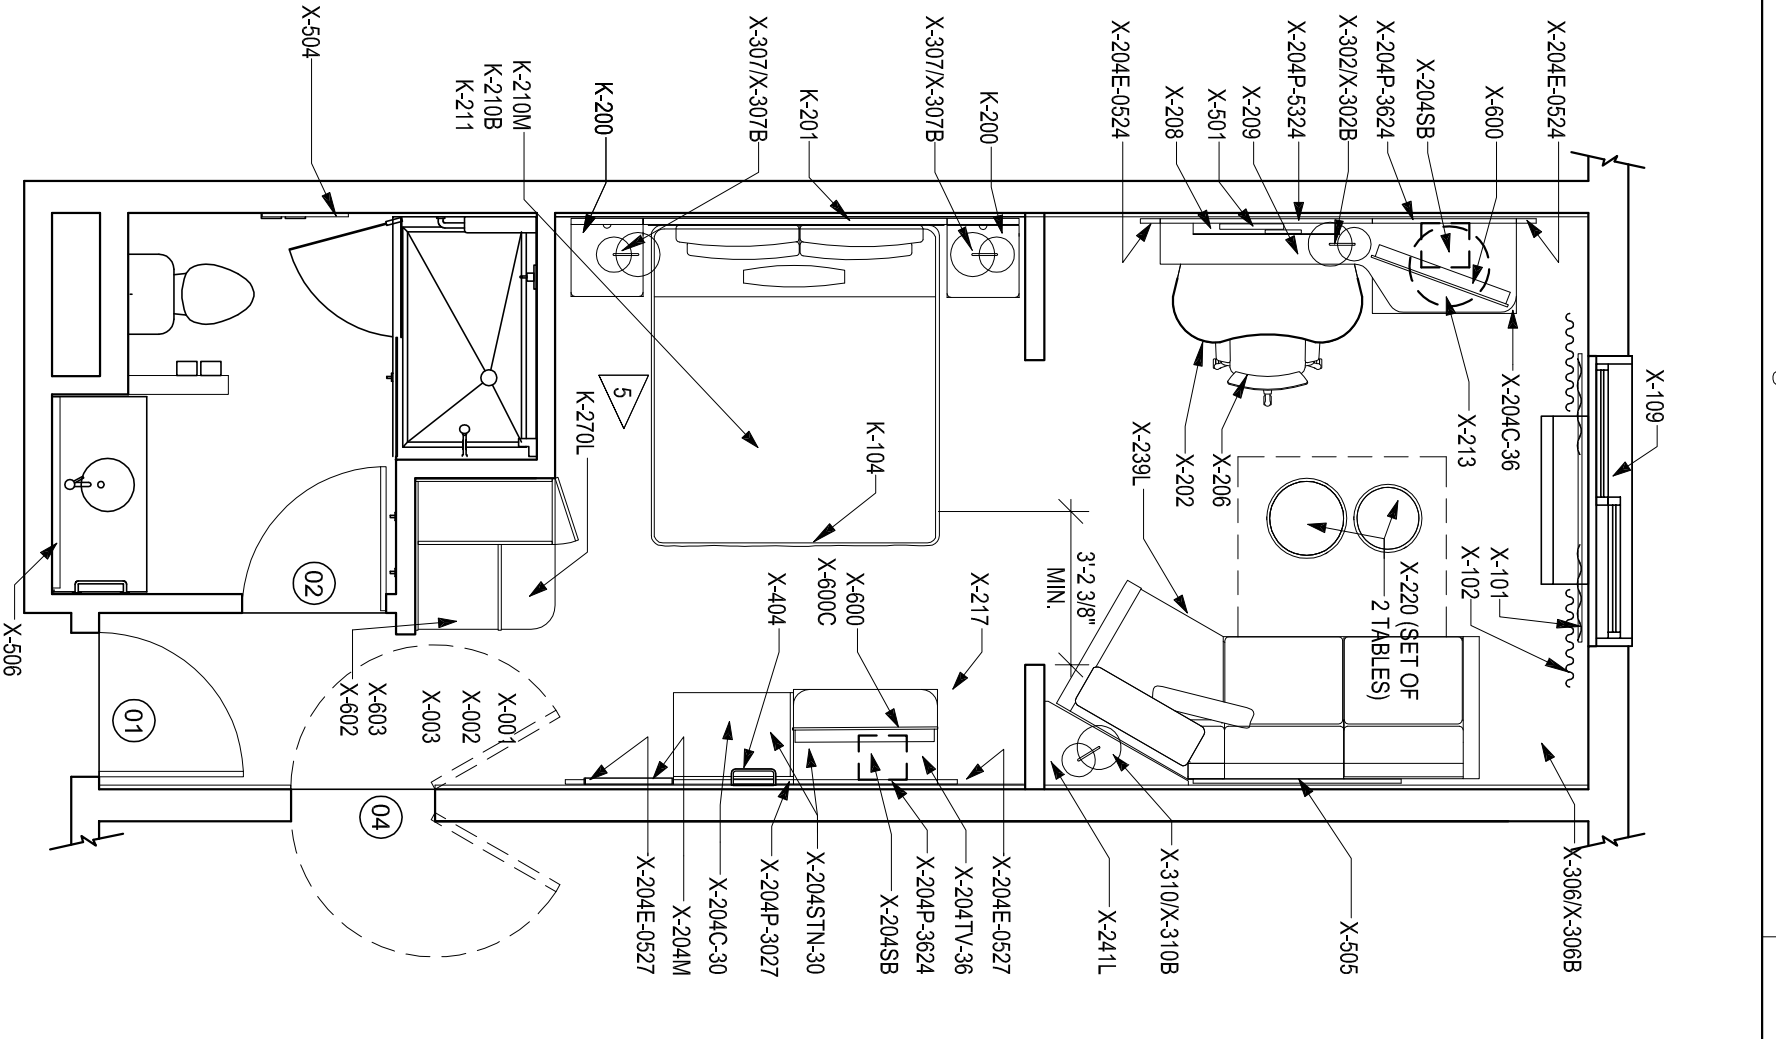
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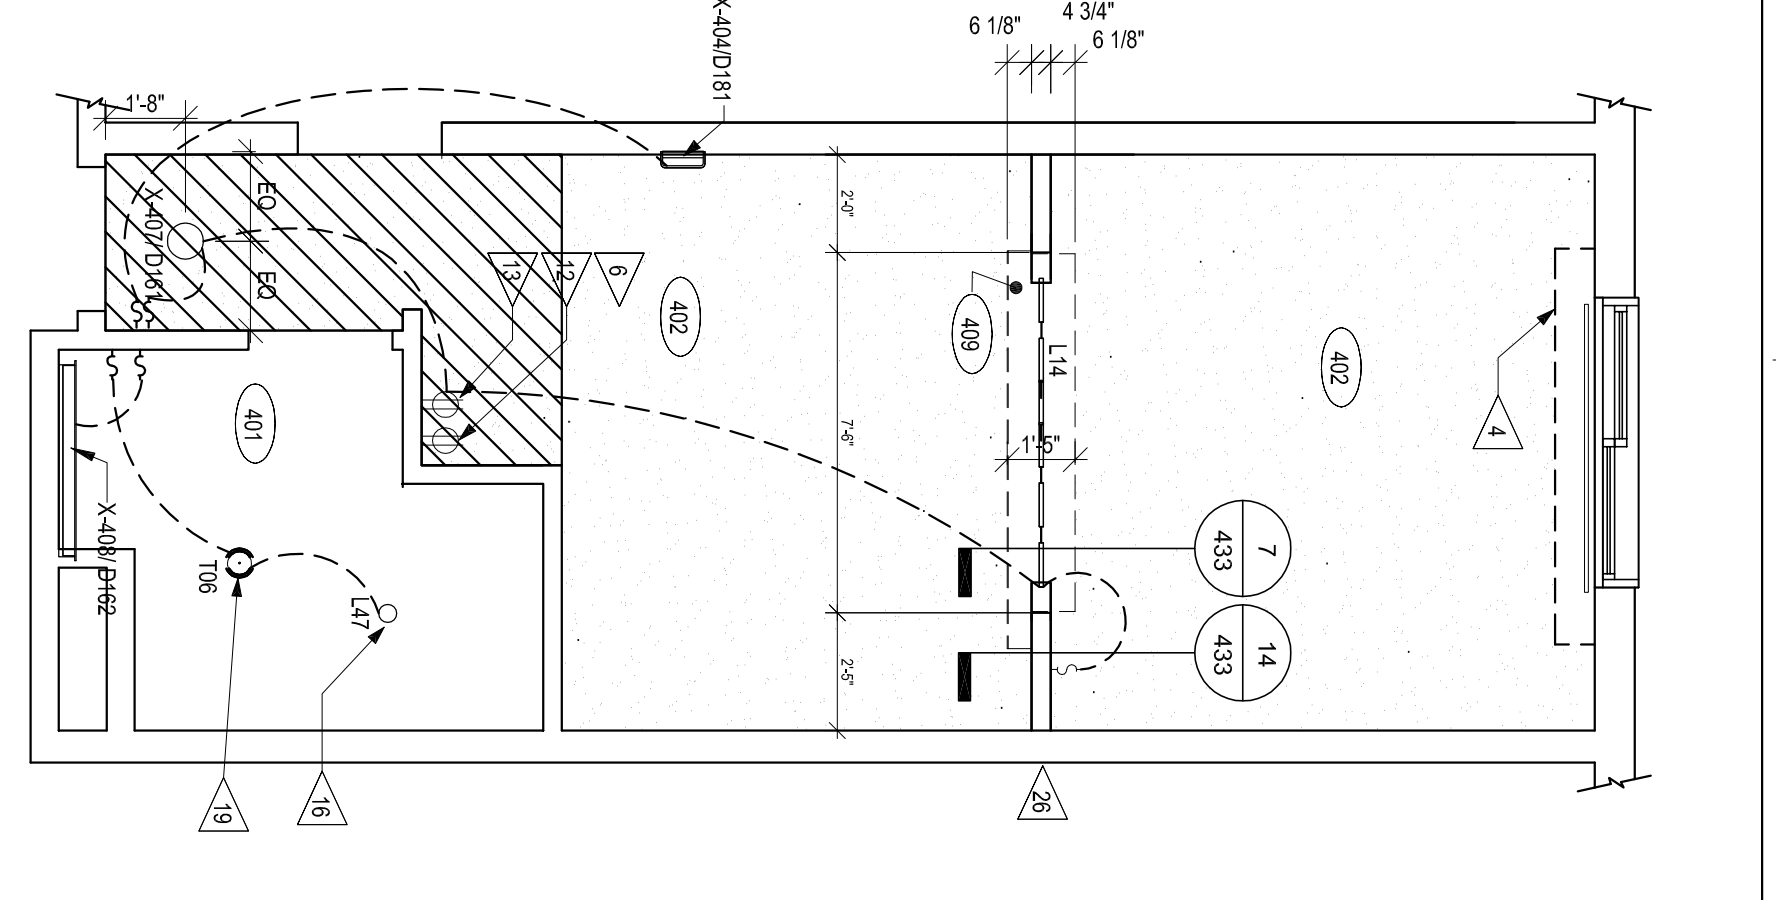
1C PLAN - KING SUITE  
SCALE 1/4"=1'-0"




2C PLAN - FURNITURE LEFT  
SCALE 1/4"=1'-0"




3C PLAN - FURNITURE RIGHT  
SCALE 1/4"=1'-0"

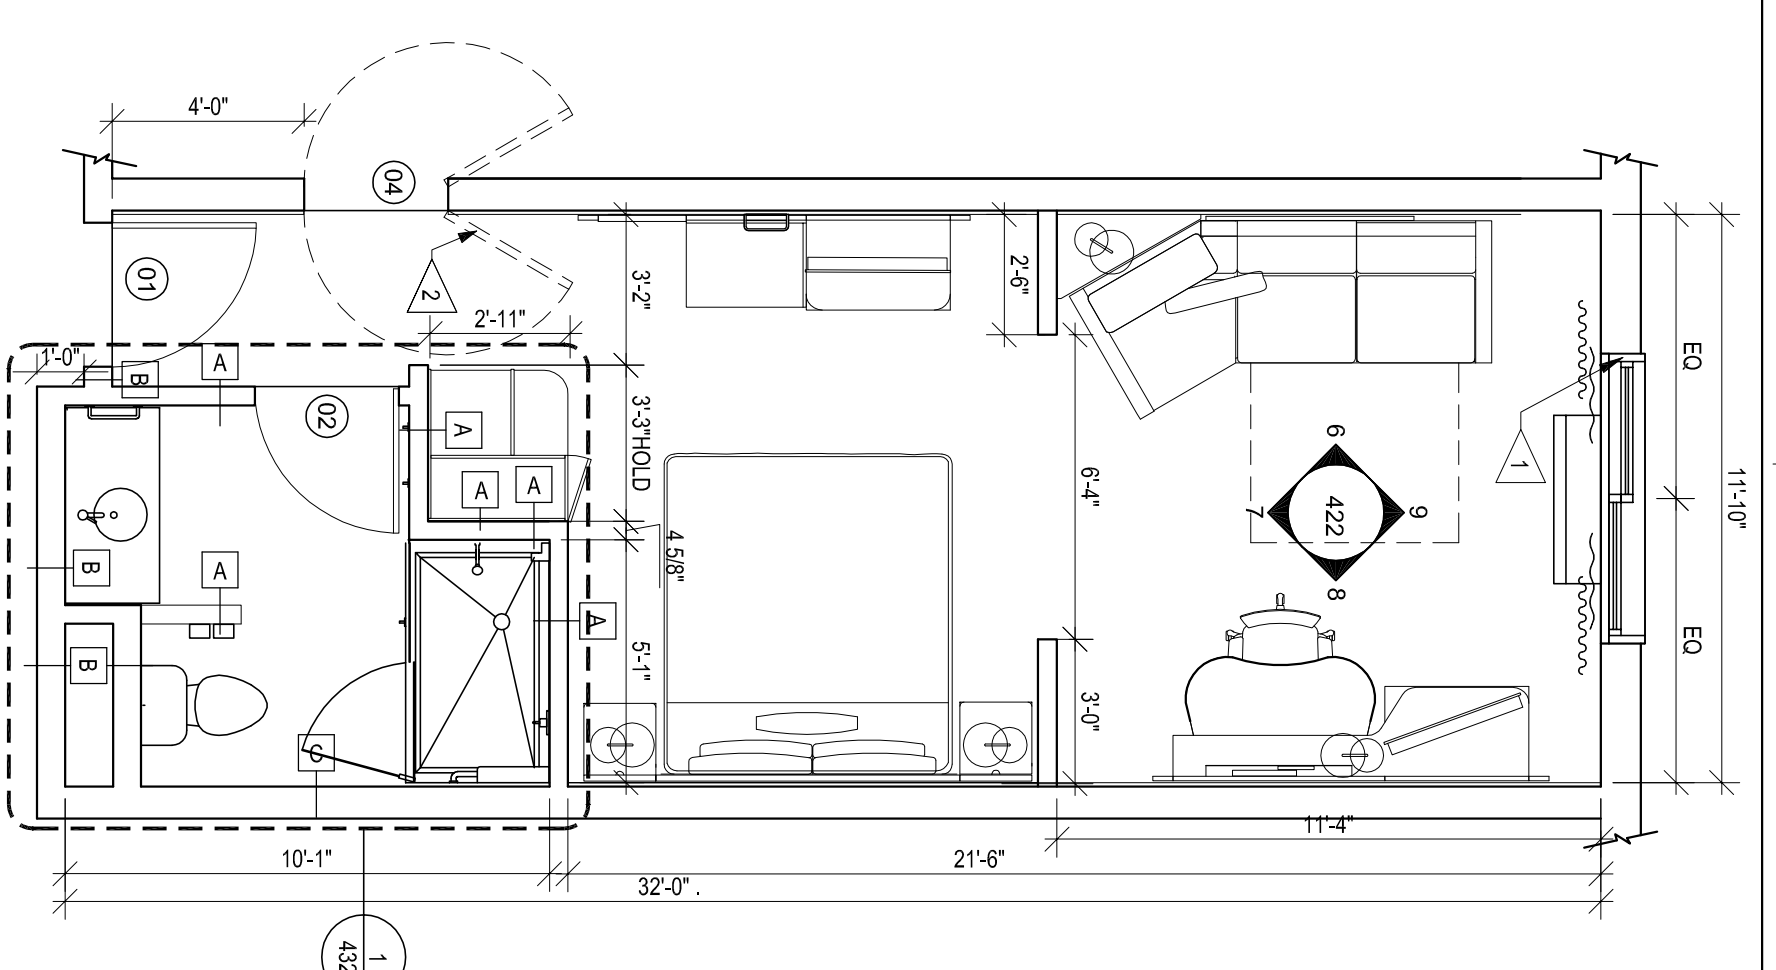


4C REFLECTED CEILING PLAN  
SCALE 1/4"=1'-0"

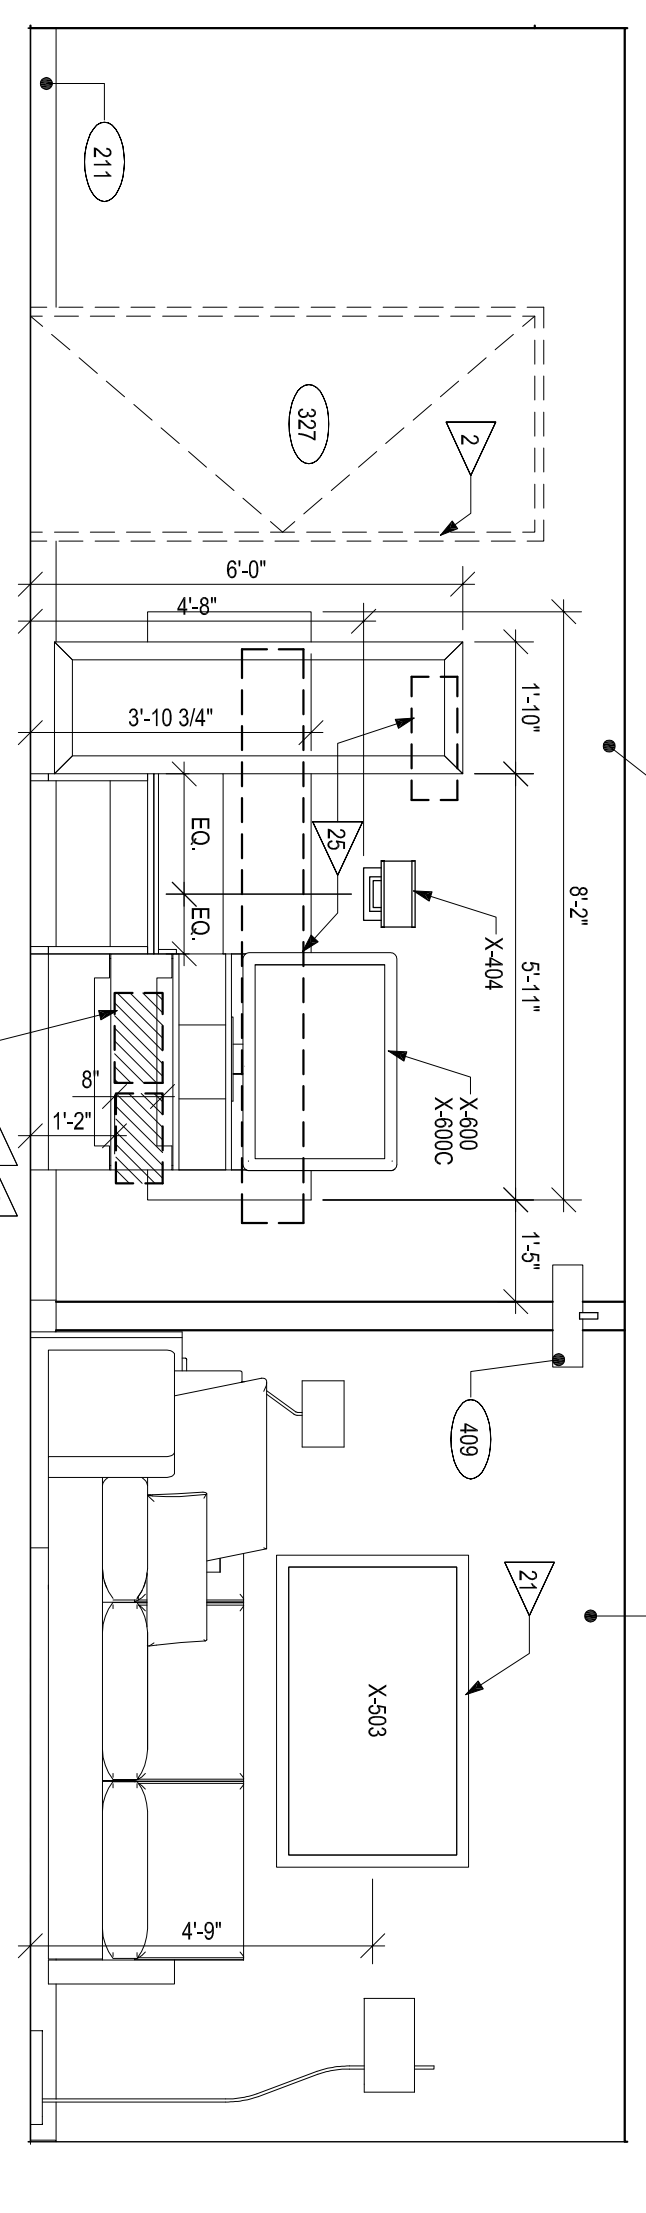


1B INTERIOR ELEVATION  
SCALE 3/8"=1'-0"

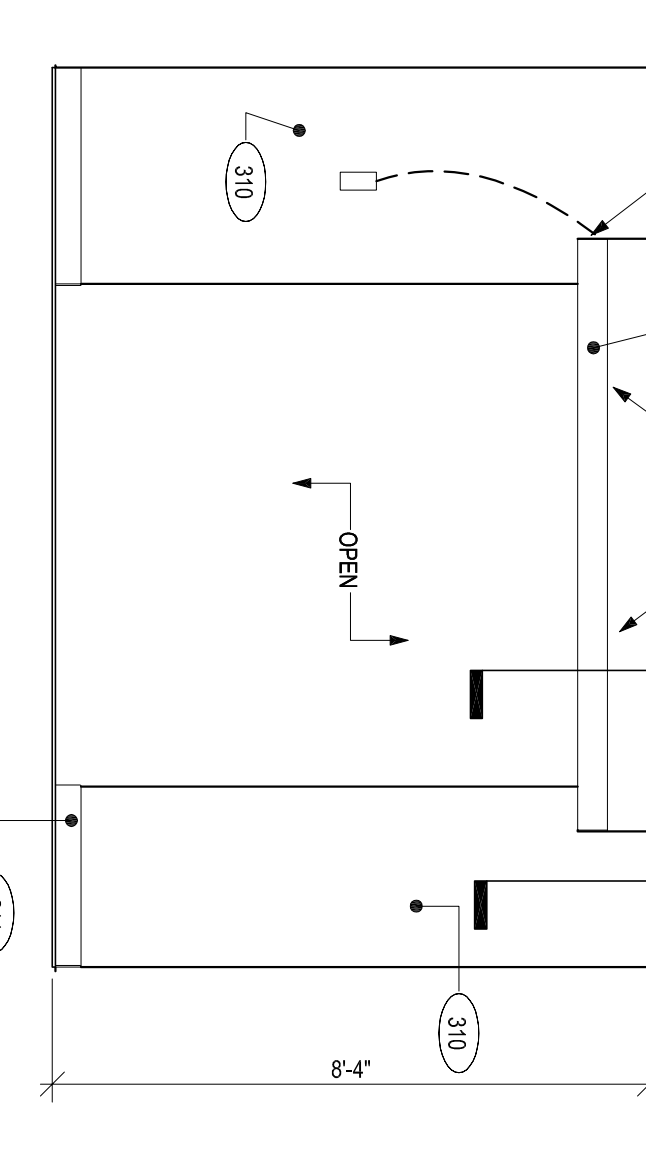

3B INTERIOR ELEVATION  
SCALE 3/8"=1'-0"

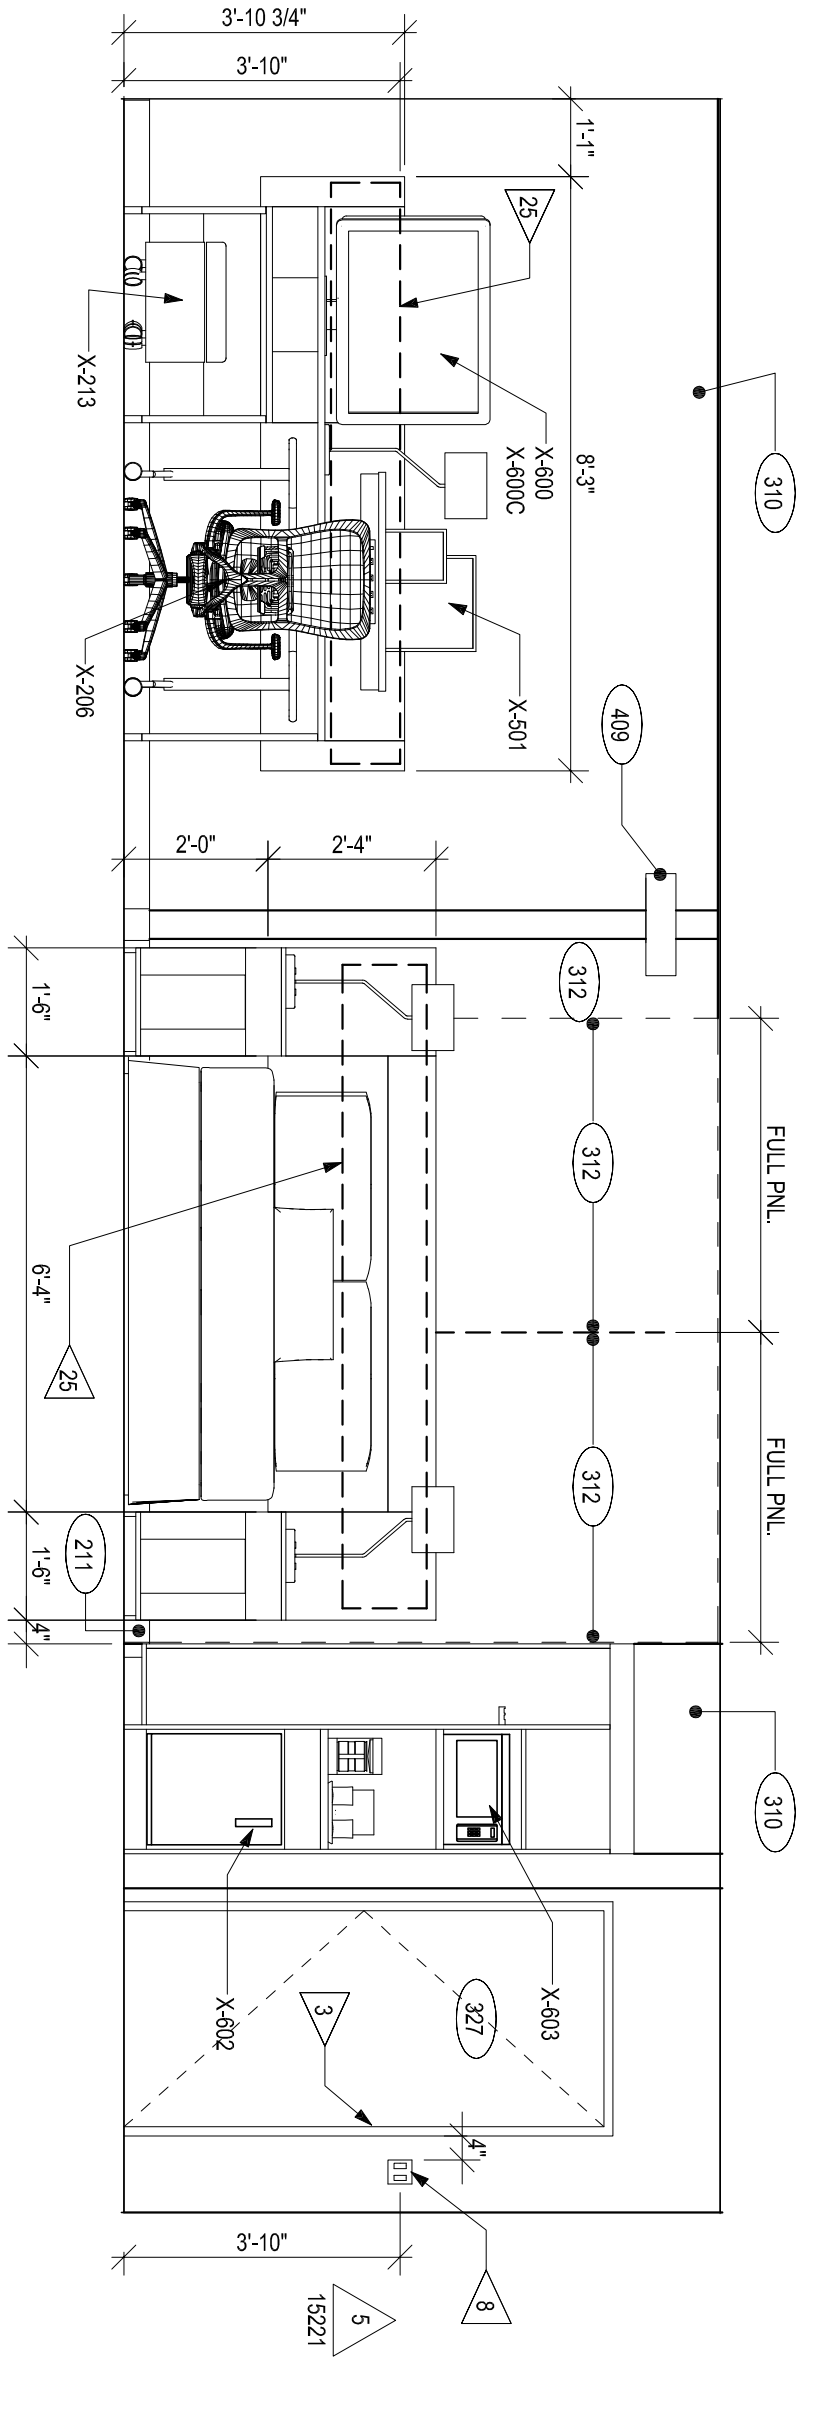

1A INTERIOR ELEVATION  
SCALE 3/8"=1'-0"

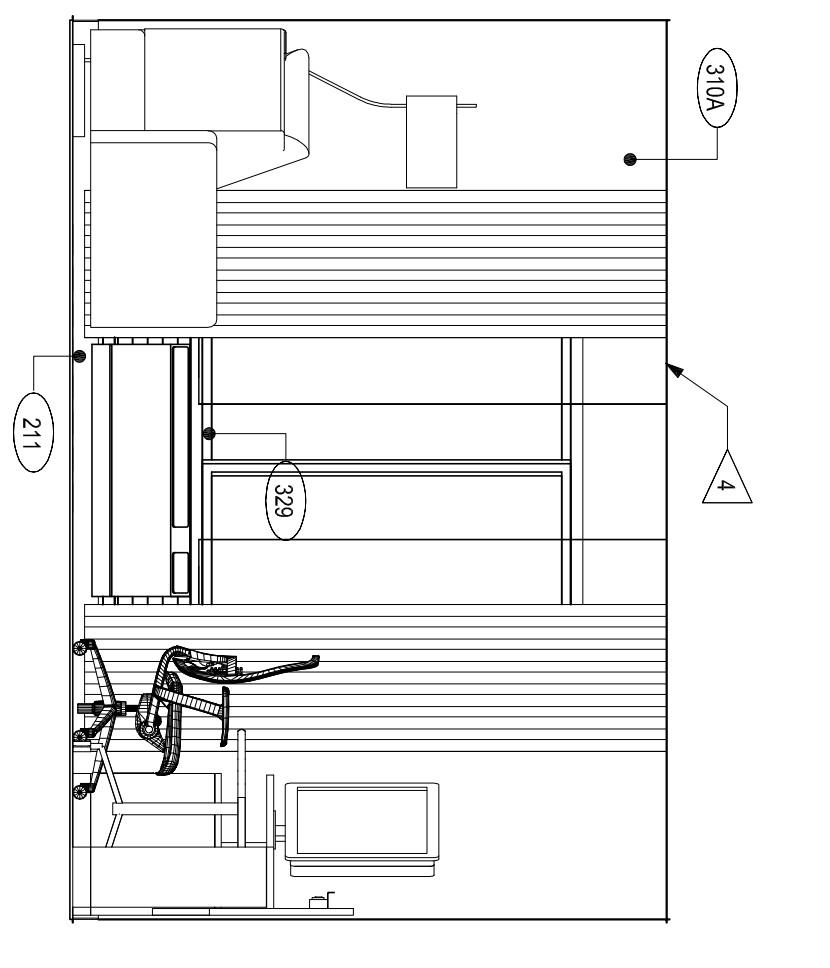

3A INTERIOR ELEVATION  
SCALE 3/8"=1'-0"

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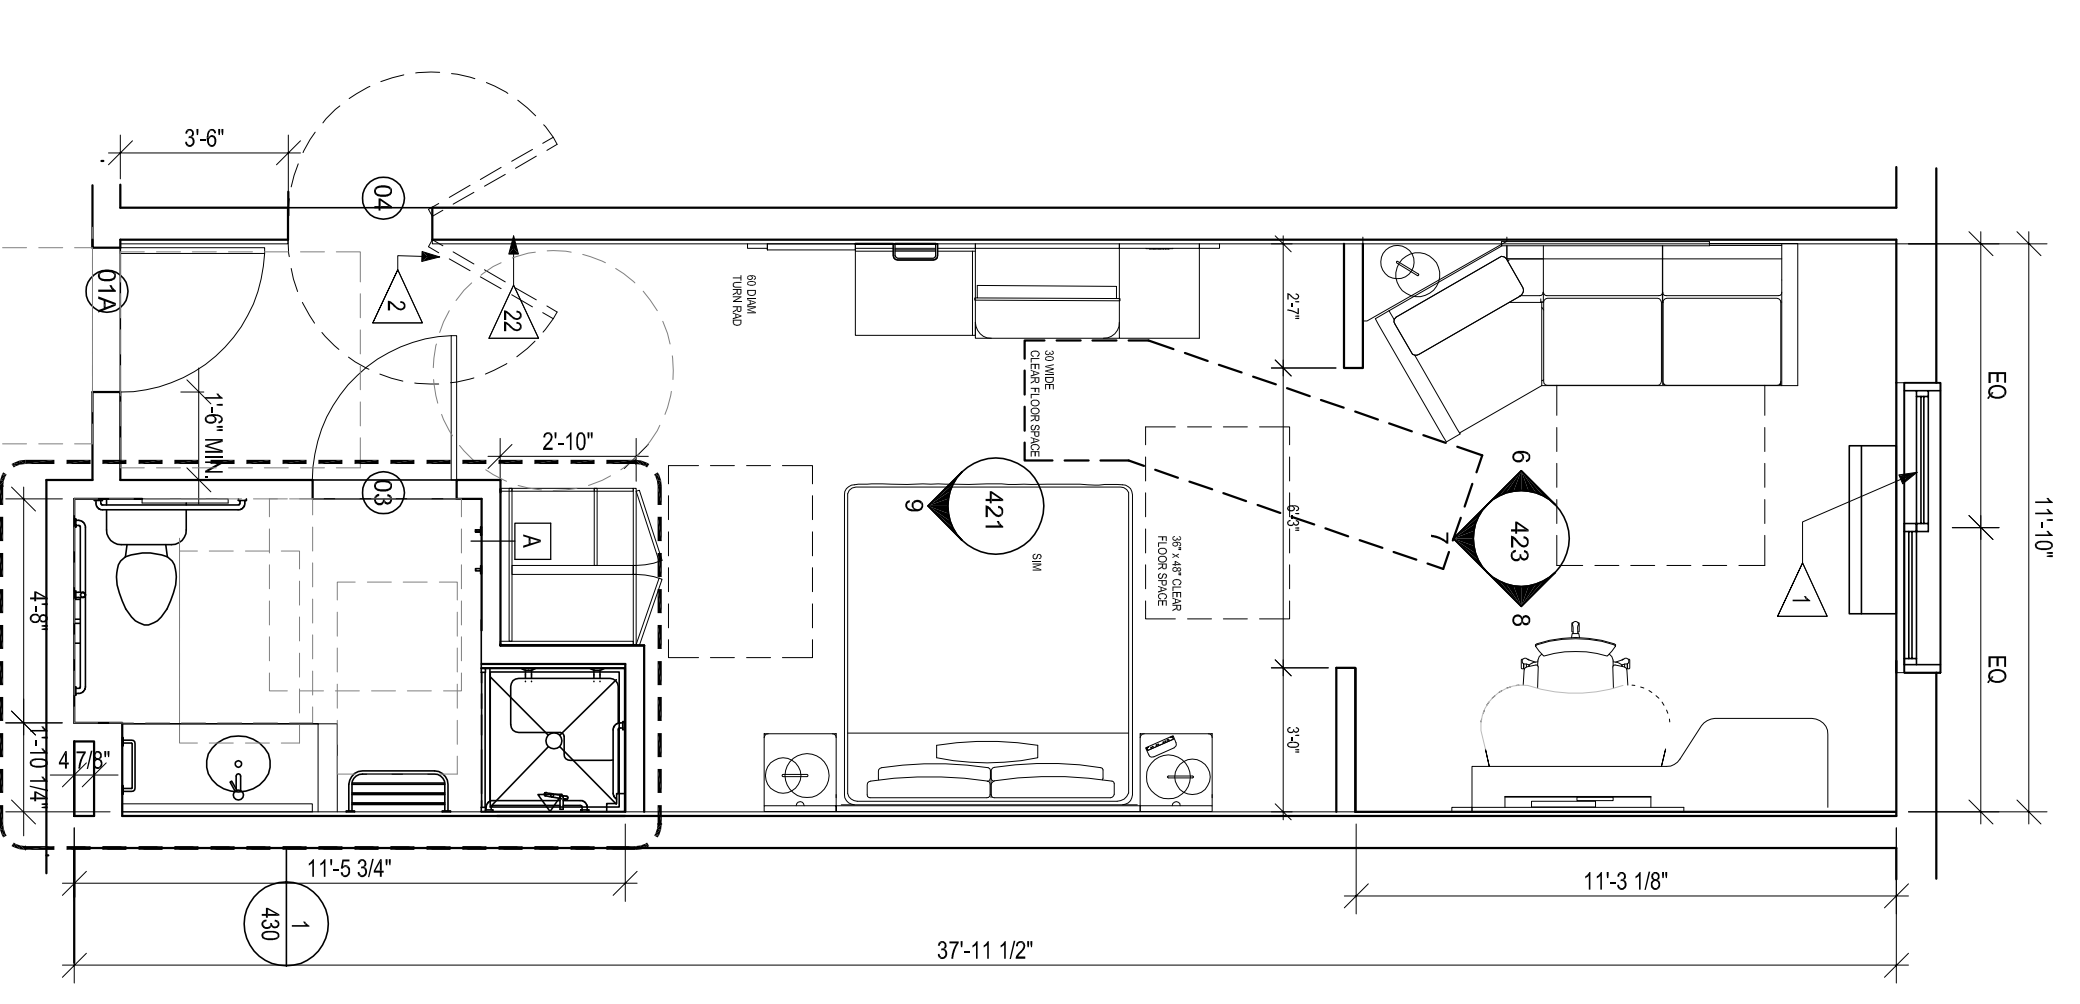
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CONSTRUCTION**

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2	11/22/2015	50% REVIEW SET
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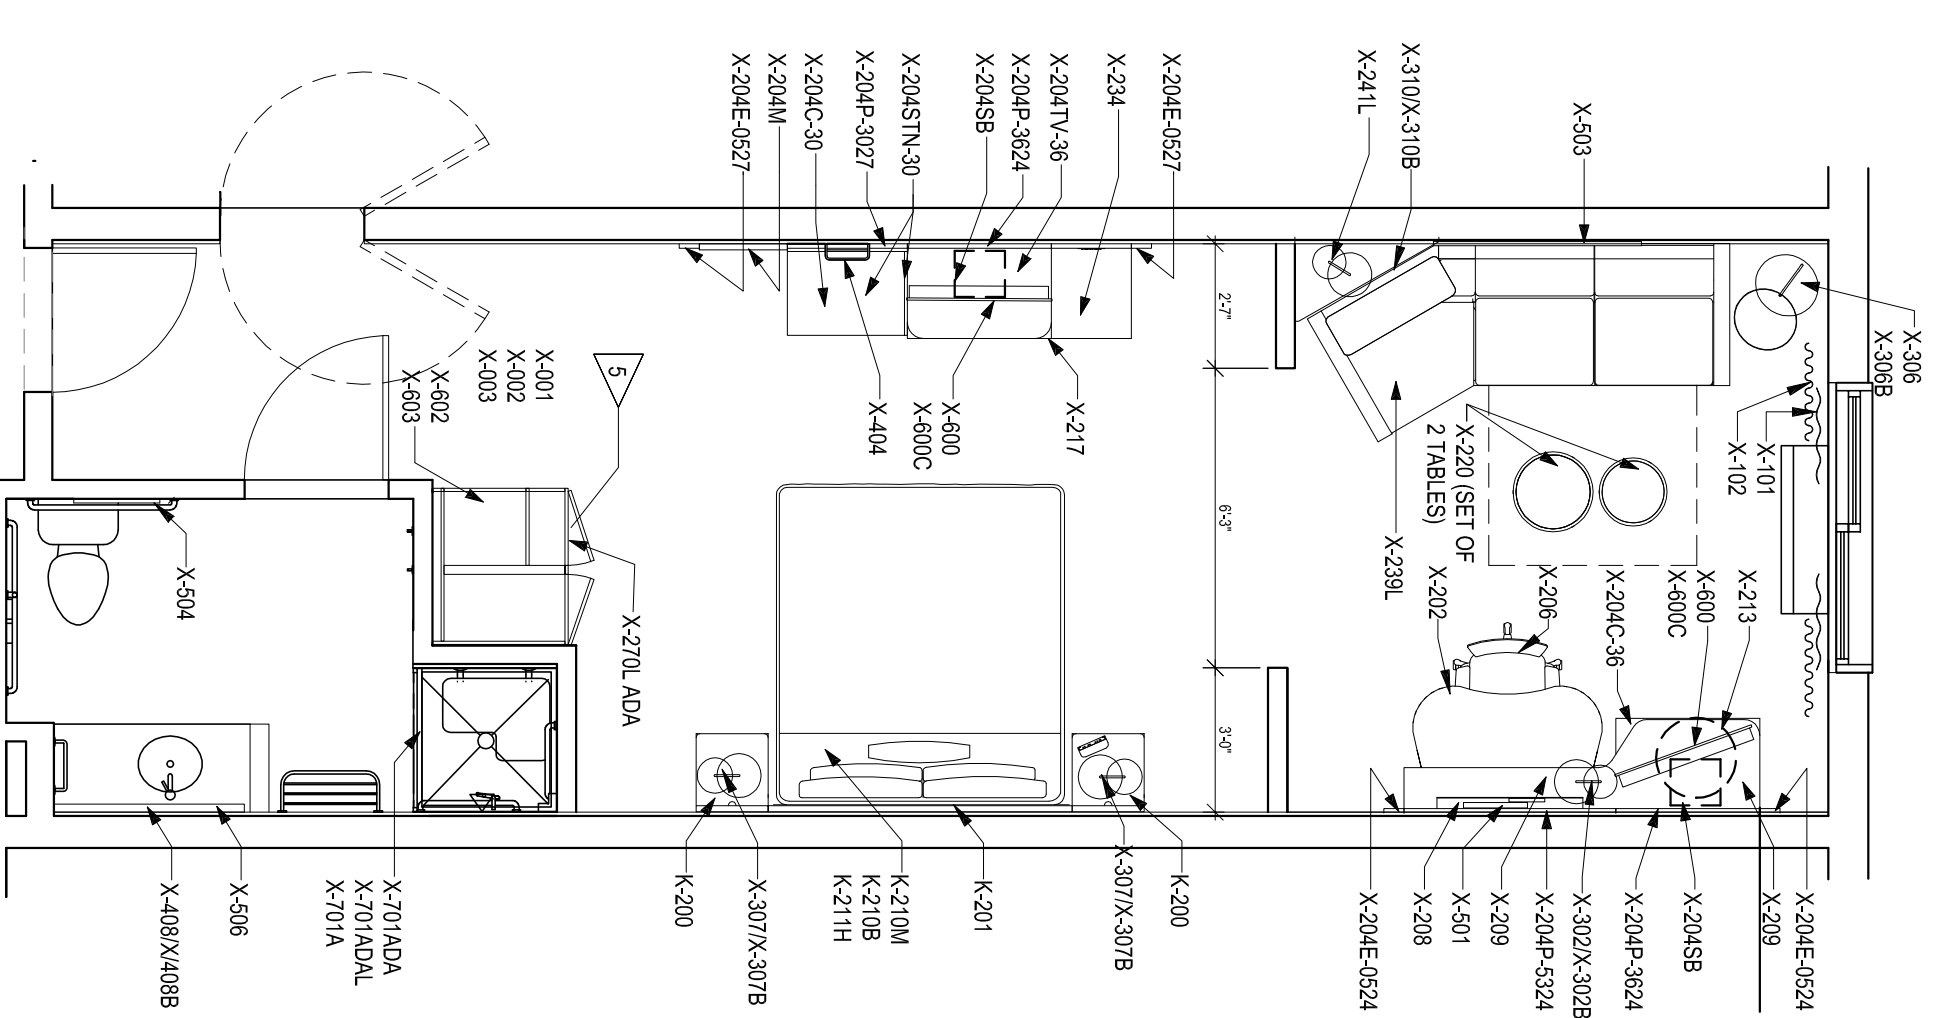
ISSUES & REVISIONS

PROJECT NAME:  
PROJECT NUMBER: 15180  
DRAWING NAME:  
SHEET NAME  
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CHECKED BY: BBC  
DATE: 12-22-15  
SCALE: AS NOTED  
DRAWING NUMBER  
**A504**






1C PLAN - KING SUITE ADA  
SCALE 1/4"=1'-0"



2C PLAN - FURNITURE LEFT  
SCALE 1/4"=1'-0"

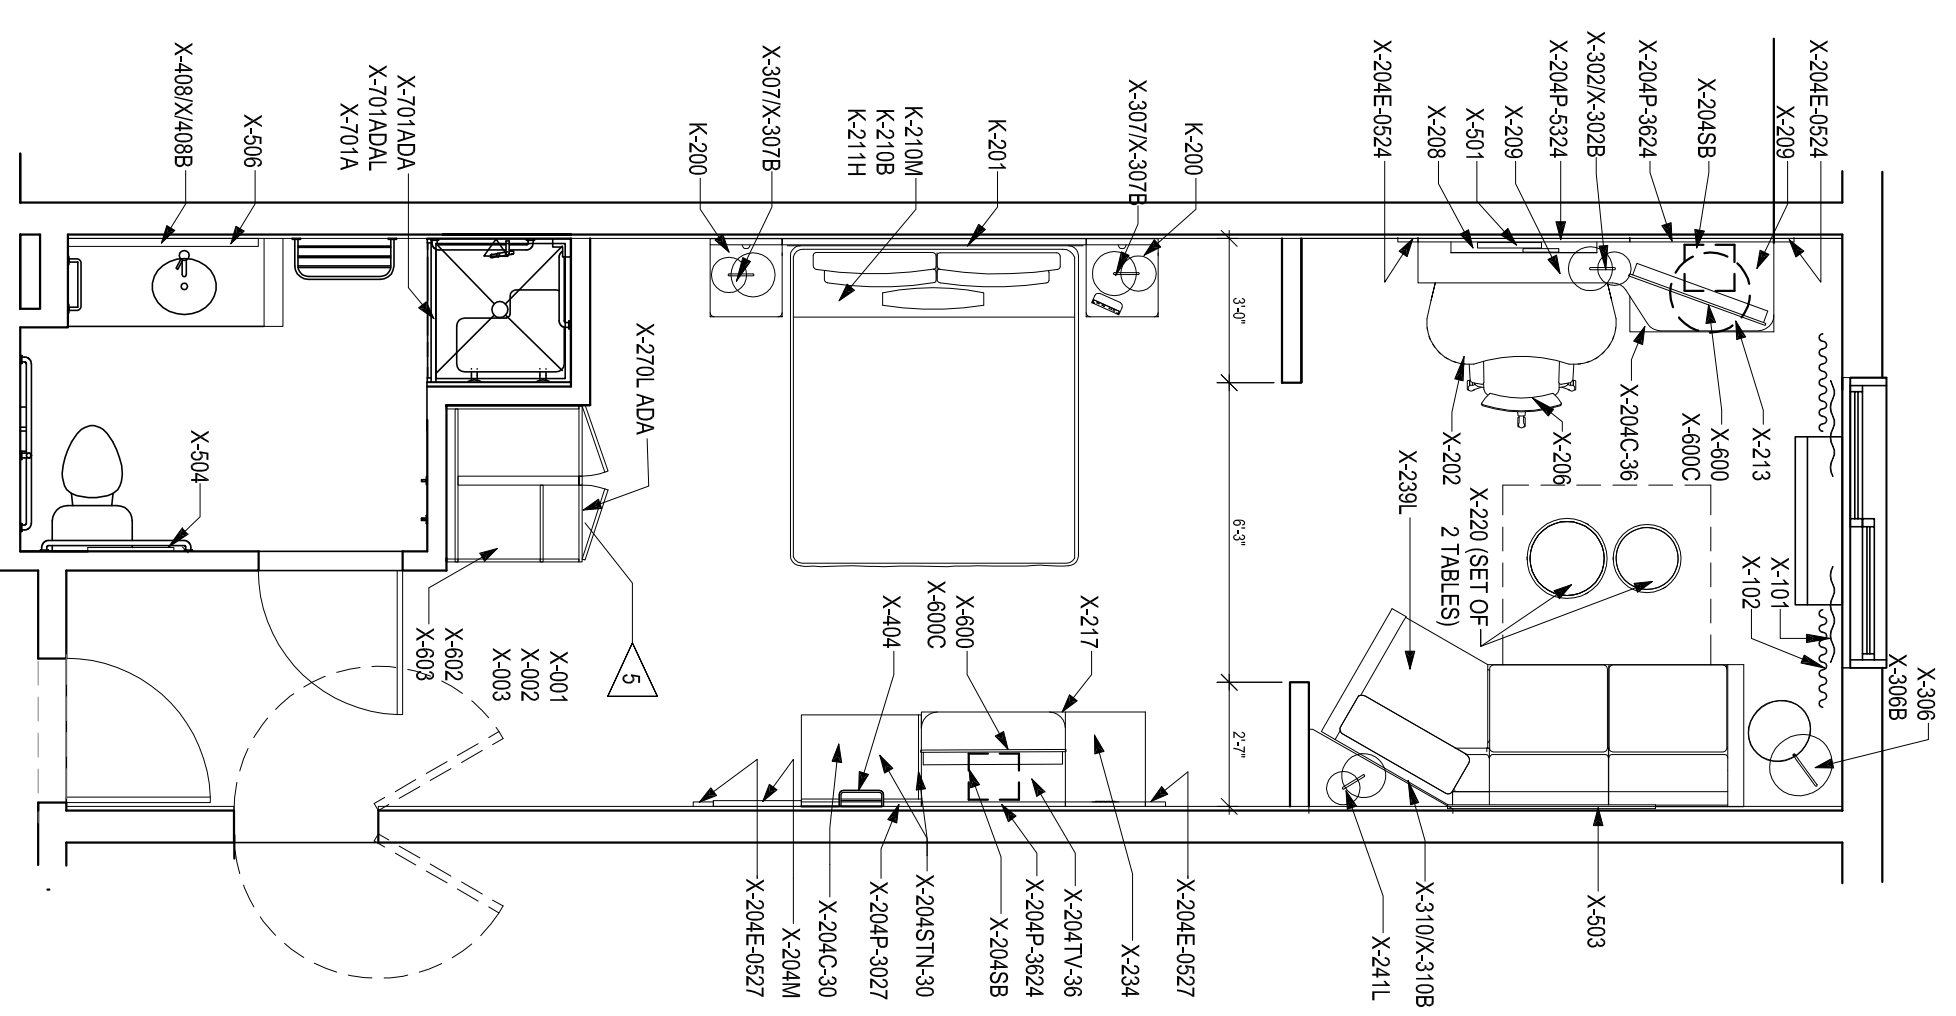

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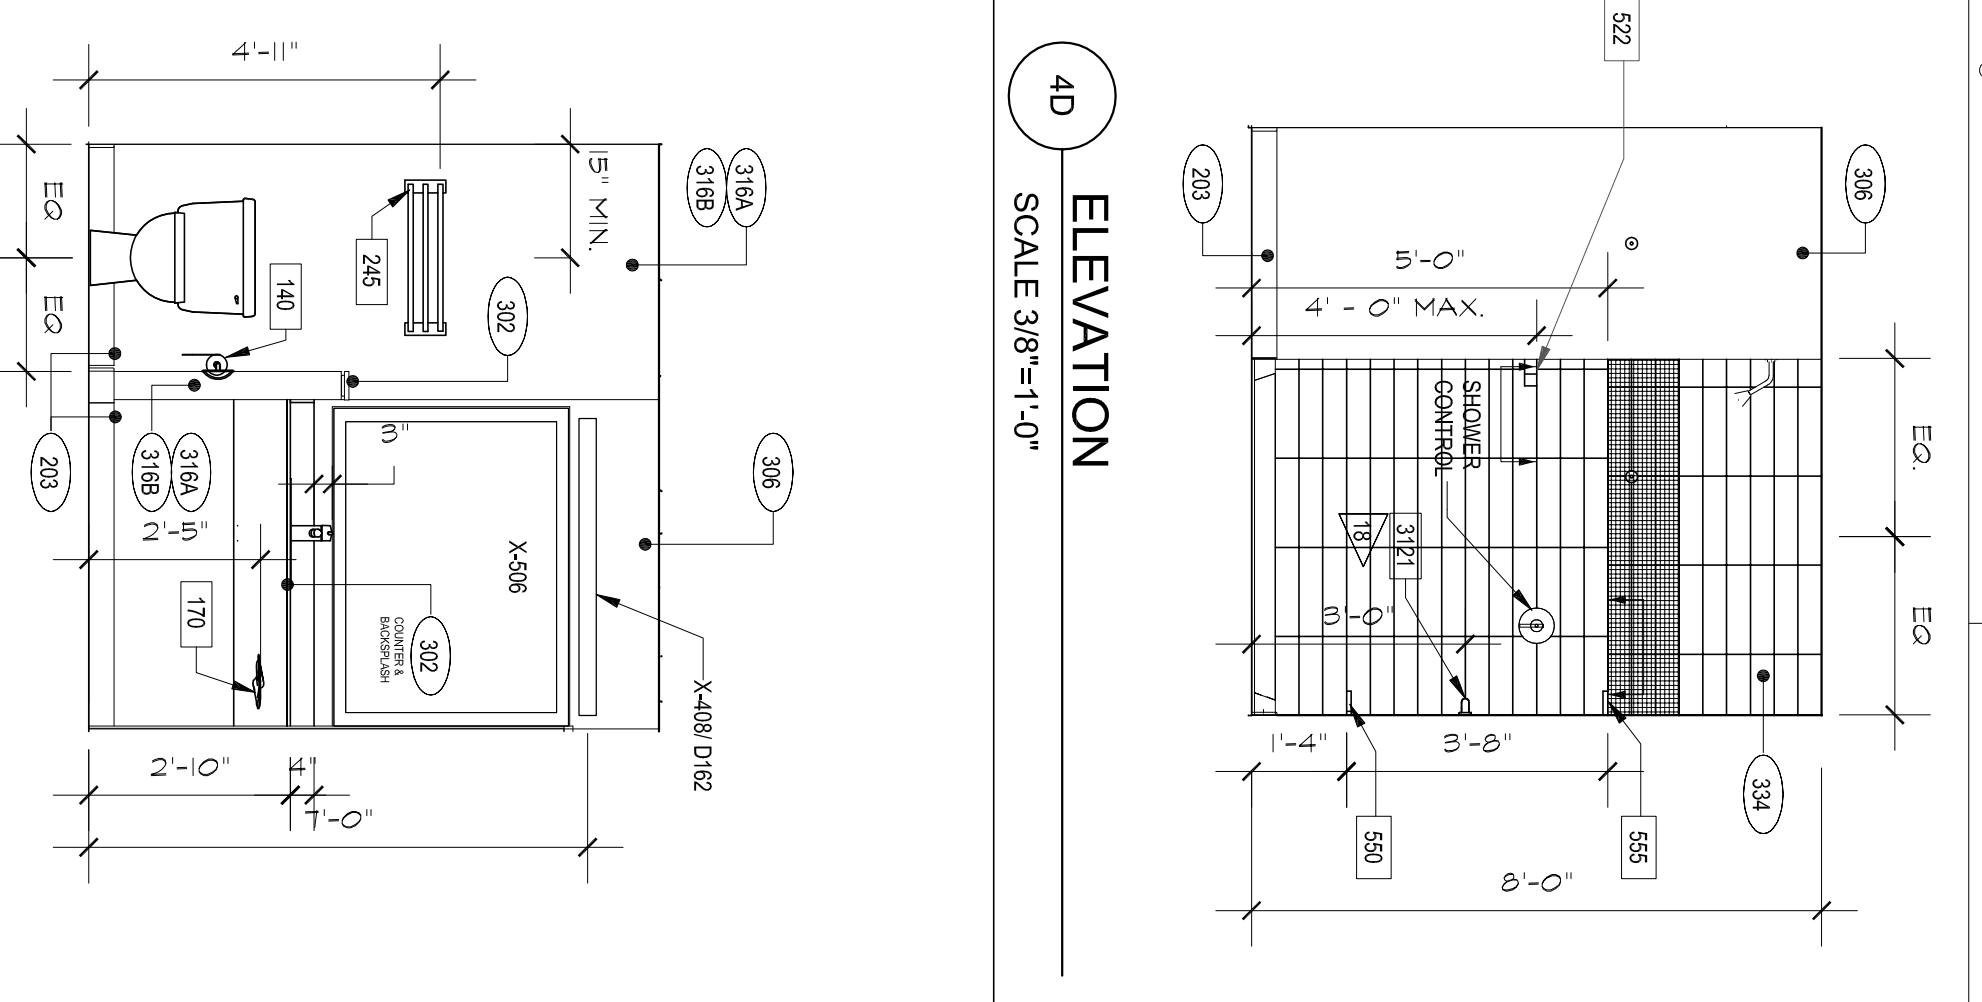


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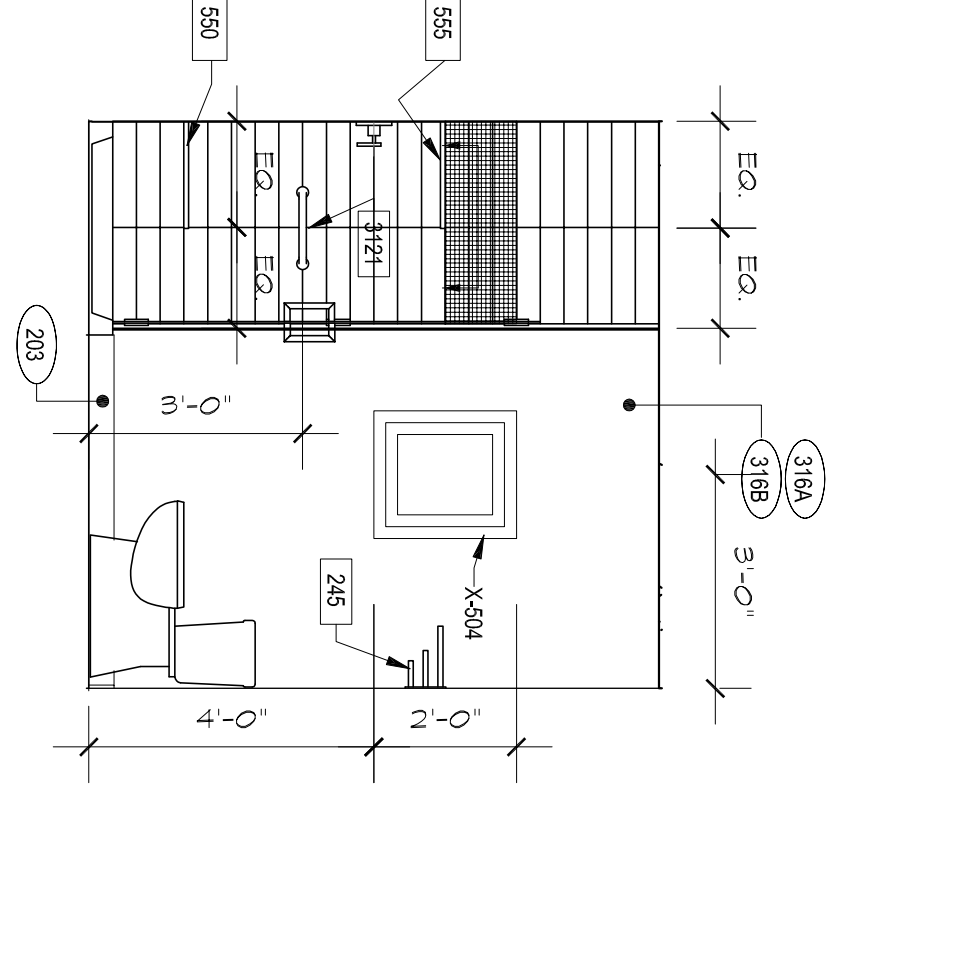
CONSULTANTS

ISSUES & REVISIONS
NO. DATE DESCRIPTION
1 06/07/2014 CODE SUBMITTAL


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DRAWING NUMBER:	
SHEET NAME:	
GUEST BATHROOM PLAN	
DRAWN BY:	NK/BBC/CLK
CHECKED BY:	7-30-14
DATE:	AS NOTED
SCALE:	
DRAWING NUMBER:	A506




4D ELEVATION  
 SCALE 3/8"=1'-0"




3D ELEVATION  
 SCALE 3/8"=1'-0"

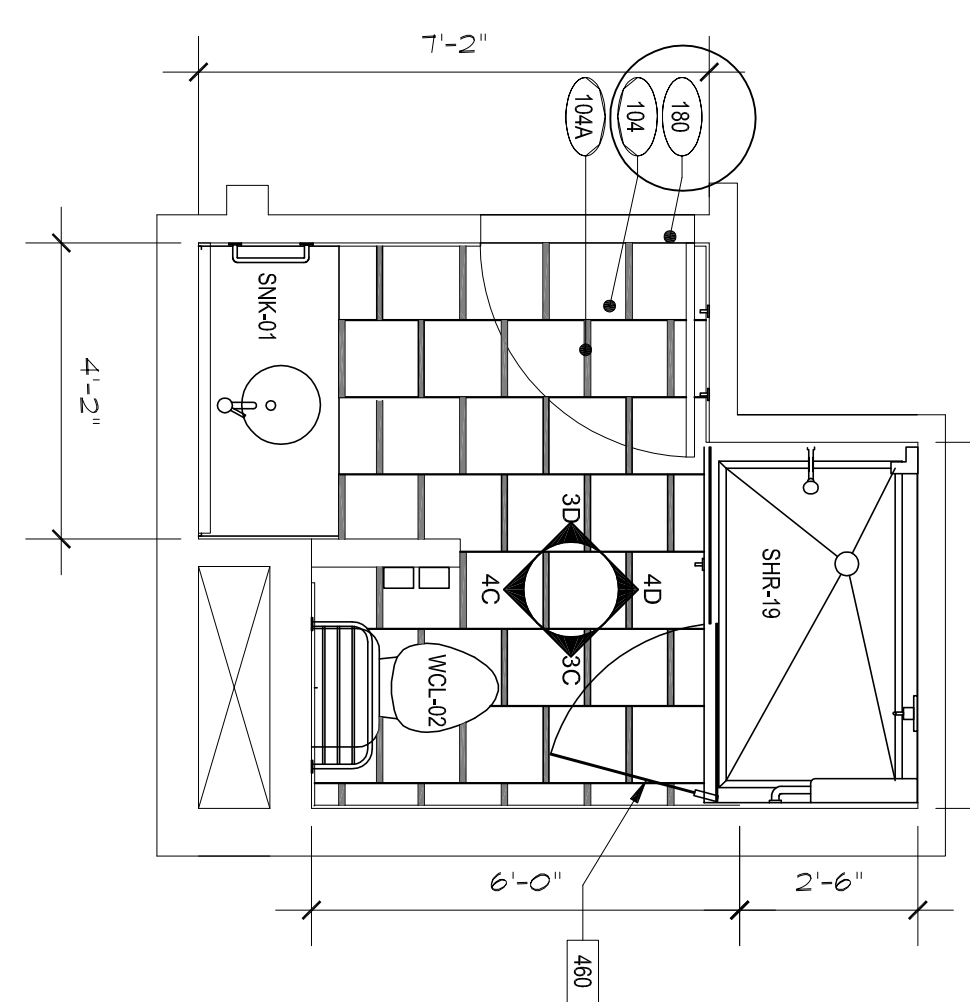


1C BATHROOM WITH SHOWER  
 SCALE 3/8"=1'-0"

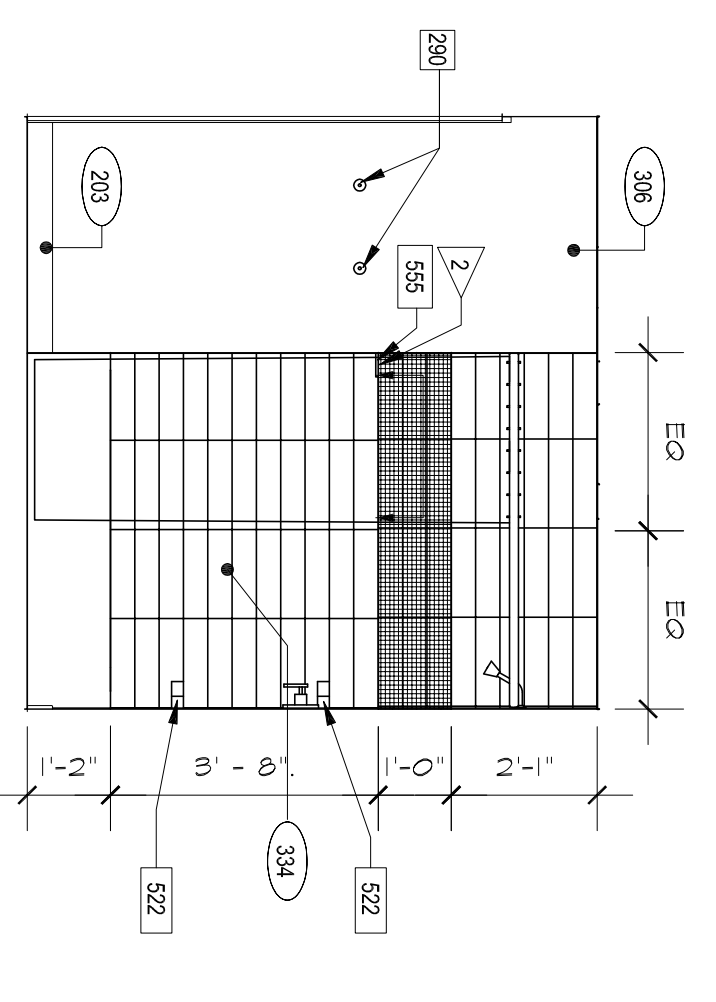


4B ELEVATION  
 SCALE 3/8"=1'-0"

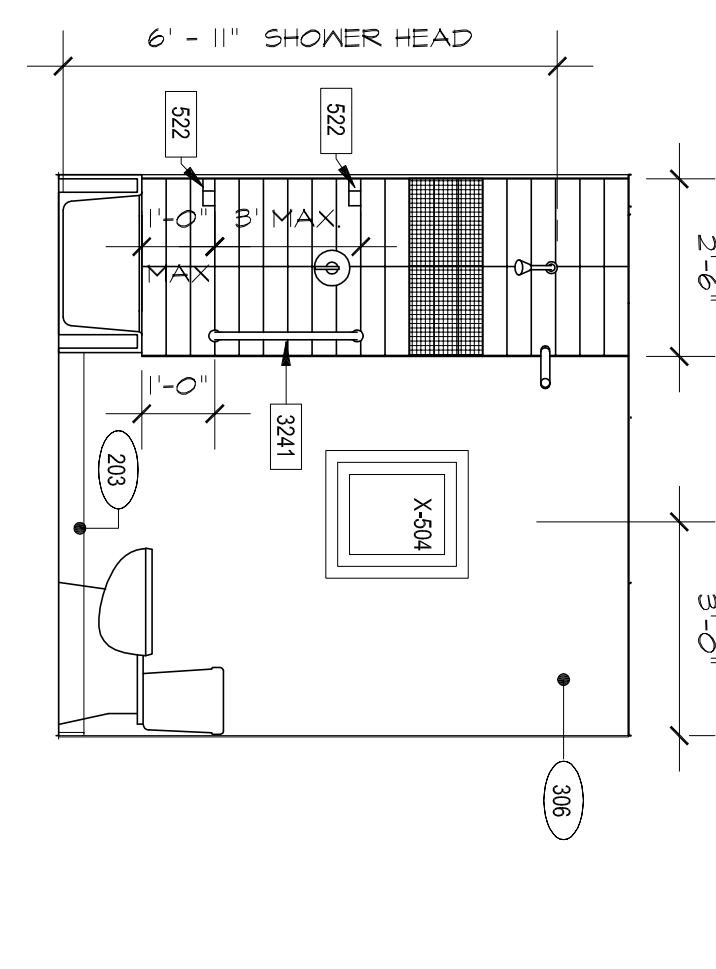


3B ELEVATION  
 SCALE 3/8"=1'-0"

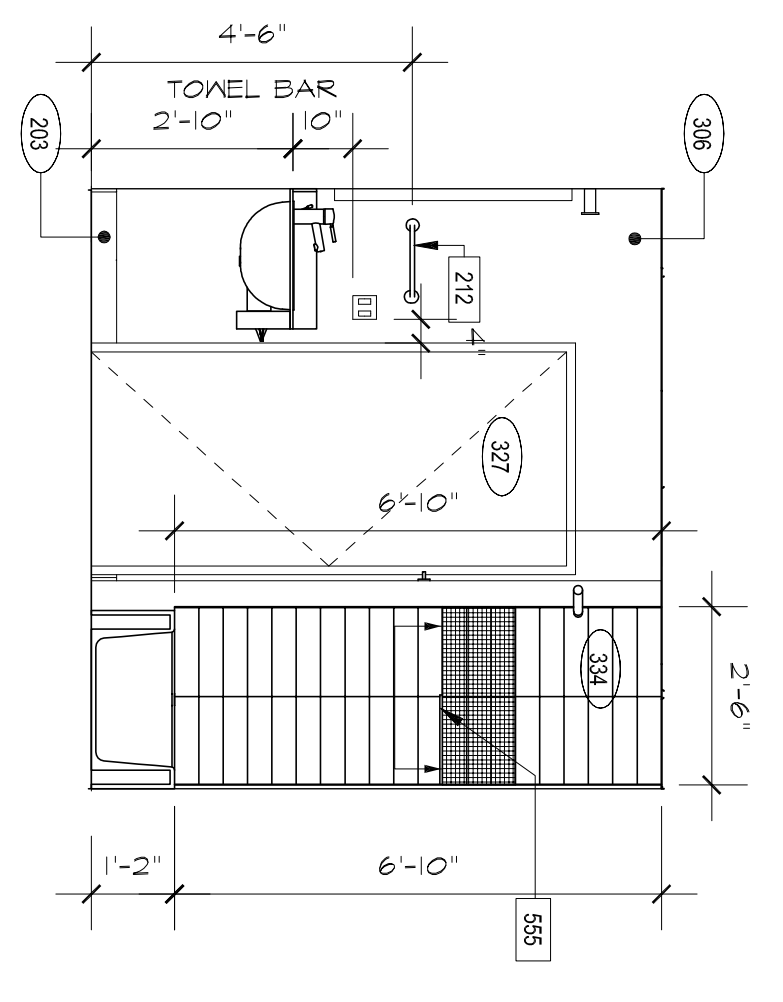

4A ELEVATION  
 SCALE 3/8"=1'-0"

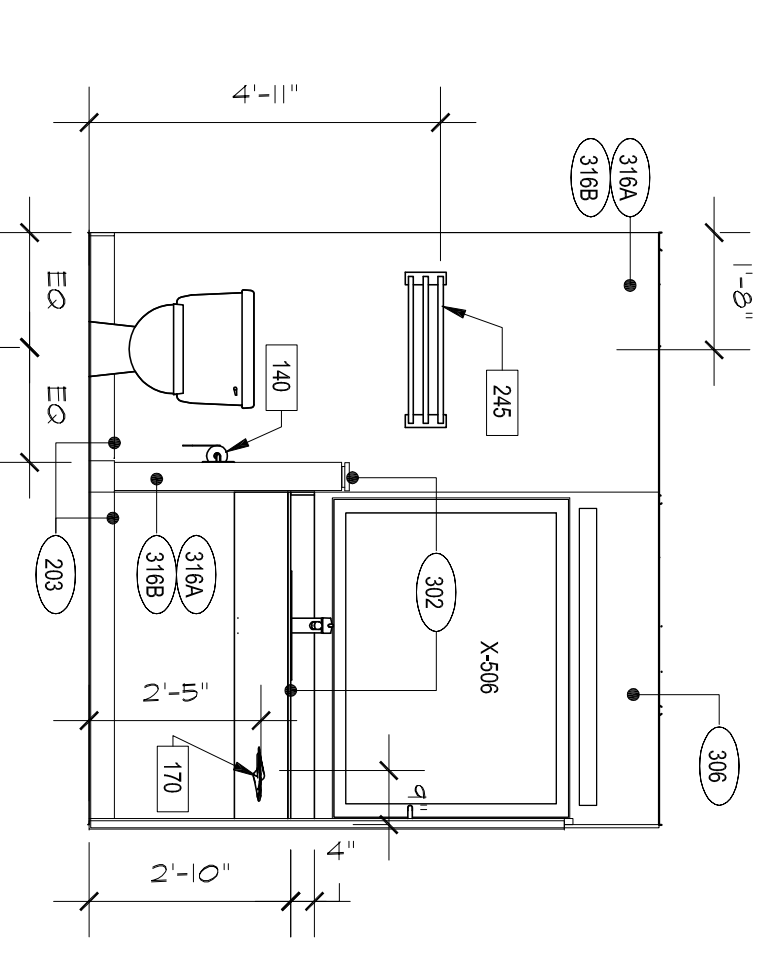

3A ELEVATION  
 SCALE 3/8"=1'-0"

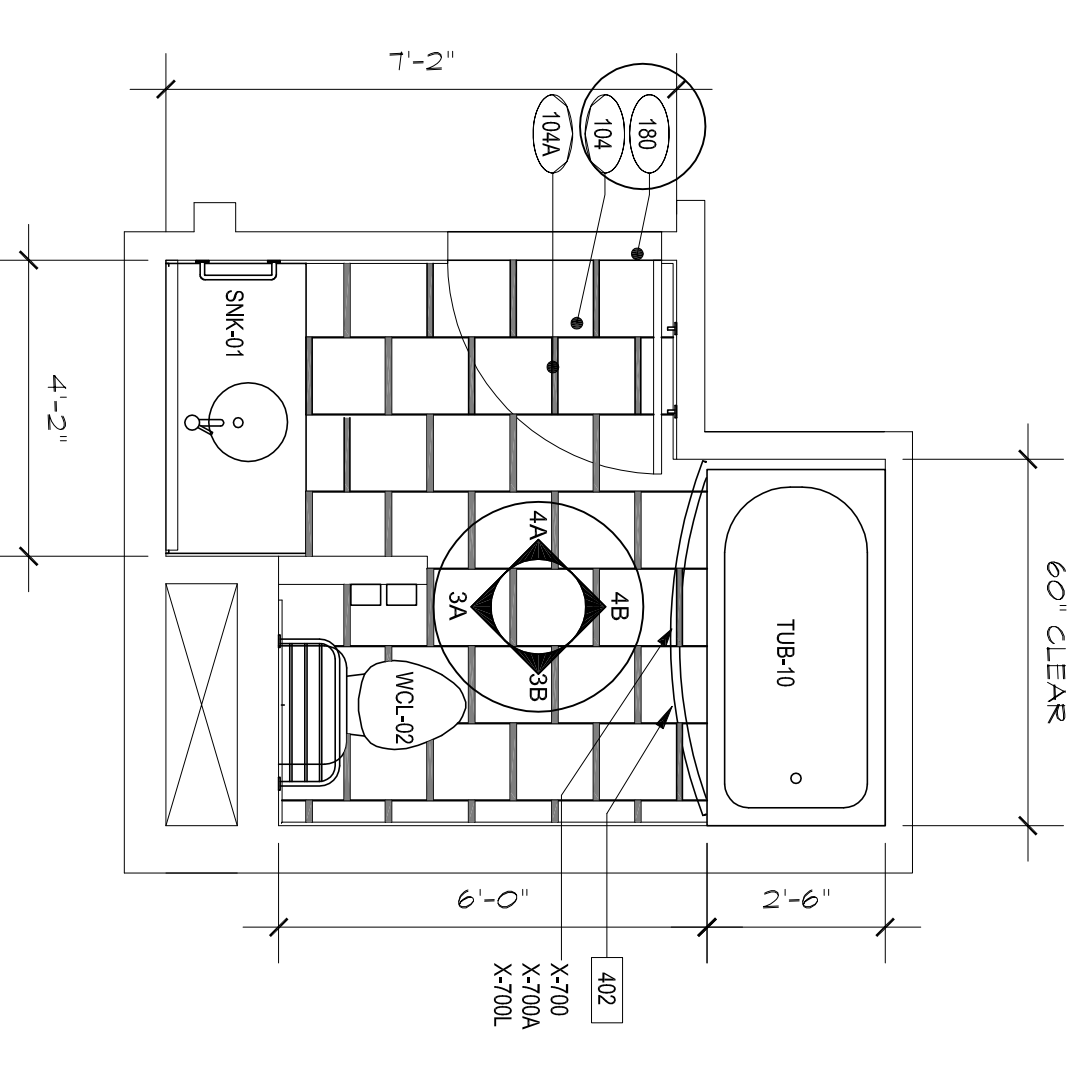

1A BATHROOM WITH TUB  
 SCALE 3/8"=1'-0"

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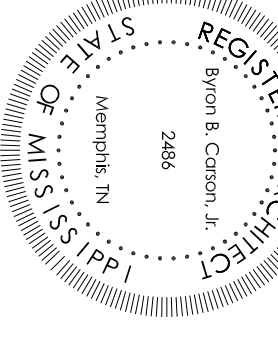
ARCHITECT

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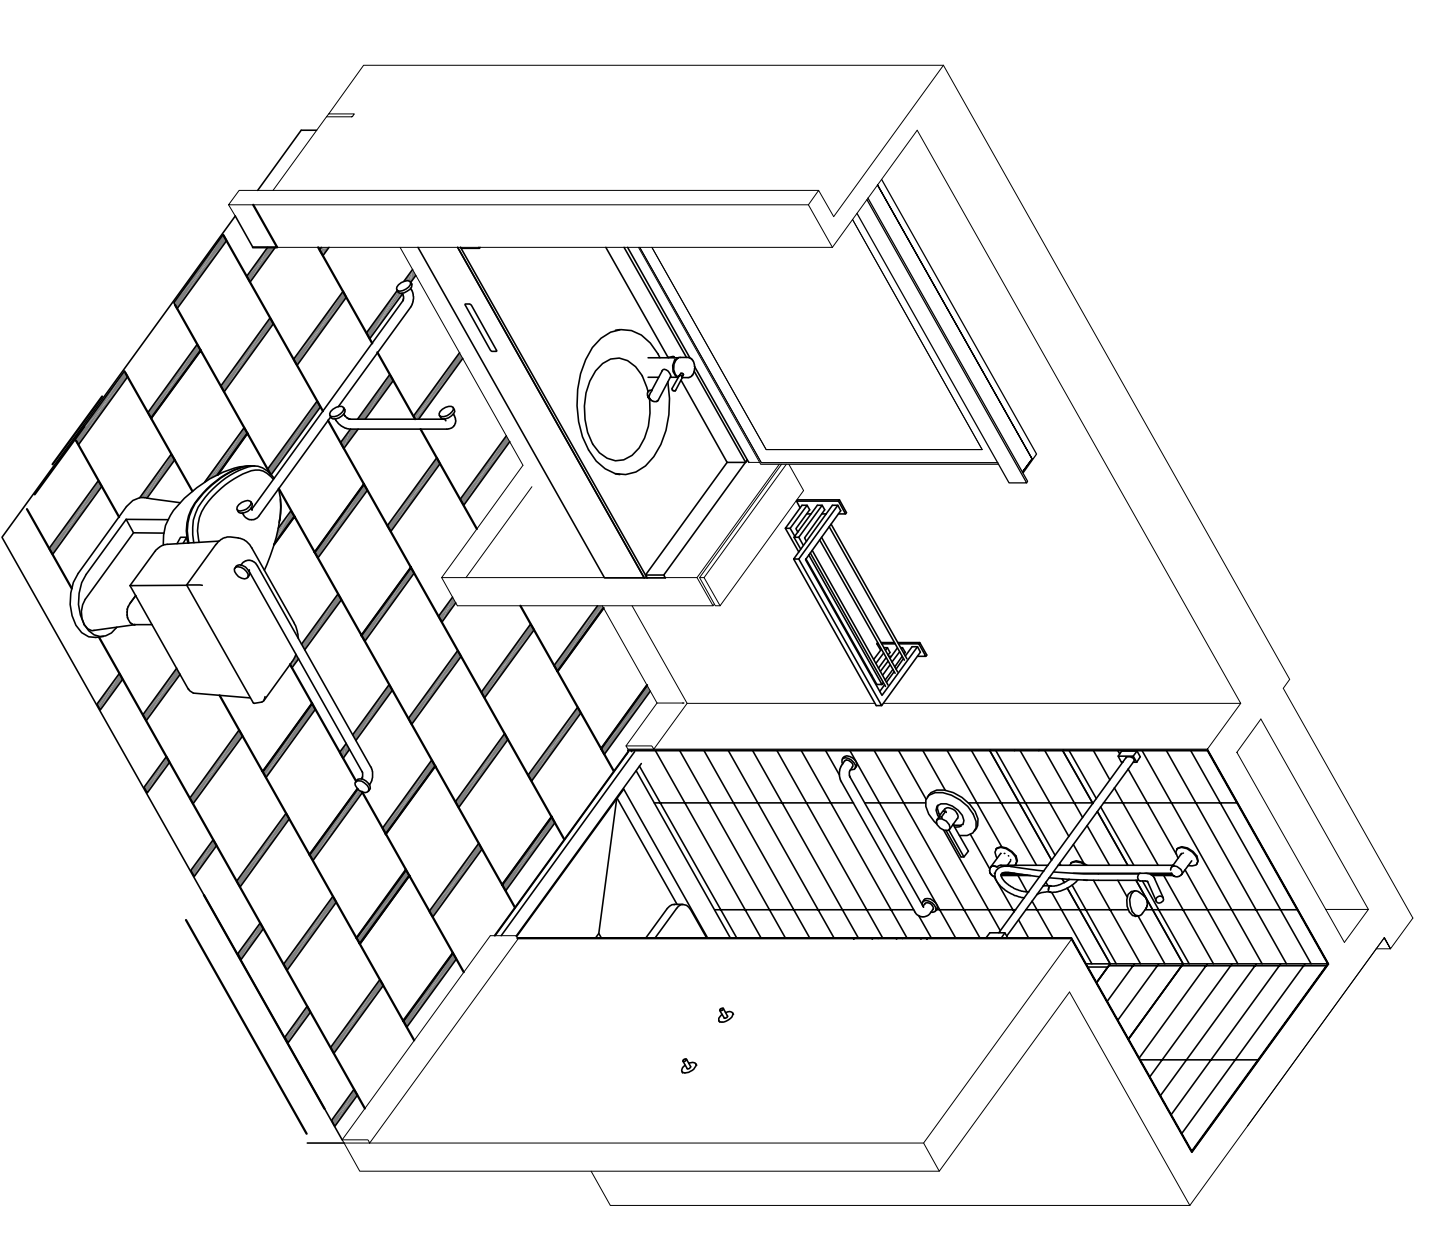
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PROJECT NUMBER:  
DRAWING NAME:  
SHEET NAME:  
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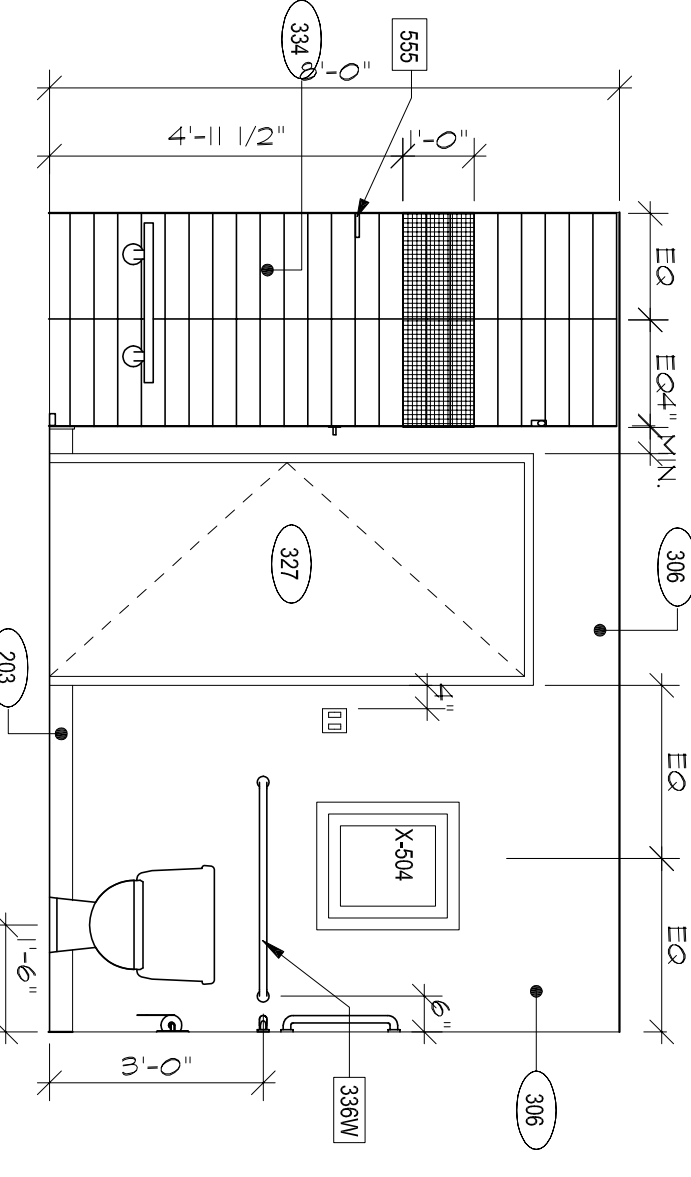
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DATE: 7-30-14  
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DRAWING NUMBER


A507




5C TRANSFER SHOWER



3D ELEVATION  
SCALE 3/8"=1'-0"

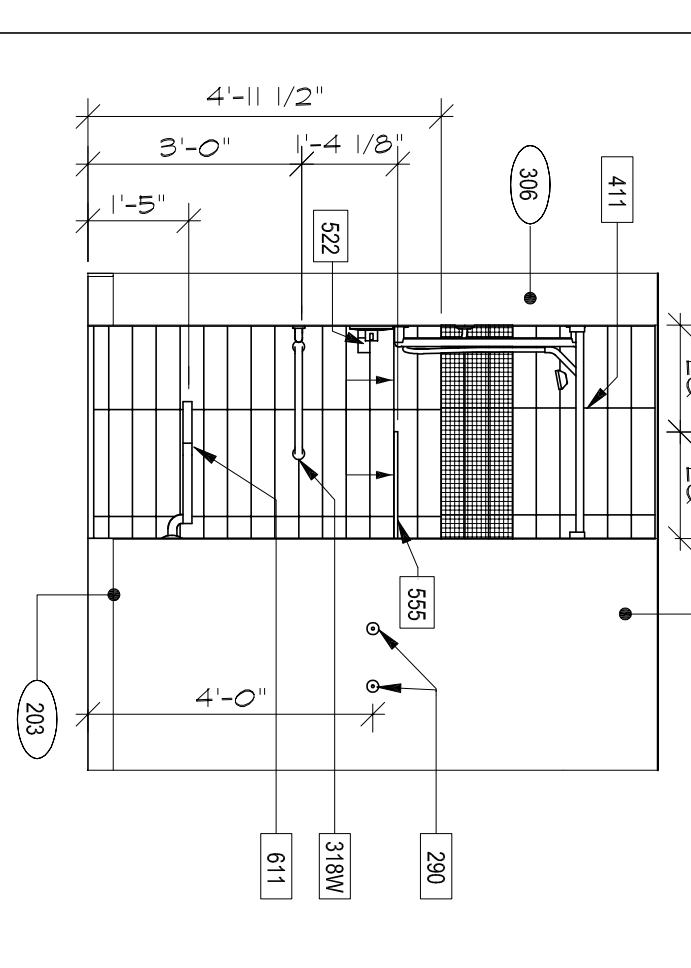


2C ELEVATION  
SCALE 3/8"=1'-0"

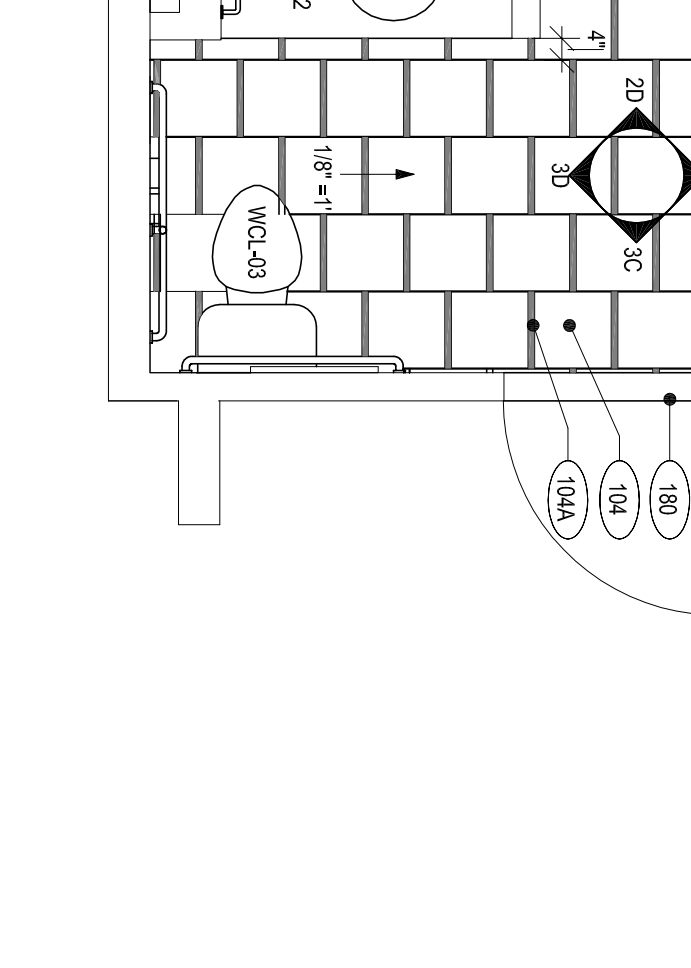


1C PLAN-ACCESSIBLE BATHROOM W/ TRANSFER SHOWER  
SCALE 3/8"=1'-0"


NOTE:  
COORDINATE CLEAR DIMENSIONS OF TUB & SHOWER  
COMPONENTS TO FINISH SURFACES. REFER TO  
PLUMBING FIXTURE MANUAL FOR CUT SHEETS.

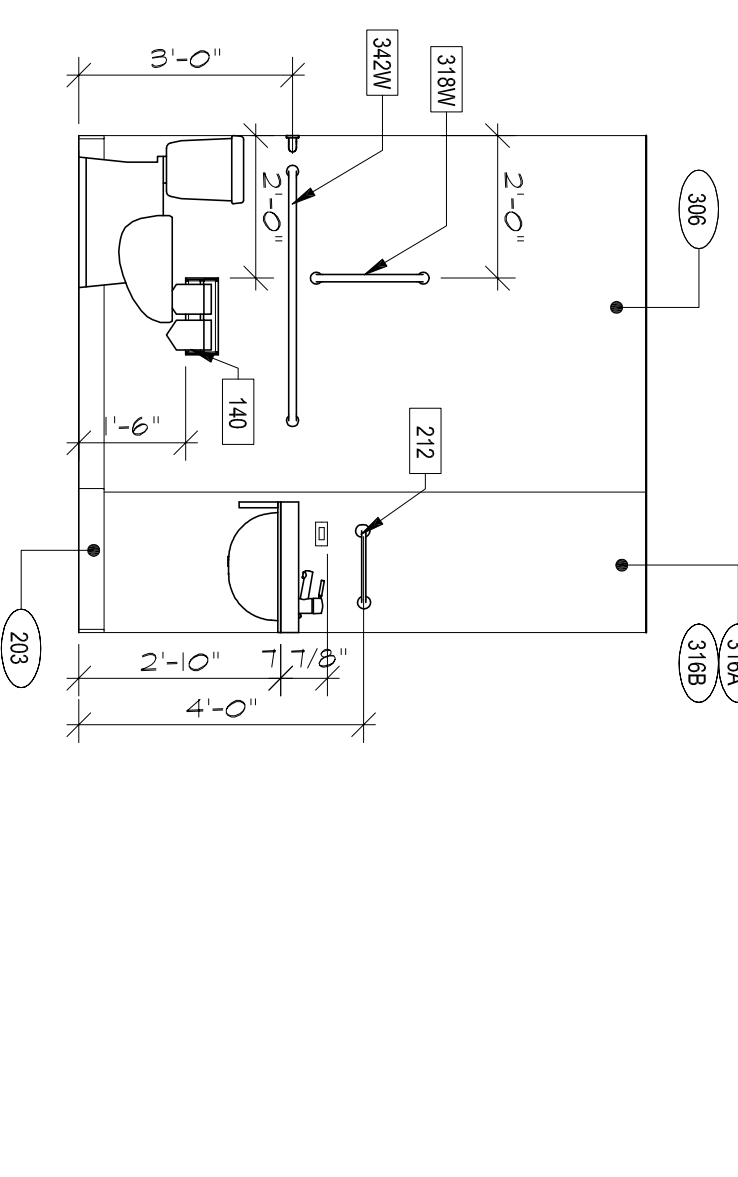


3B ELEVATION  
SCALE 3/8"=1'-0"

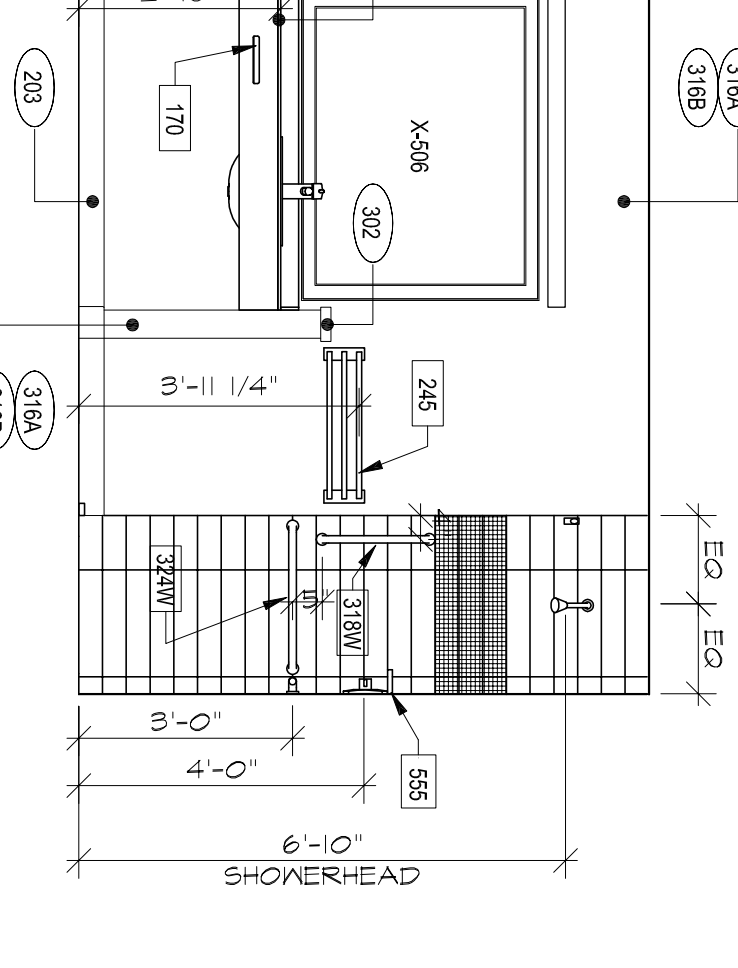


2B ELEVATION  
SCALE 3/8"=1'-0"

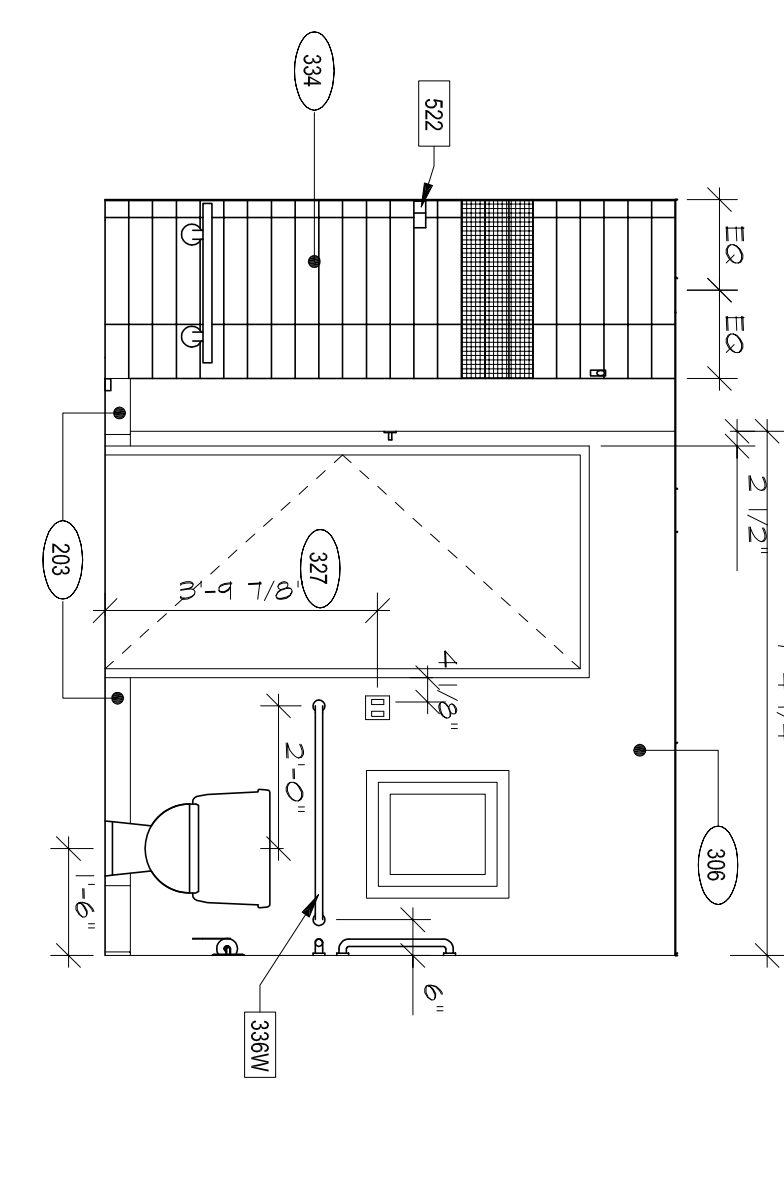


3A ELEVATION  
SCALE 3/8"=1'-0"

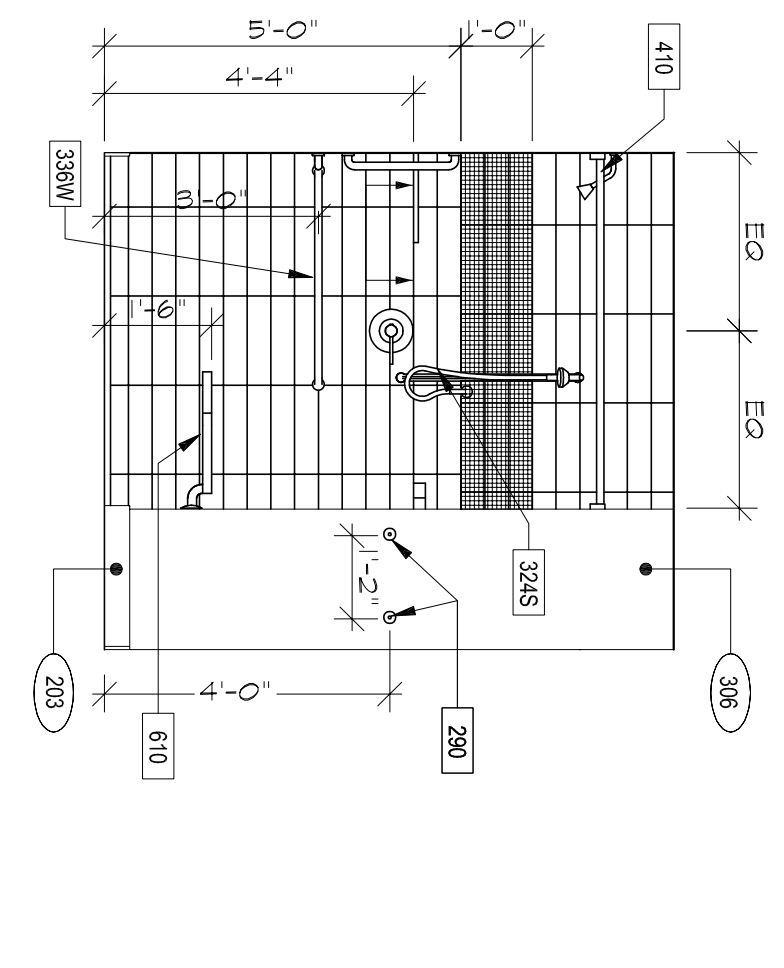


2A ELEVATION  
SCALE 3/8"=1'-0"

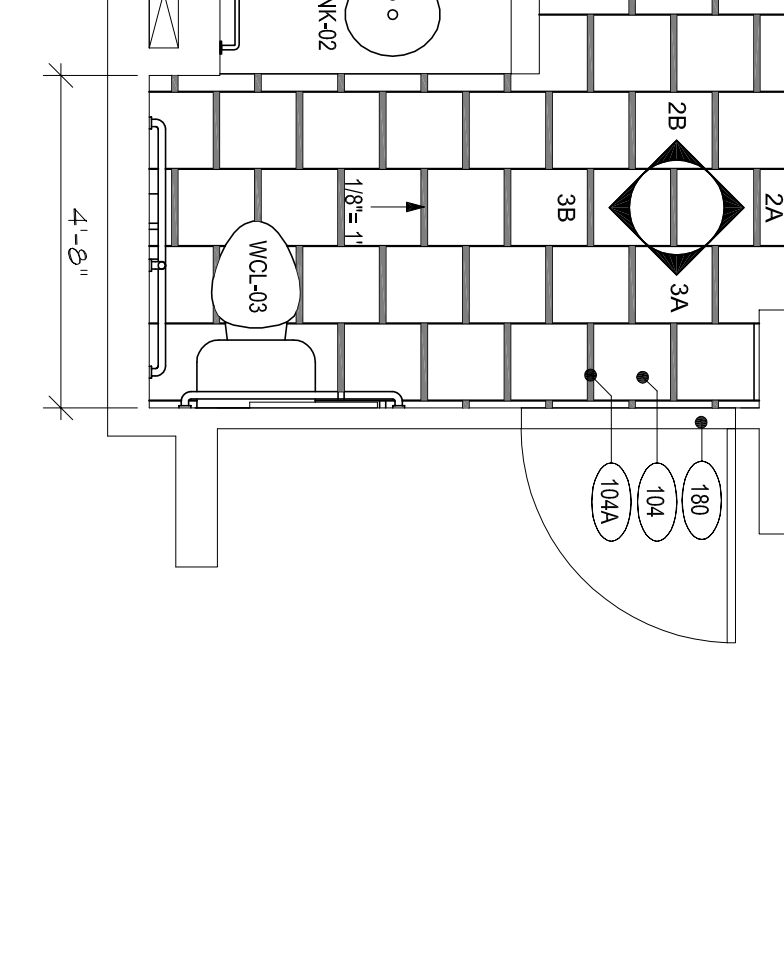


1A PLAN-ACCESSIBLE BATHROOM W/ ROLL IN SHOWER  
SCALE 3/8"=1'-0"

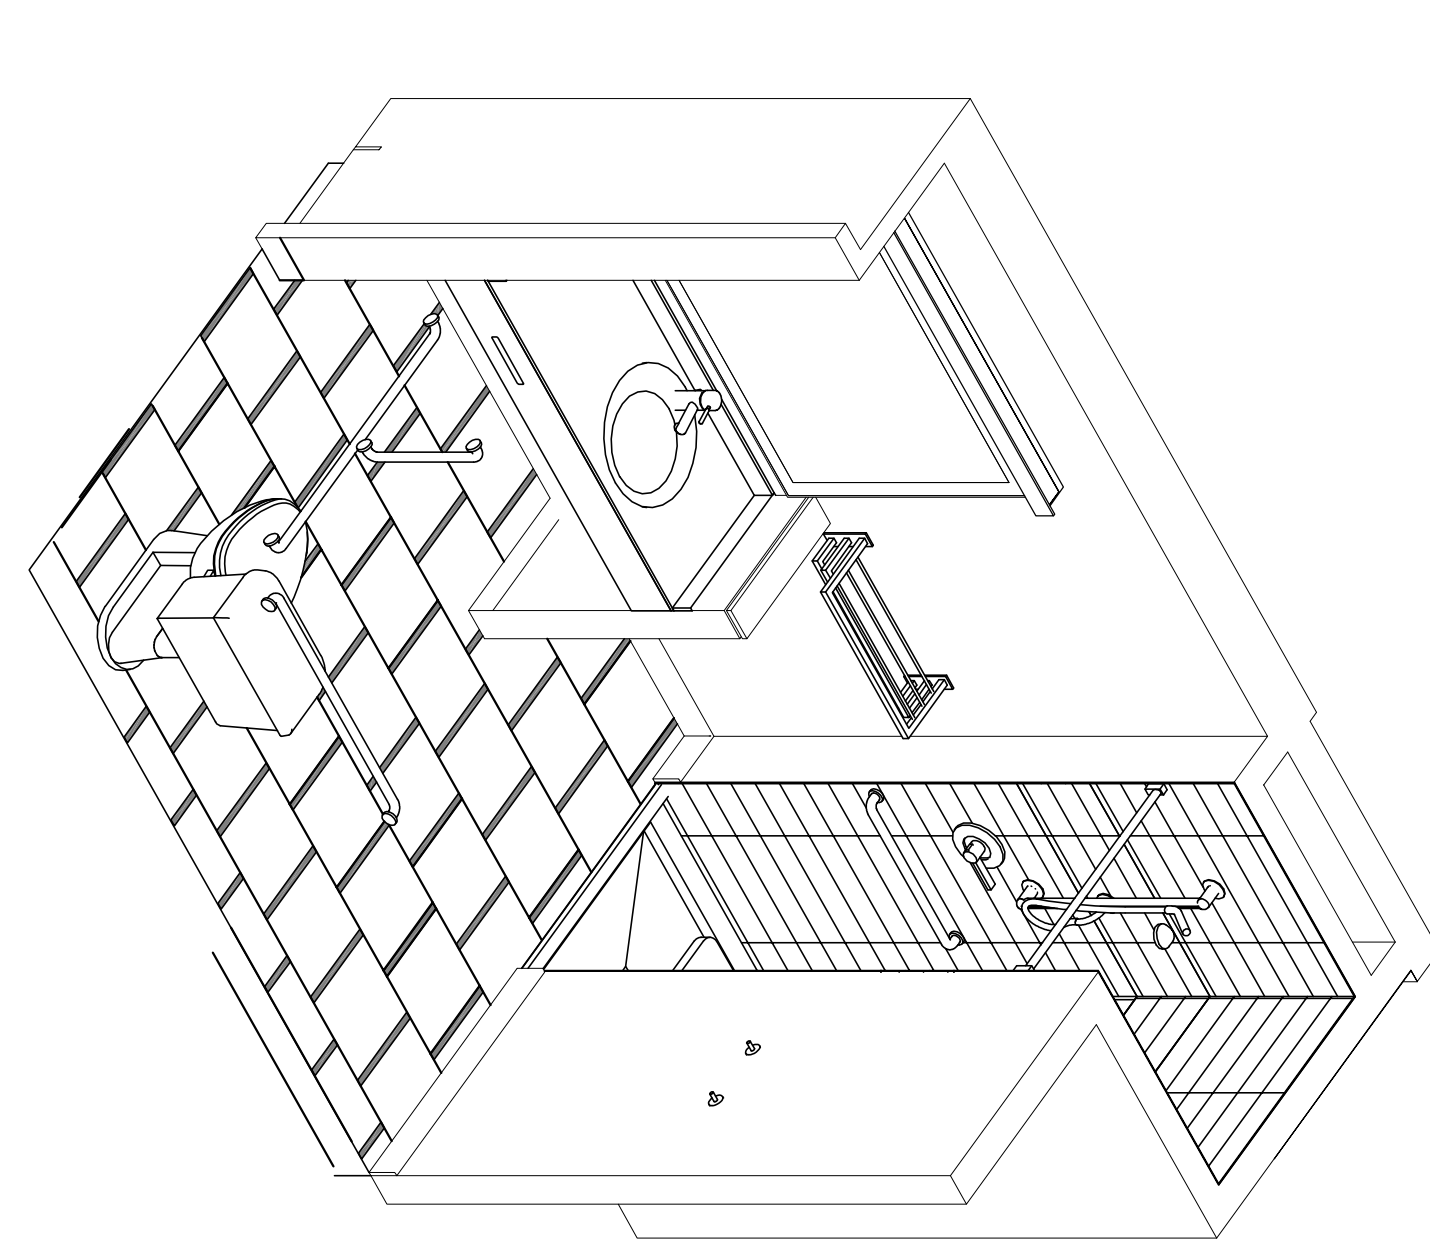


5A ROLL IN SHOWER

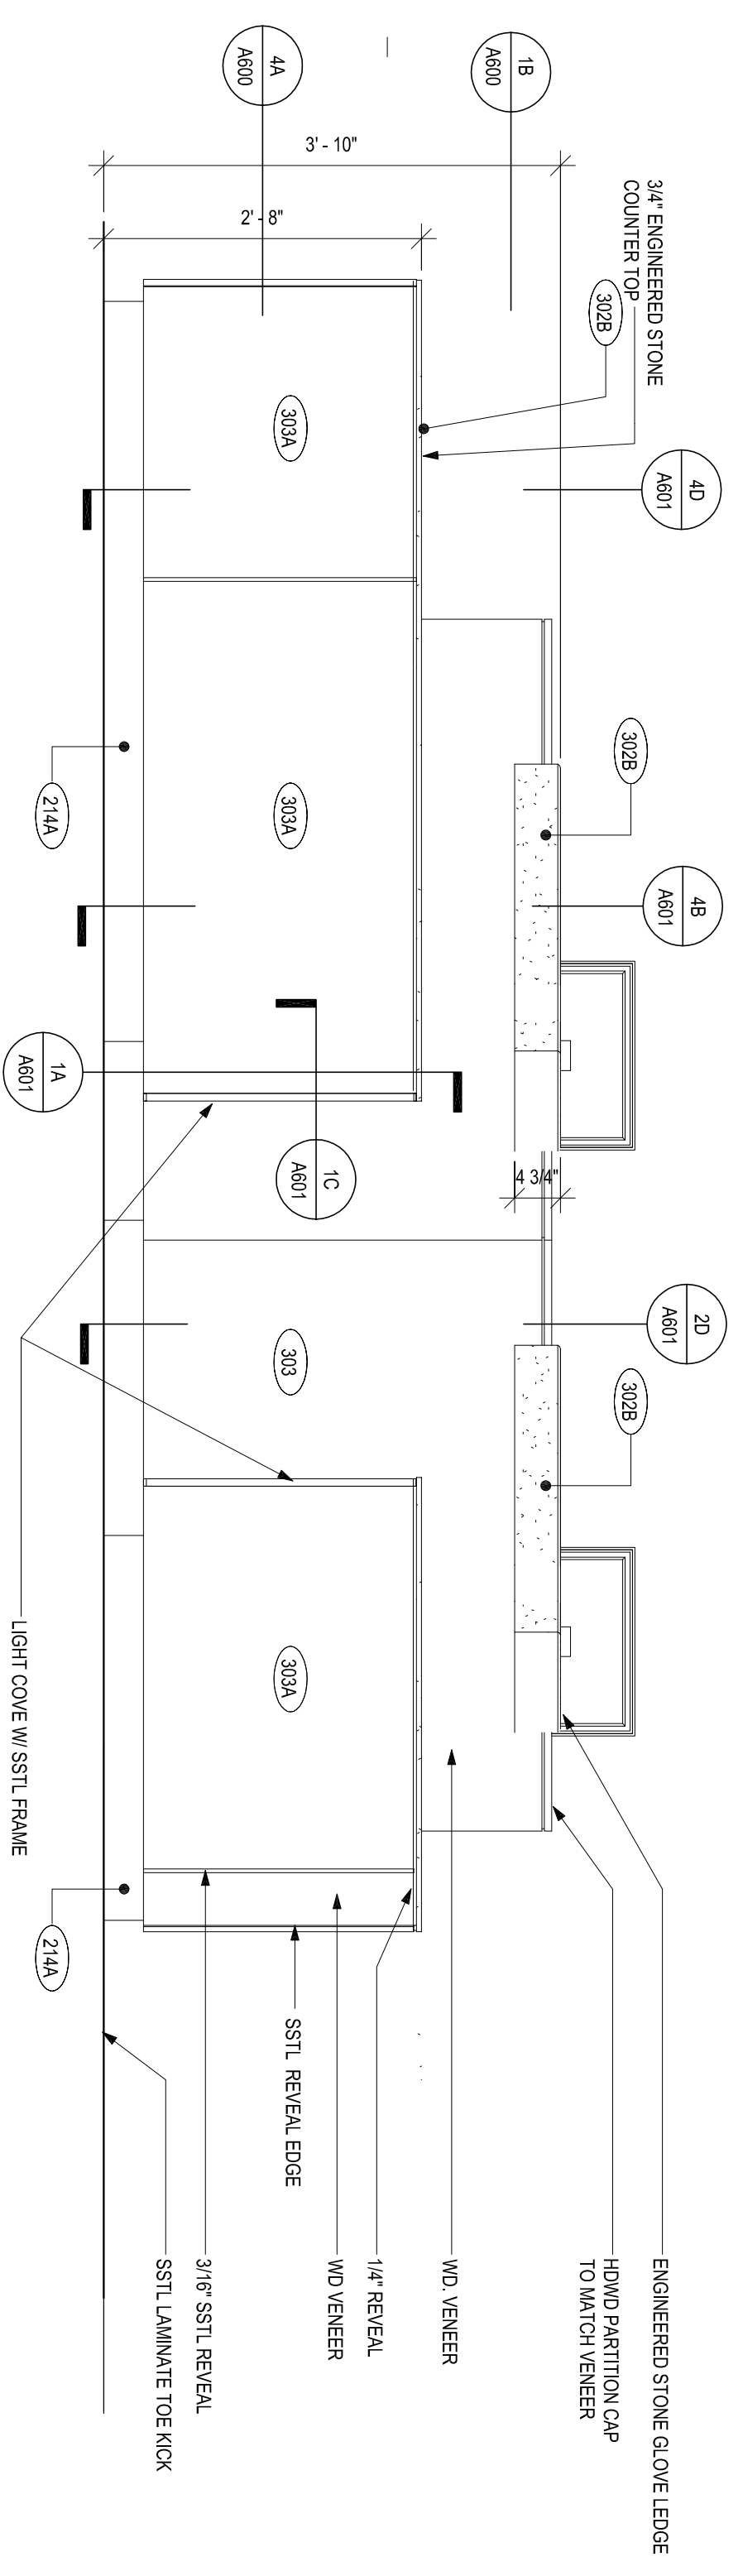


1D WELCOME DESK - FRONT  
SCALE 3/4"=1'-0"

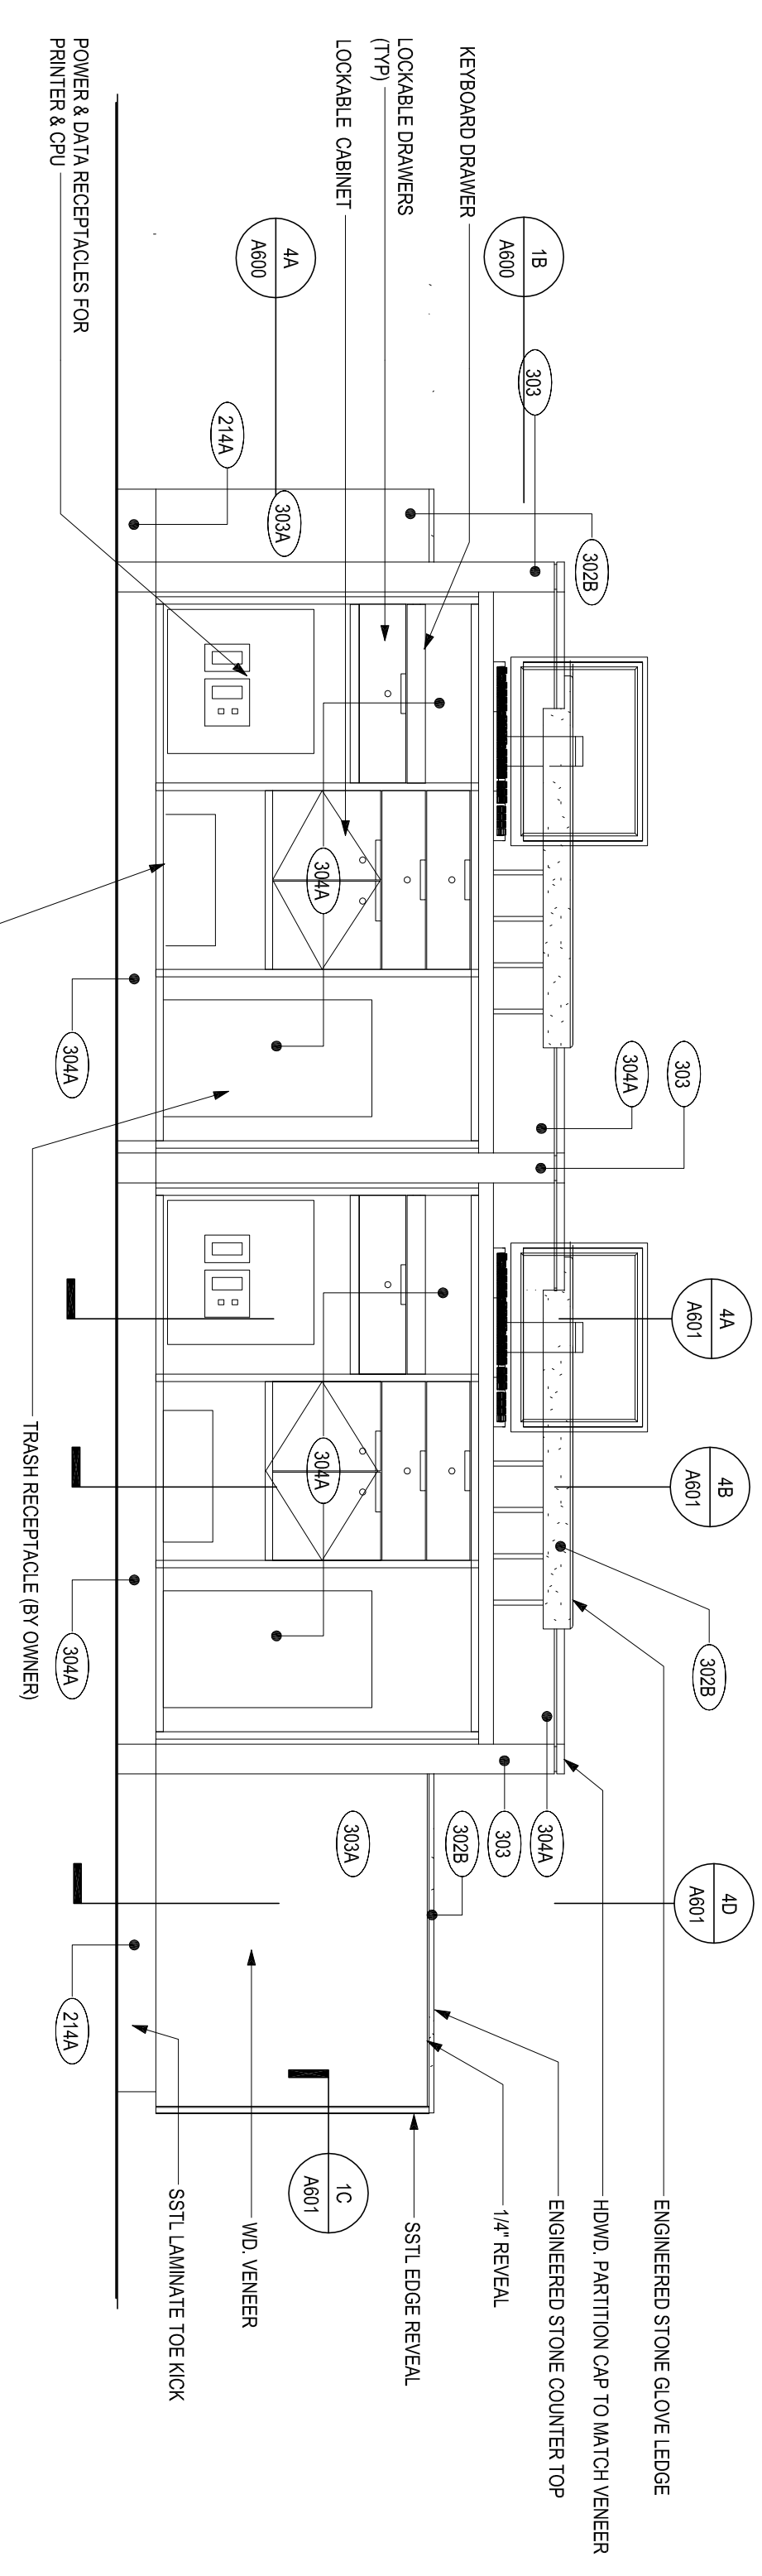


1C WELCOME DESK - WORK  
SCALE 3/4"=1'-0"

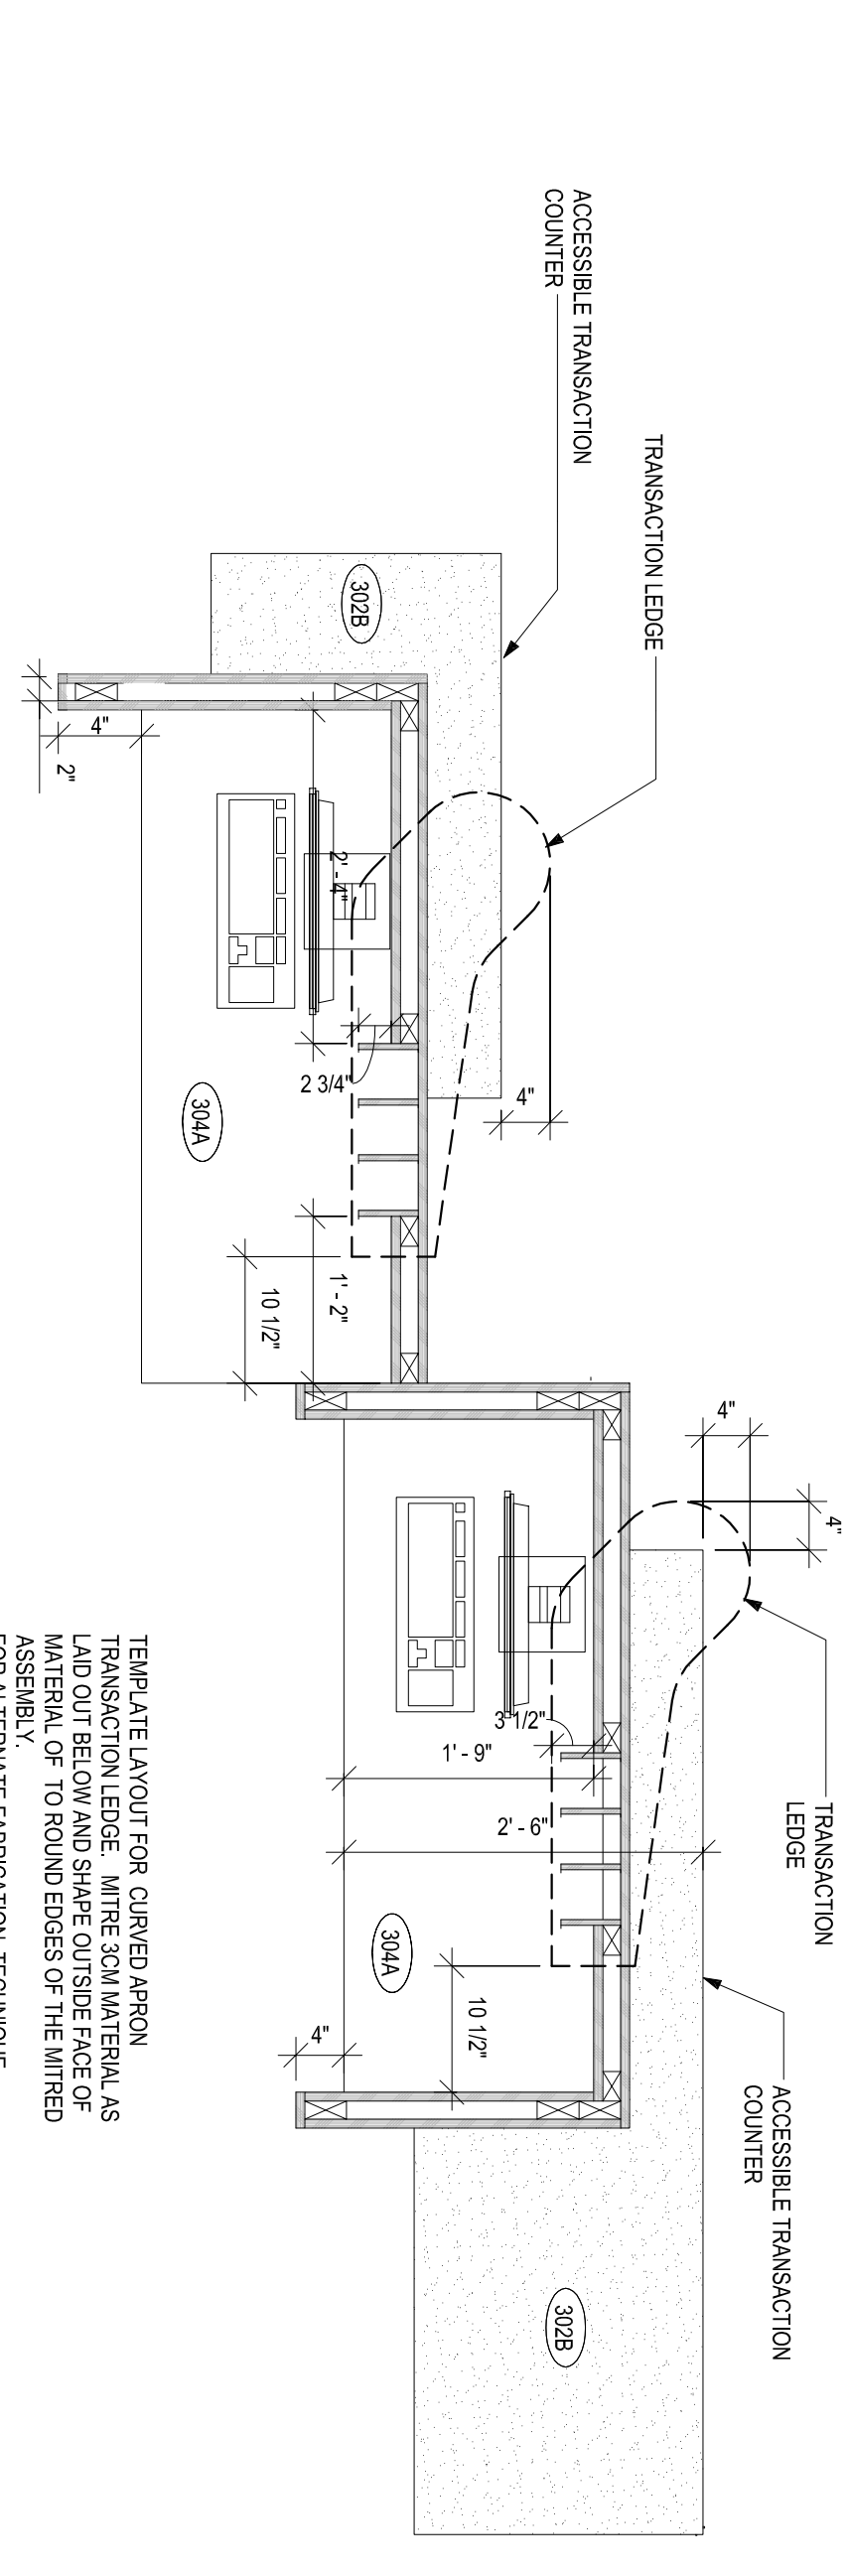


1B WELCOME DESK-TRANSACTION WALL - MIRROR  
SCALE 3/4"=1'-0"

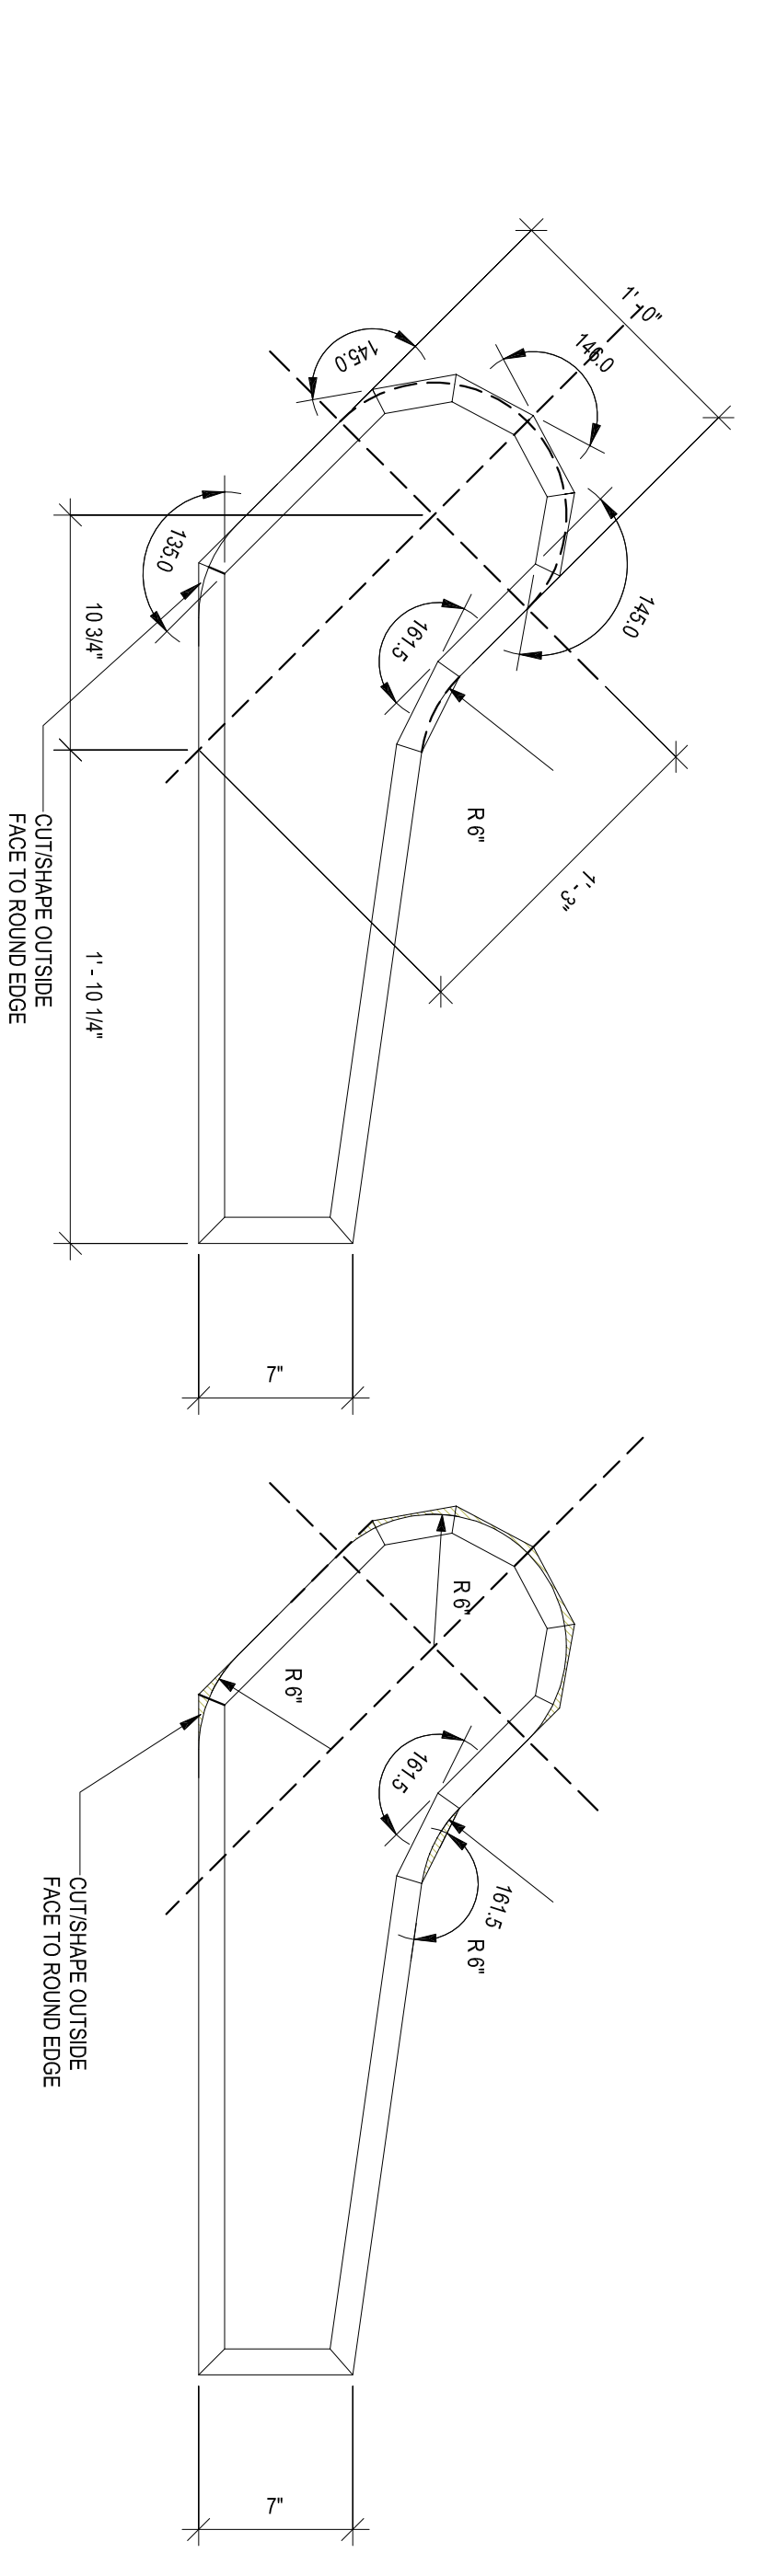


1A TRANSACTION LEDGE  
SCALE 1 1/2"=1'-0"

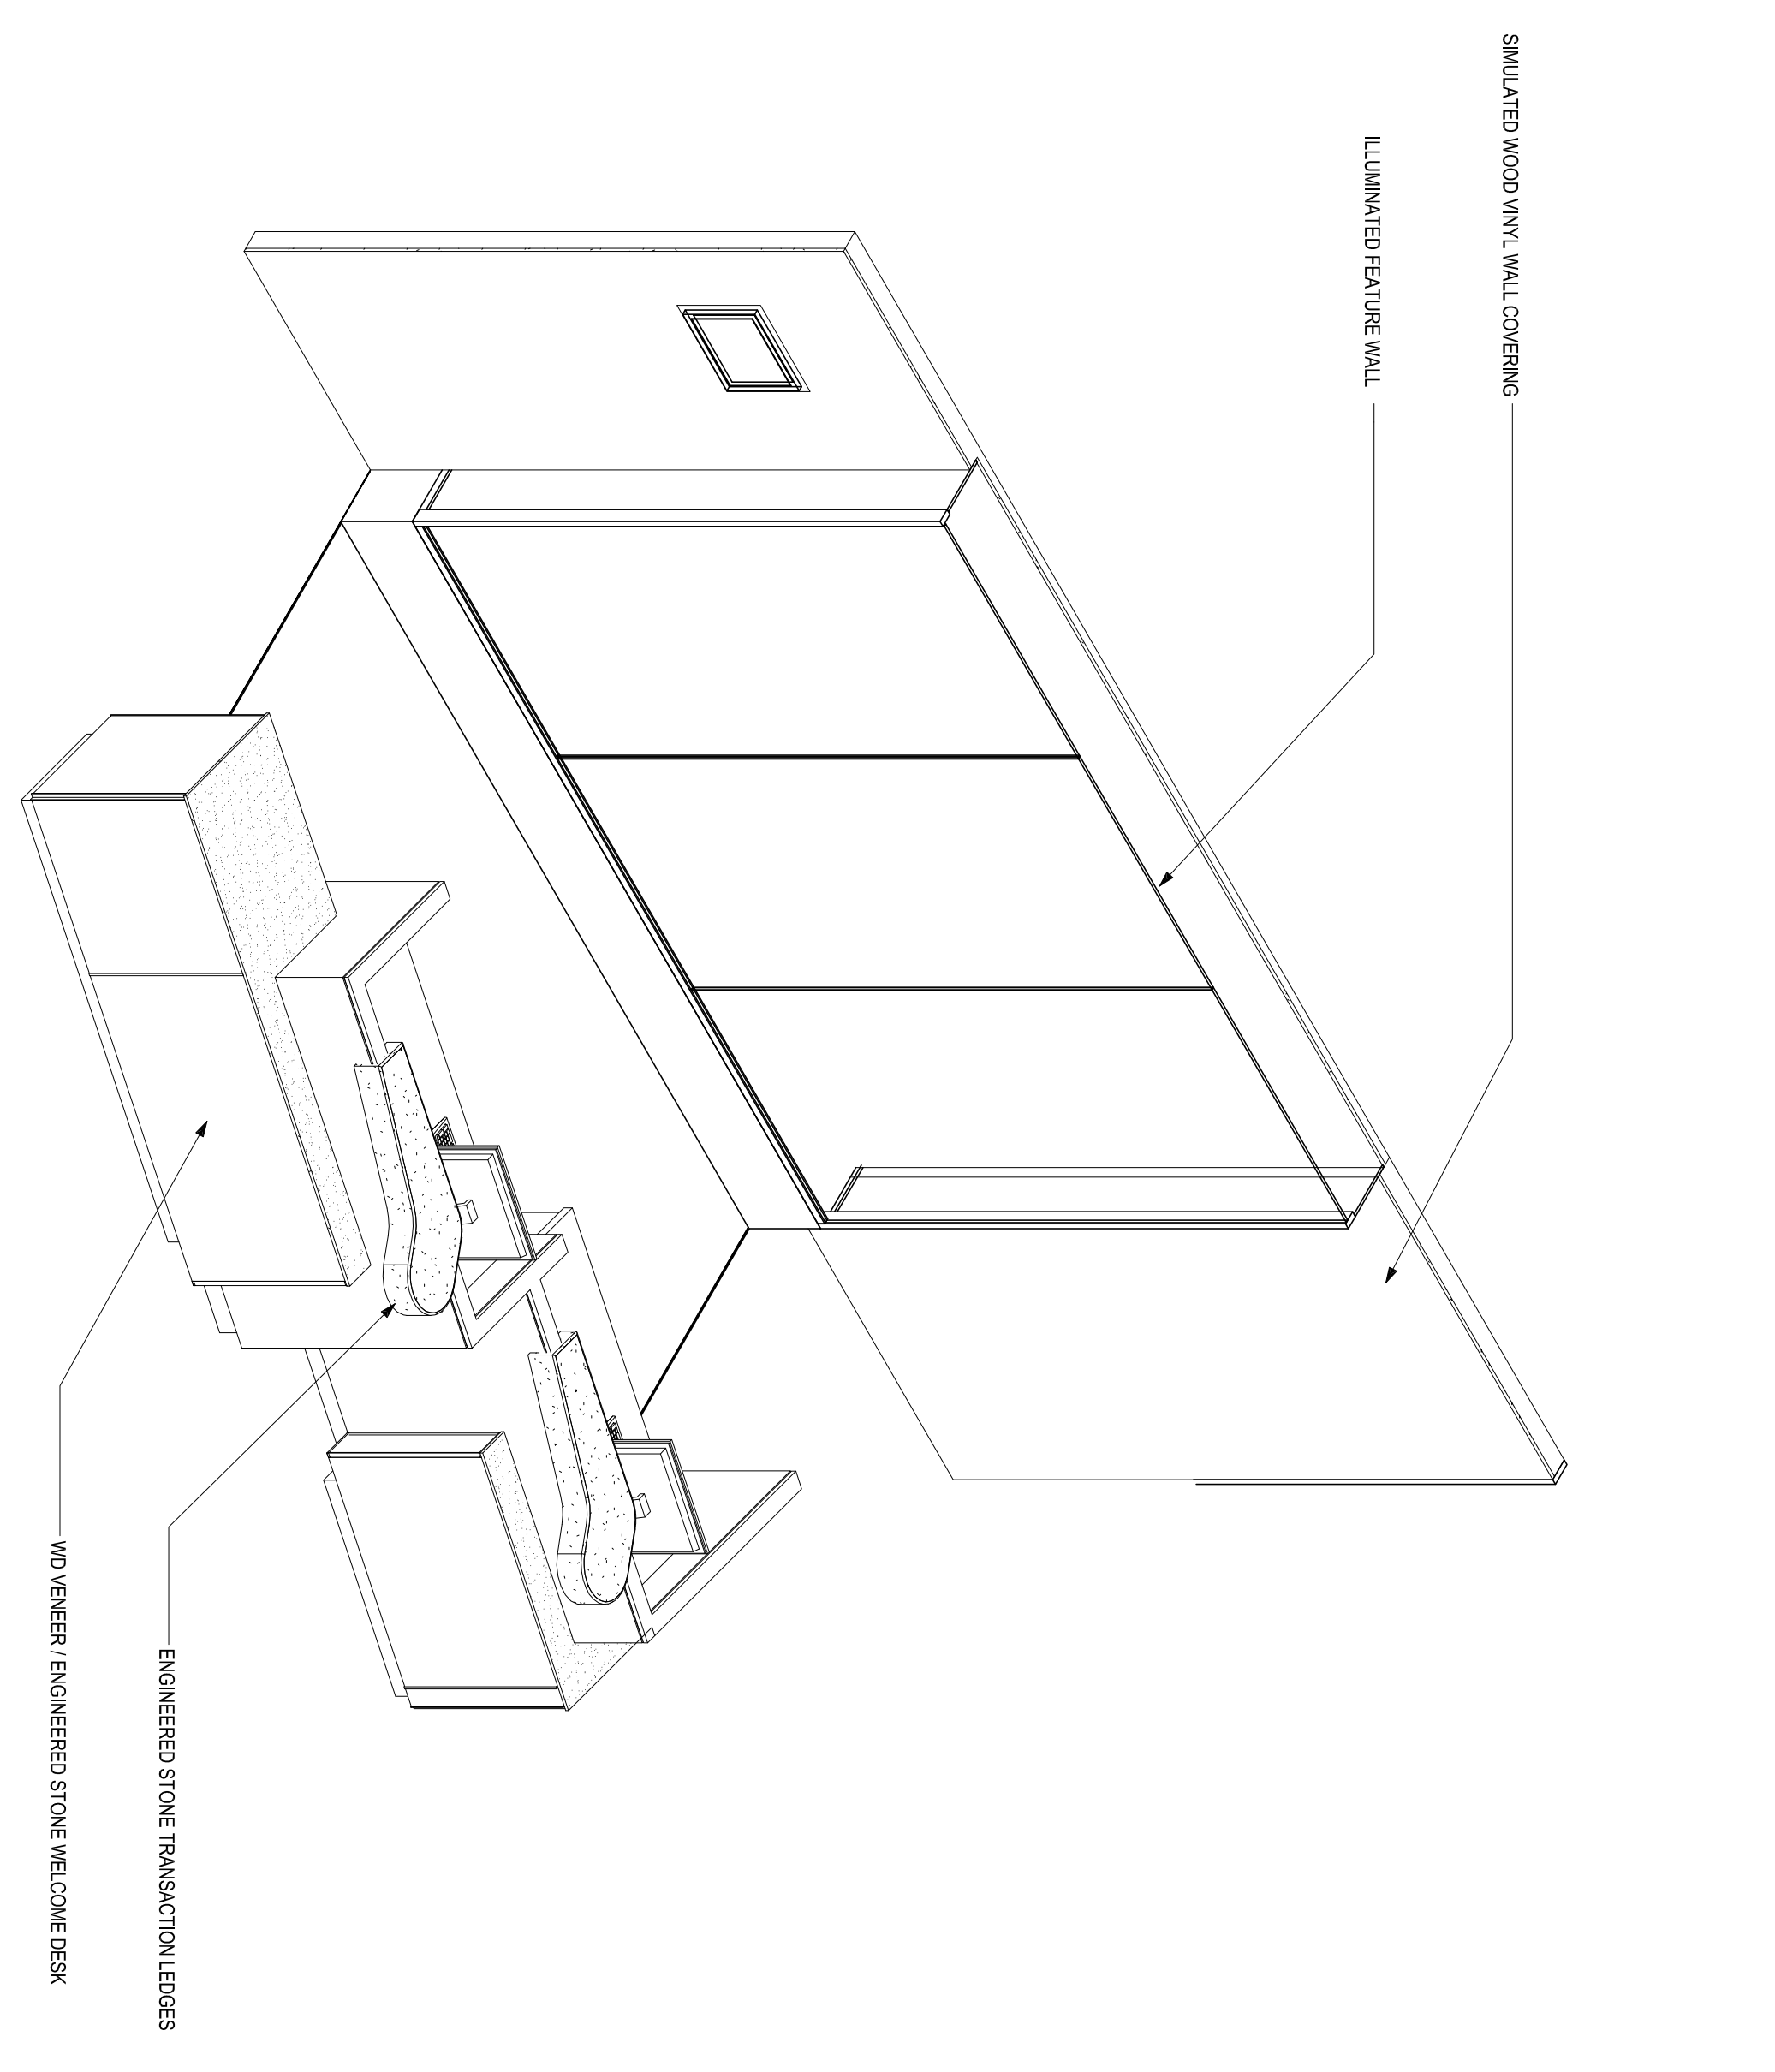


4C WELCOME DESK - 3D  
SCALE 3/4"=1'-0"

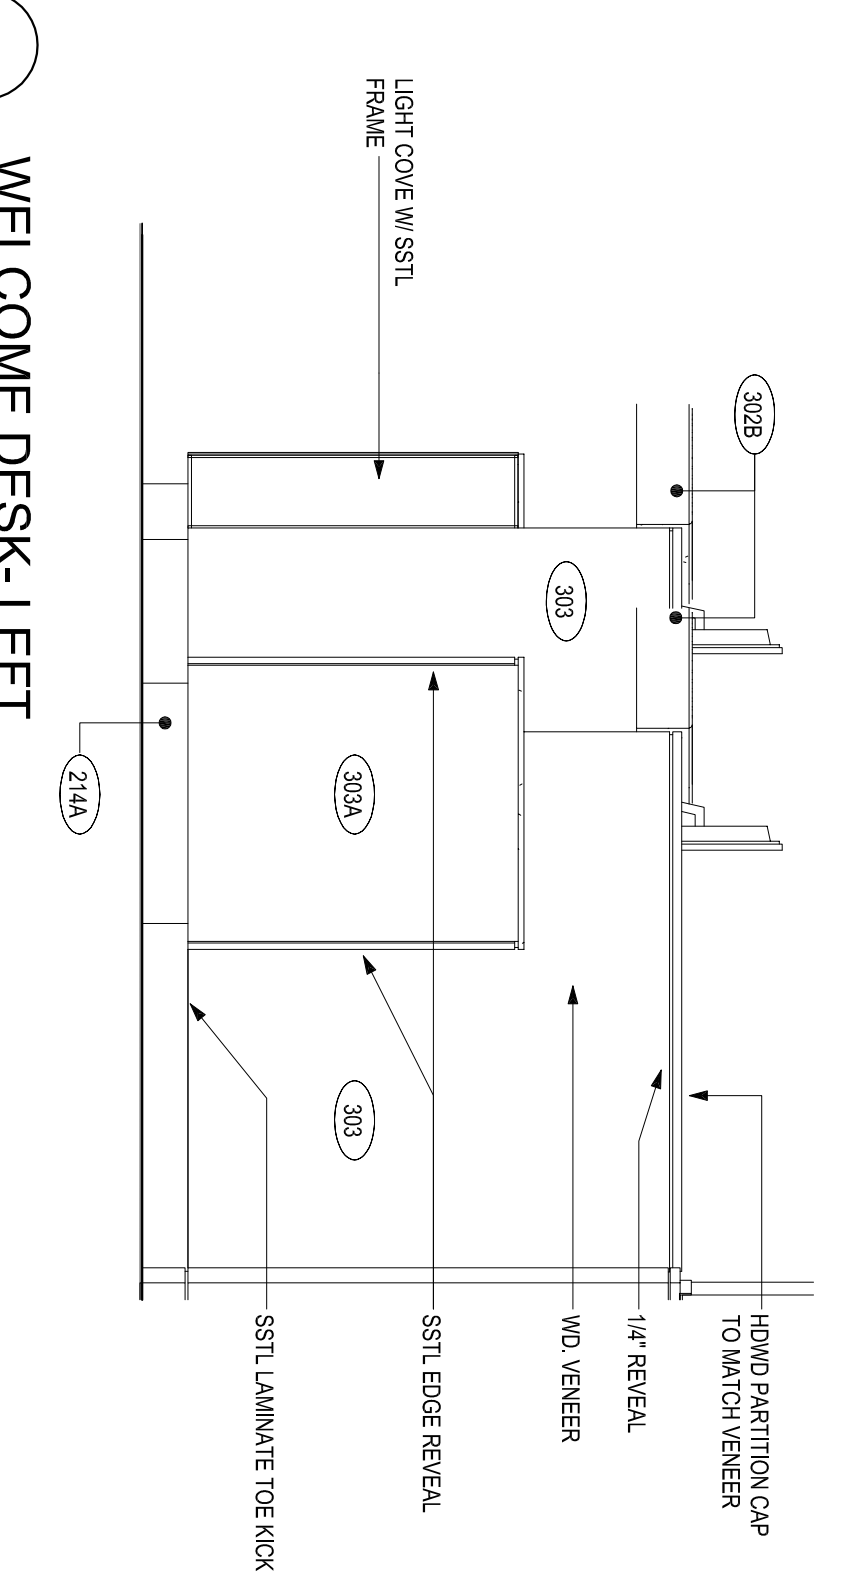

4B WELCOME DESK-LEFT  
SCALE 3/4"=1'-0"

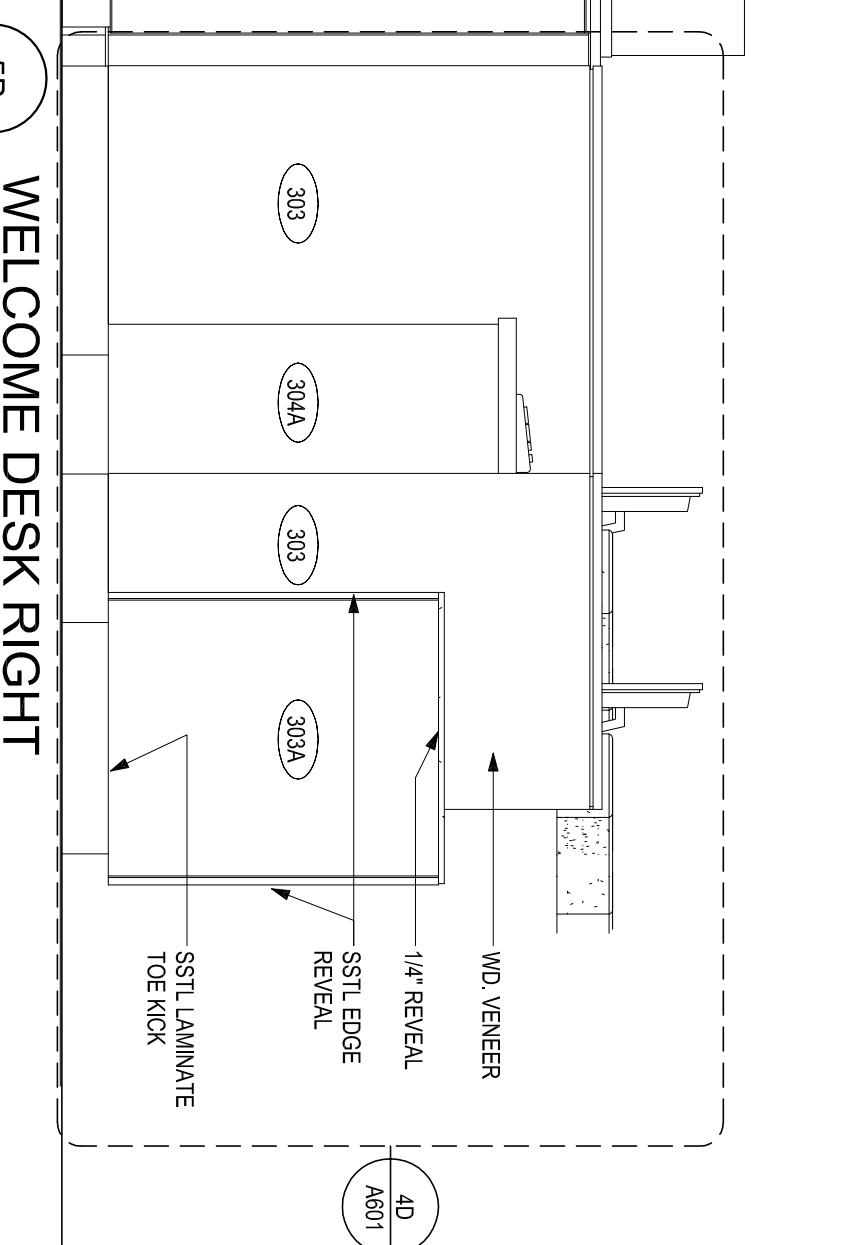

5B WELCOME DESK RIGHT  
SCALE 3/4"=1'-0"

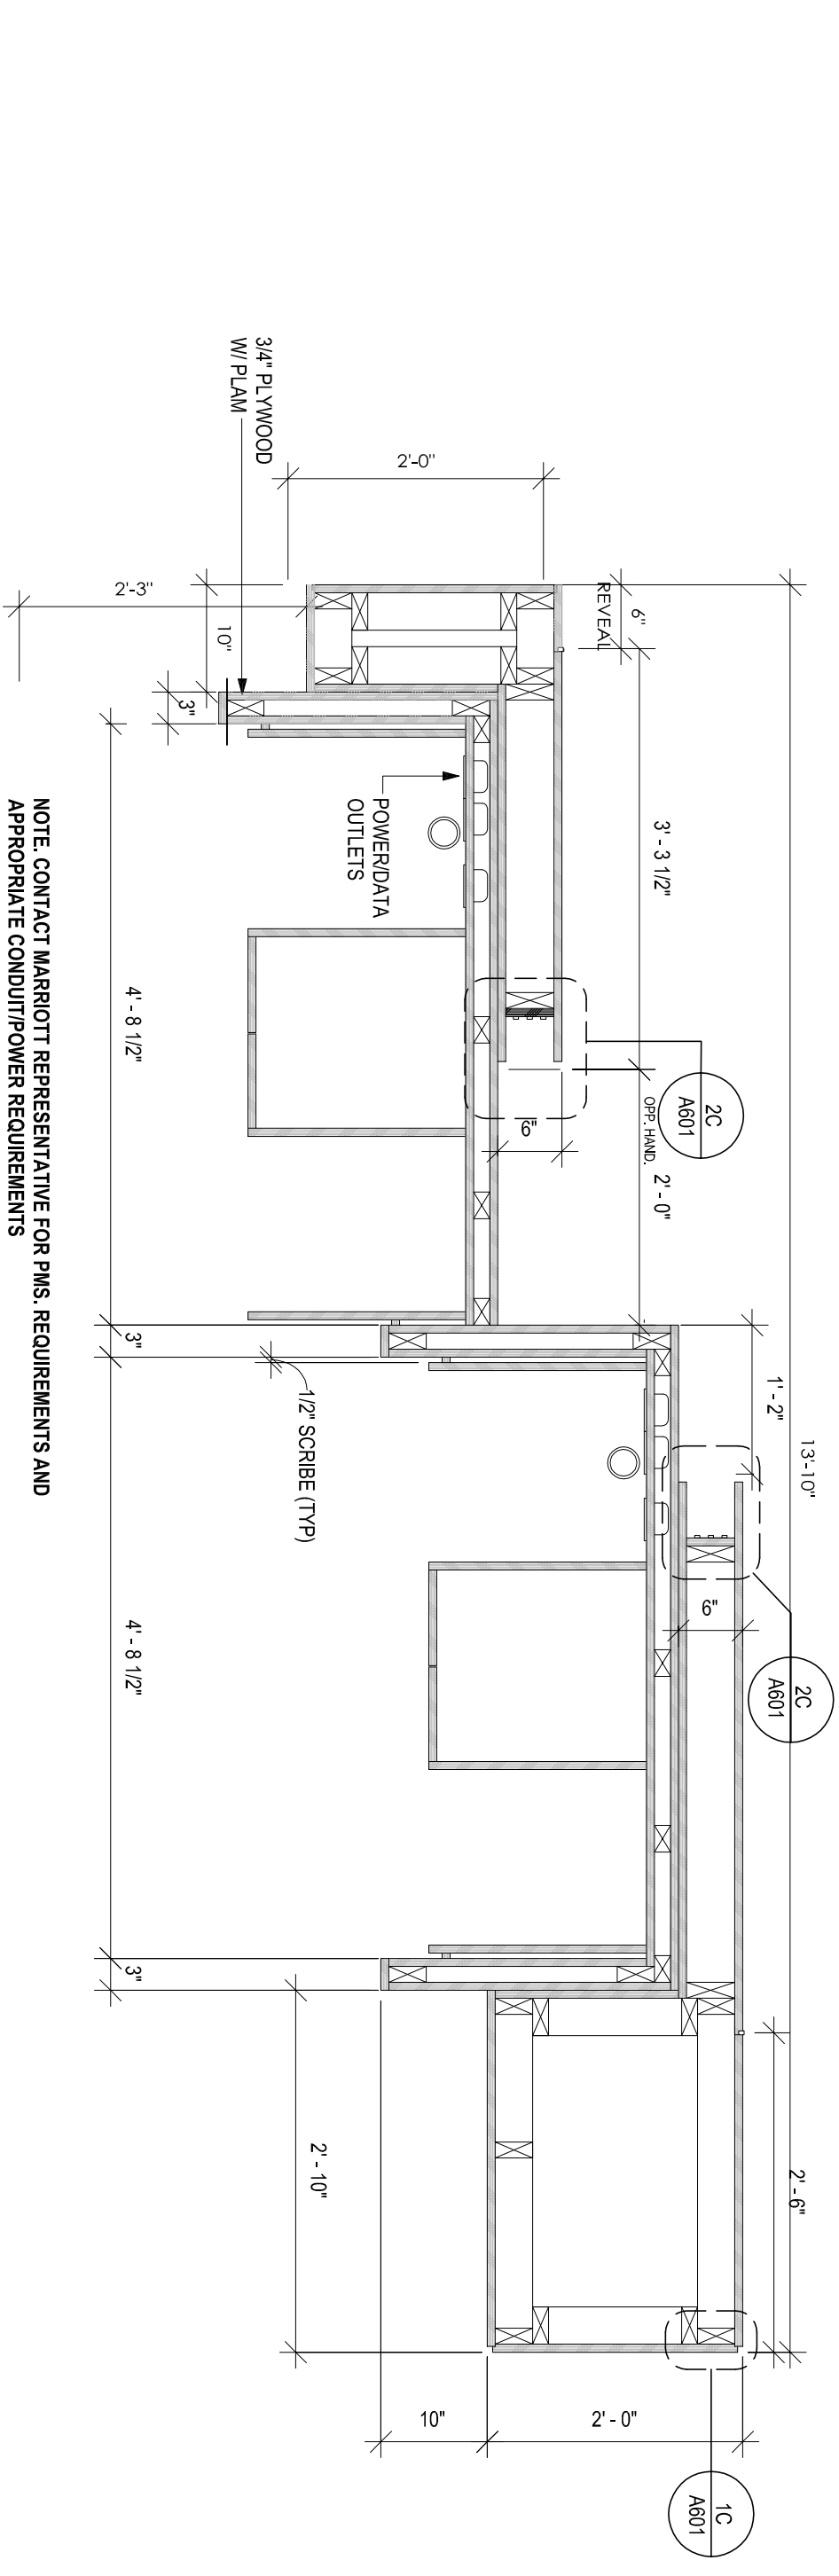


4A WELCOME DESK-CABINETS  
SCALE 3/4"=1'-0"

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SCALE: AS NOTED  
DRAWING NUMBER: A600


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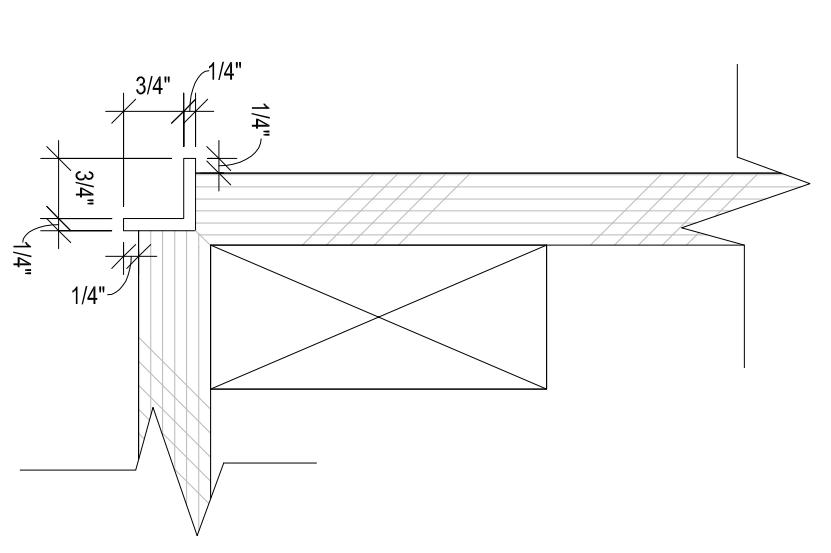
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PROJECT NUMBER: WELCOME DESK DETAILS


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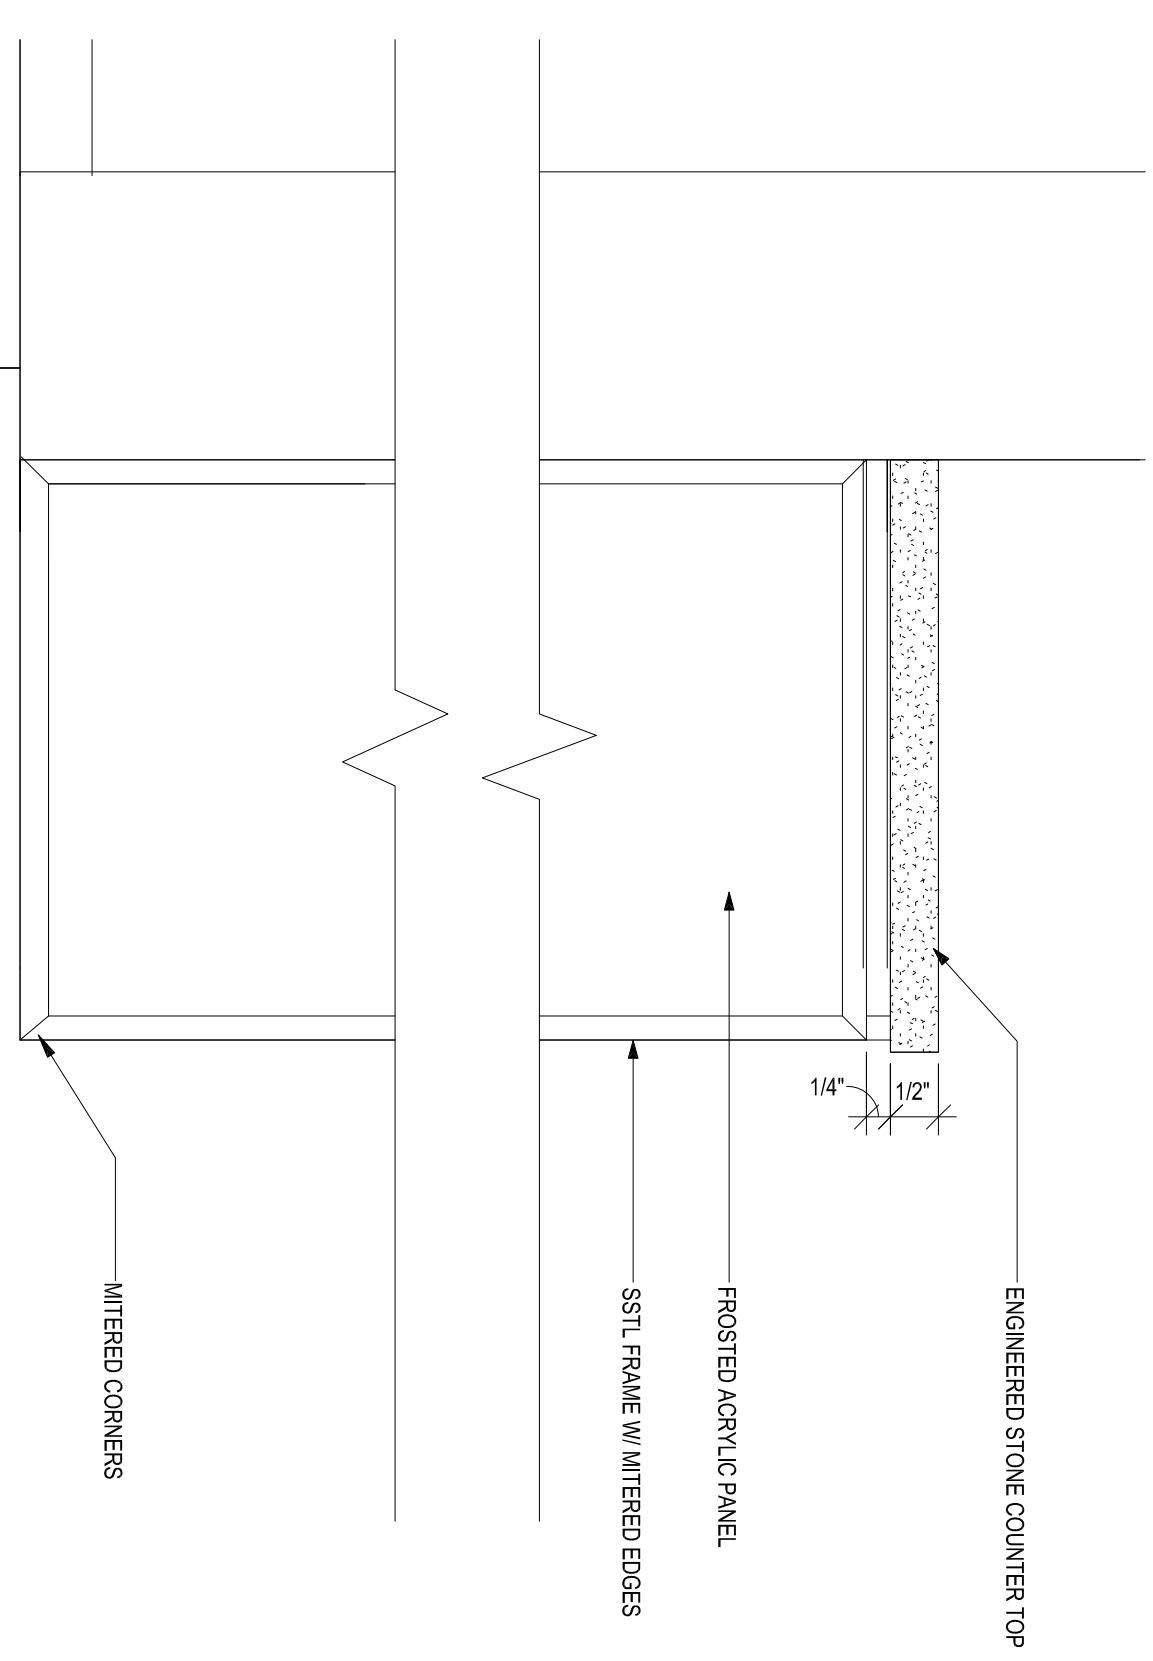
2D WELCOME DESK-TRASH CABINET  
SCALE 1 1/2\"/>

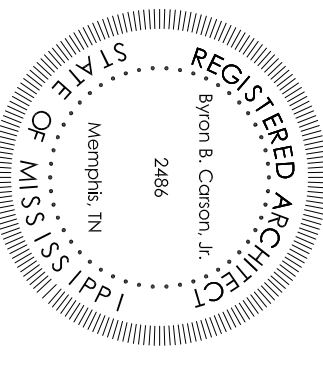


1C SSTL TRIM DETAIL  
SCALE 6\"/>

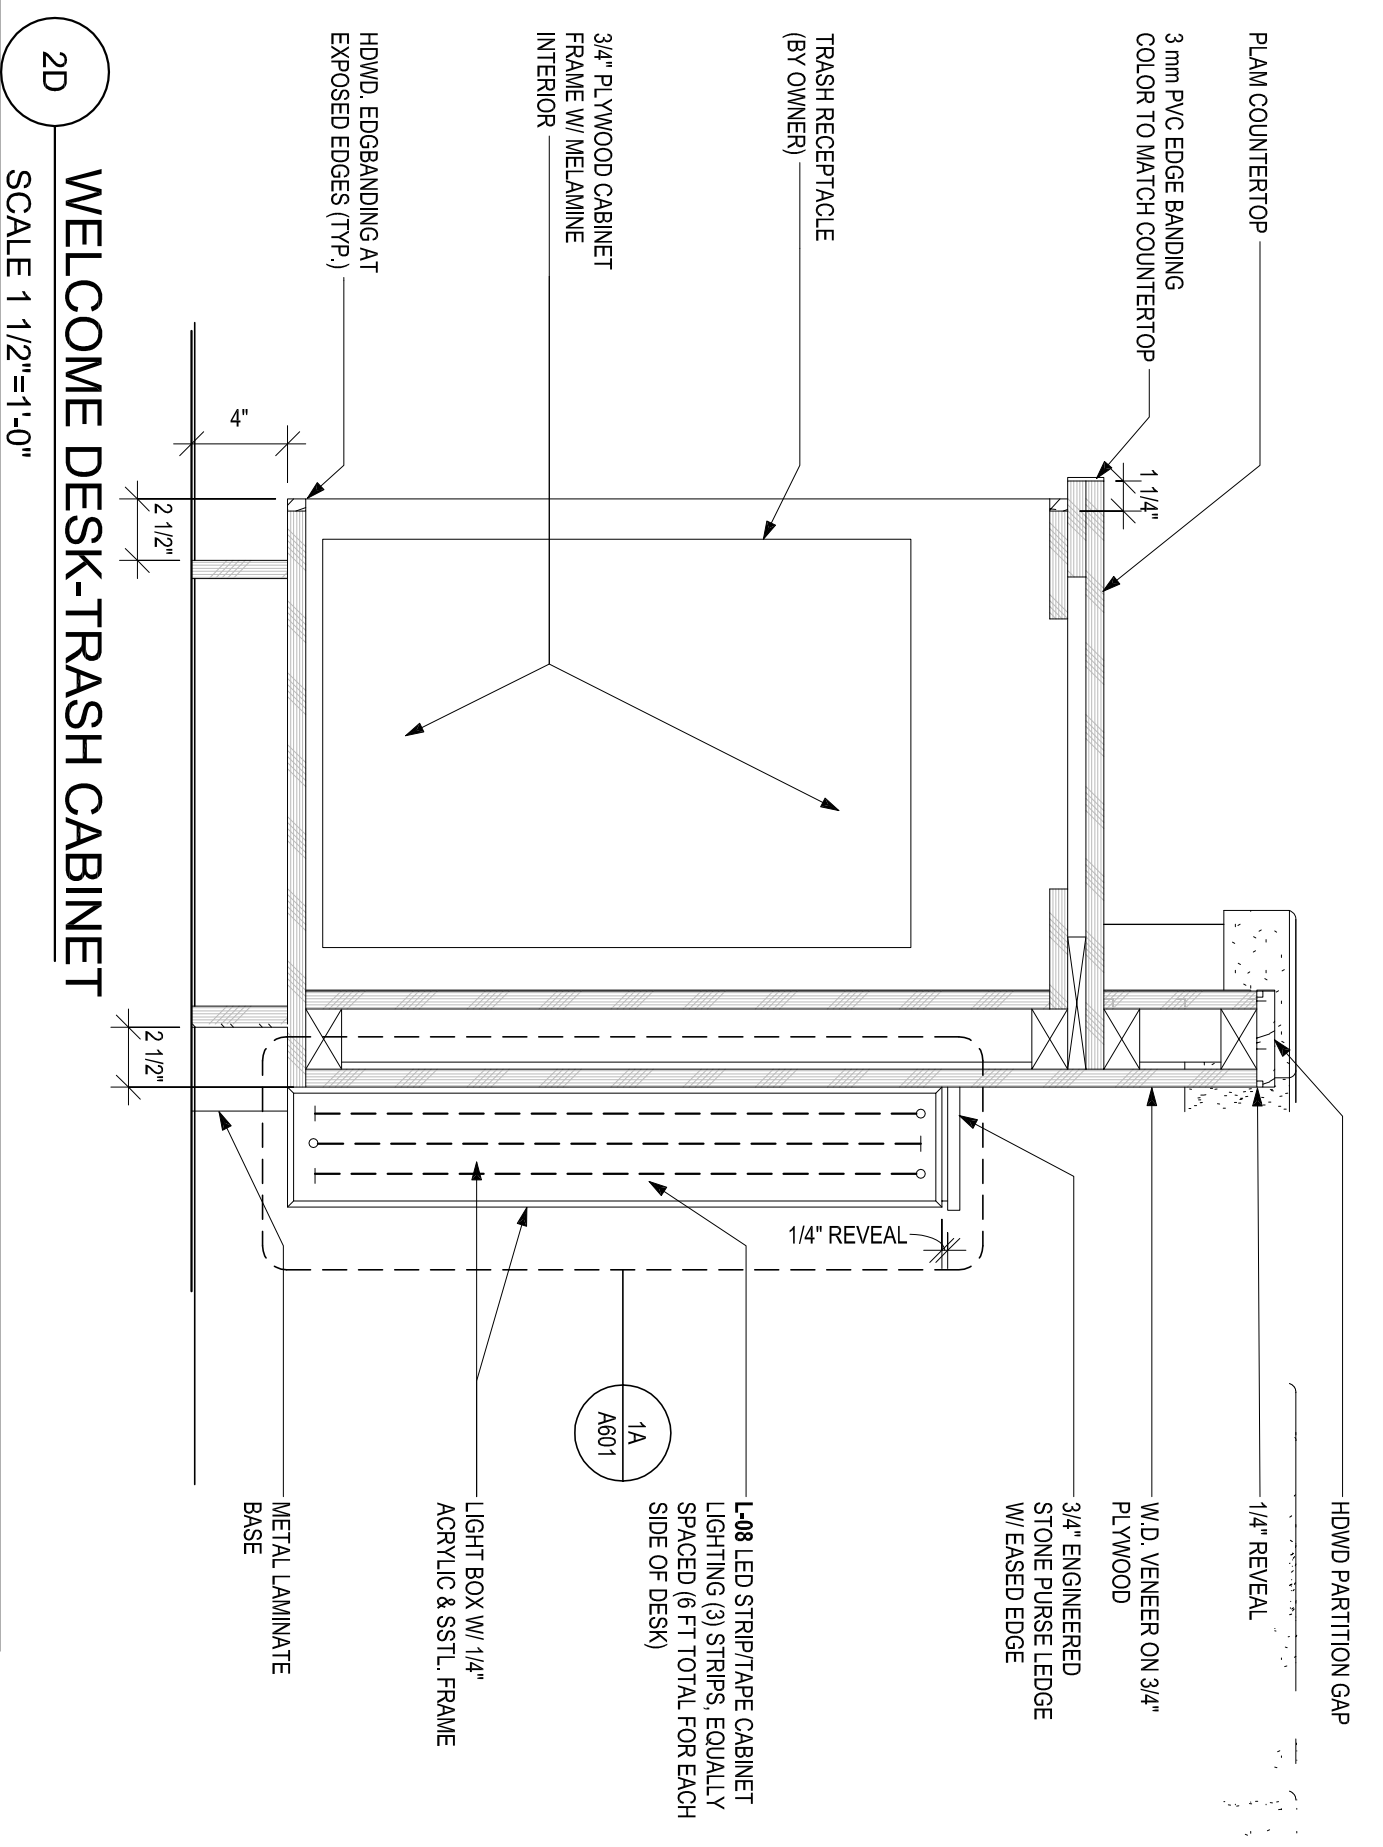


2C COVER LIGHT DETAIL  
SCALE 6\"/>

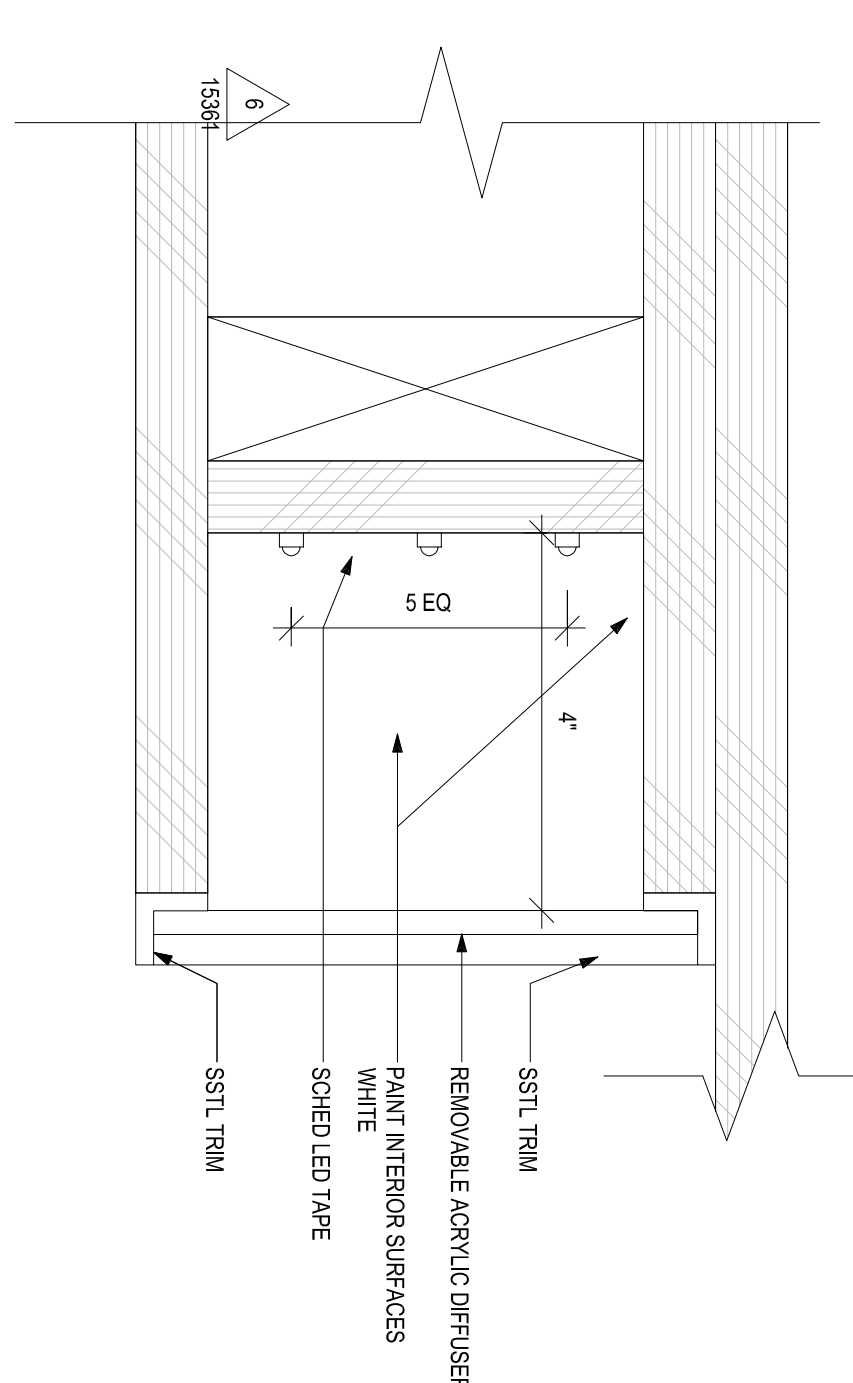


1A COVER LIGHT DETAIL-ELEVATION  
SCALE 6\"/>

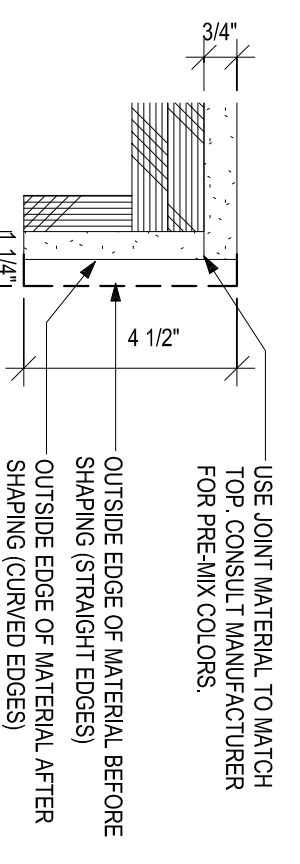


3A TRANSACTION LEDGE  
SCALE 3\"/>

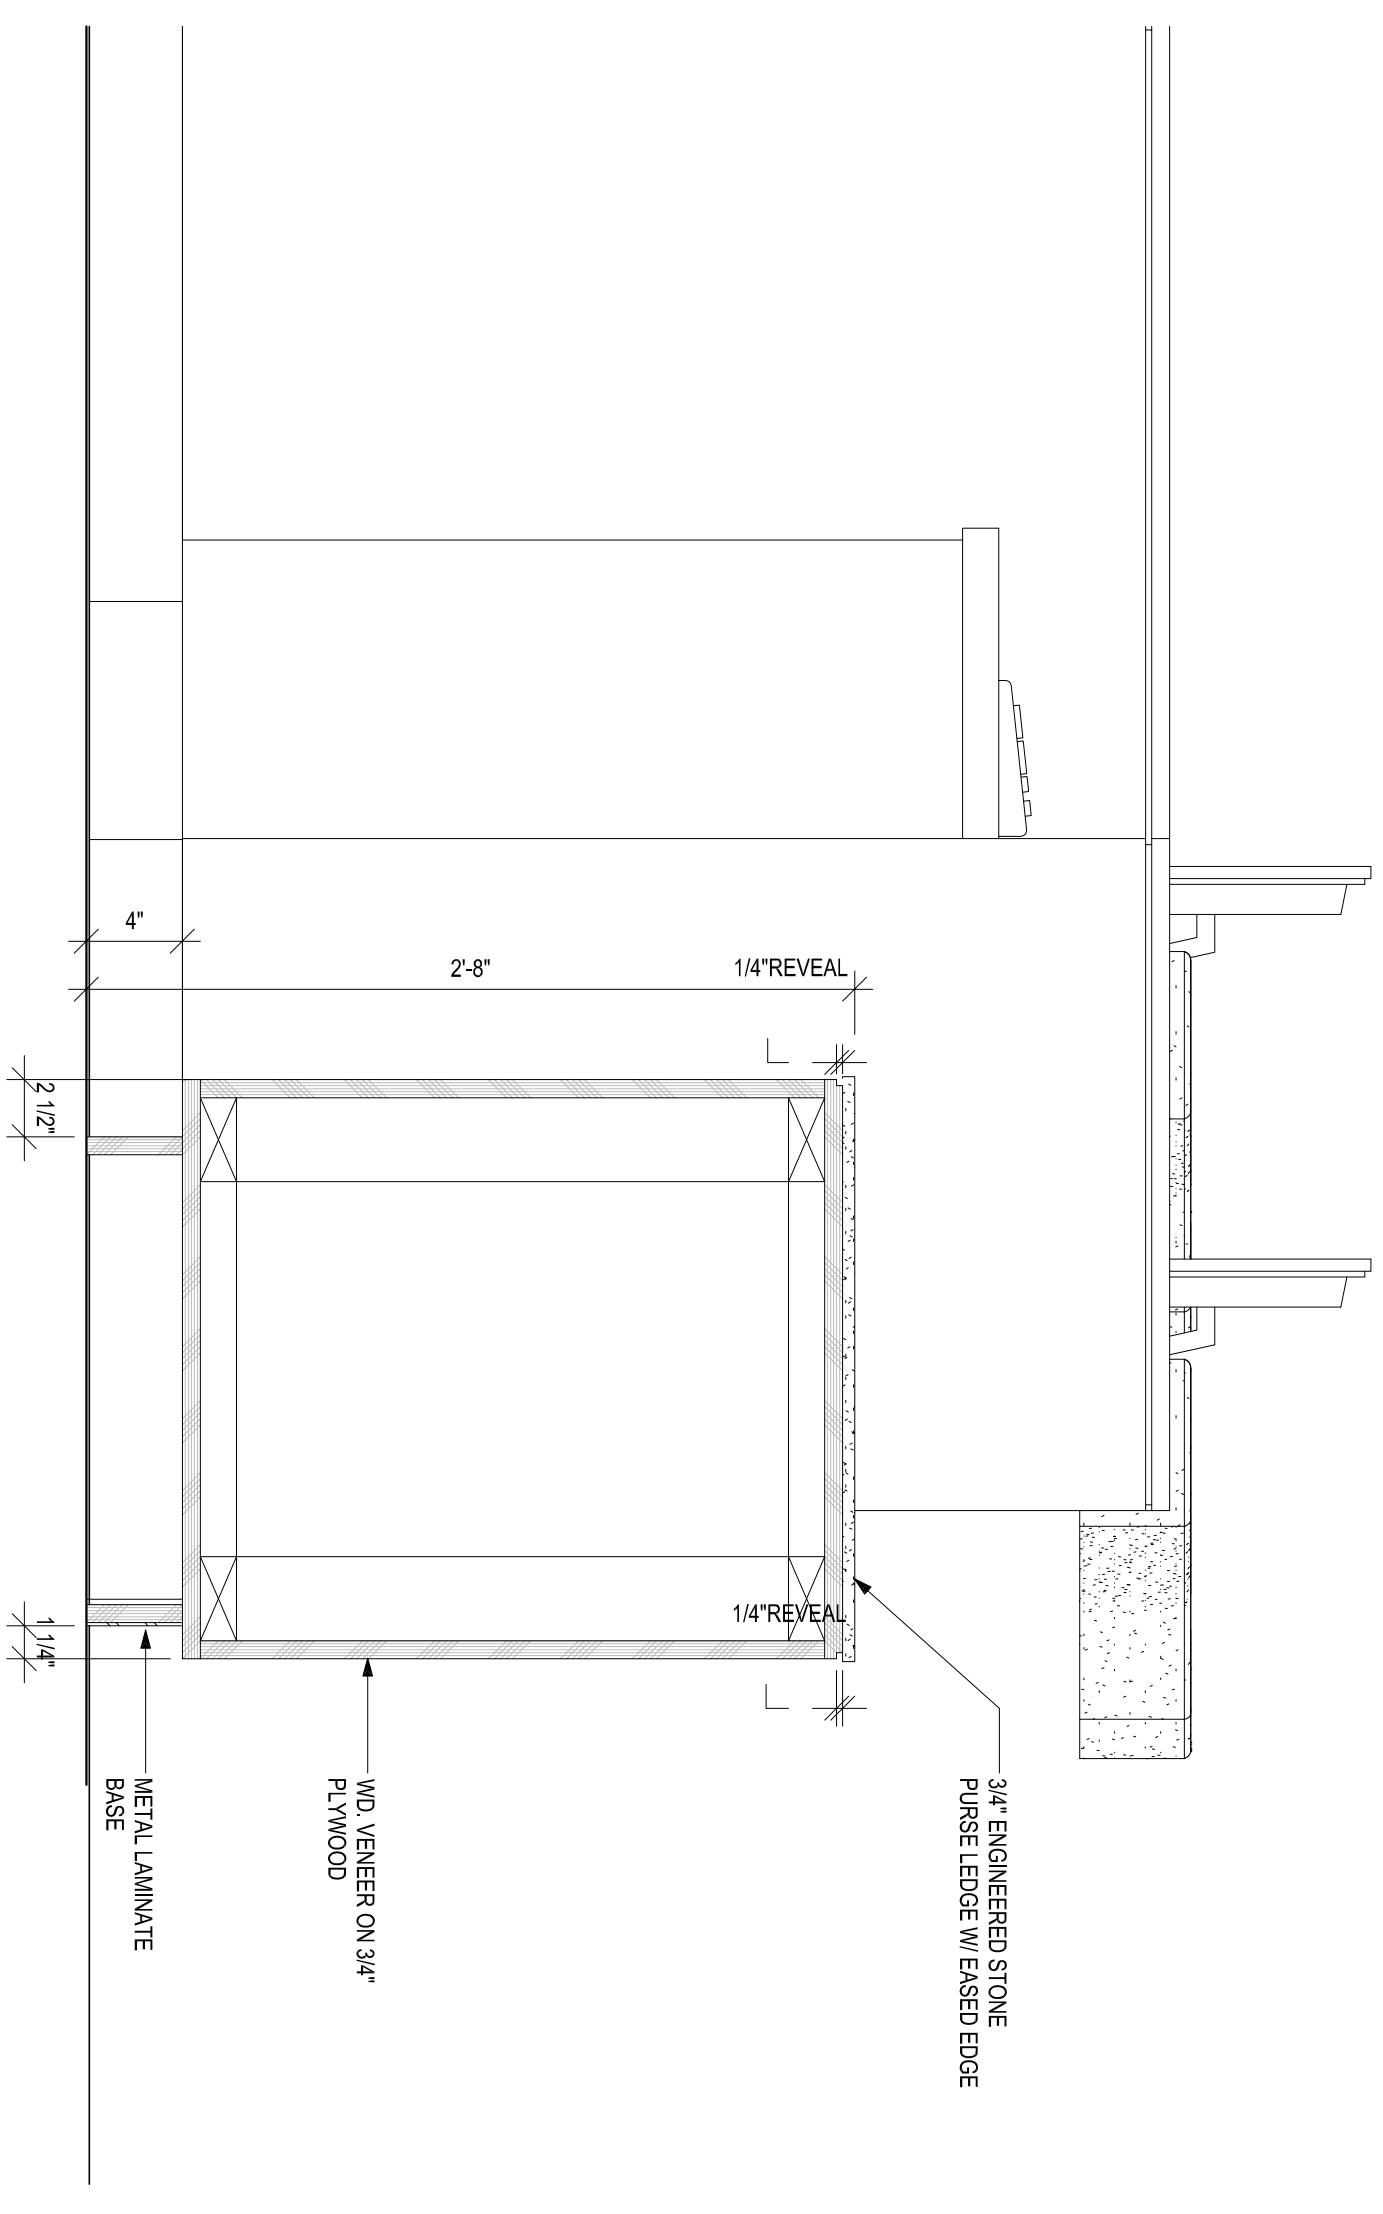

4D WELCOME DESK-ADA TRANSACTION SURFACE  
SCALE 1 1/2\"/>

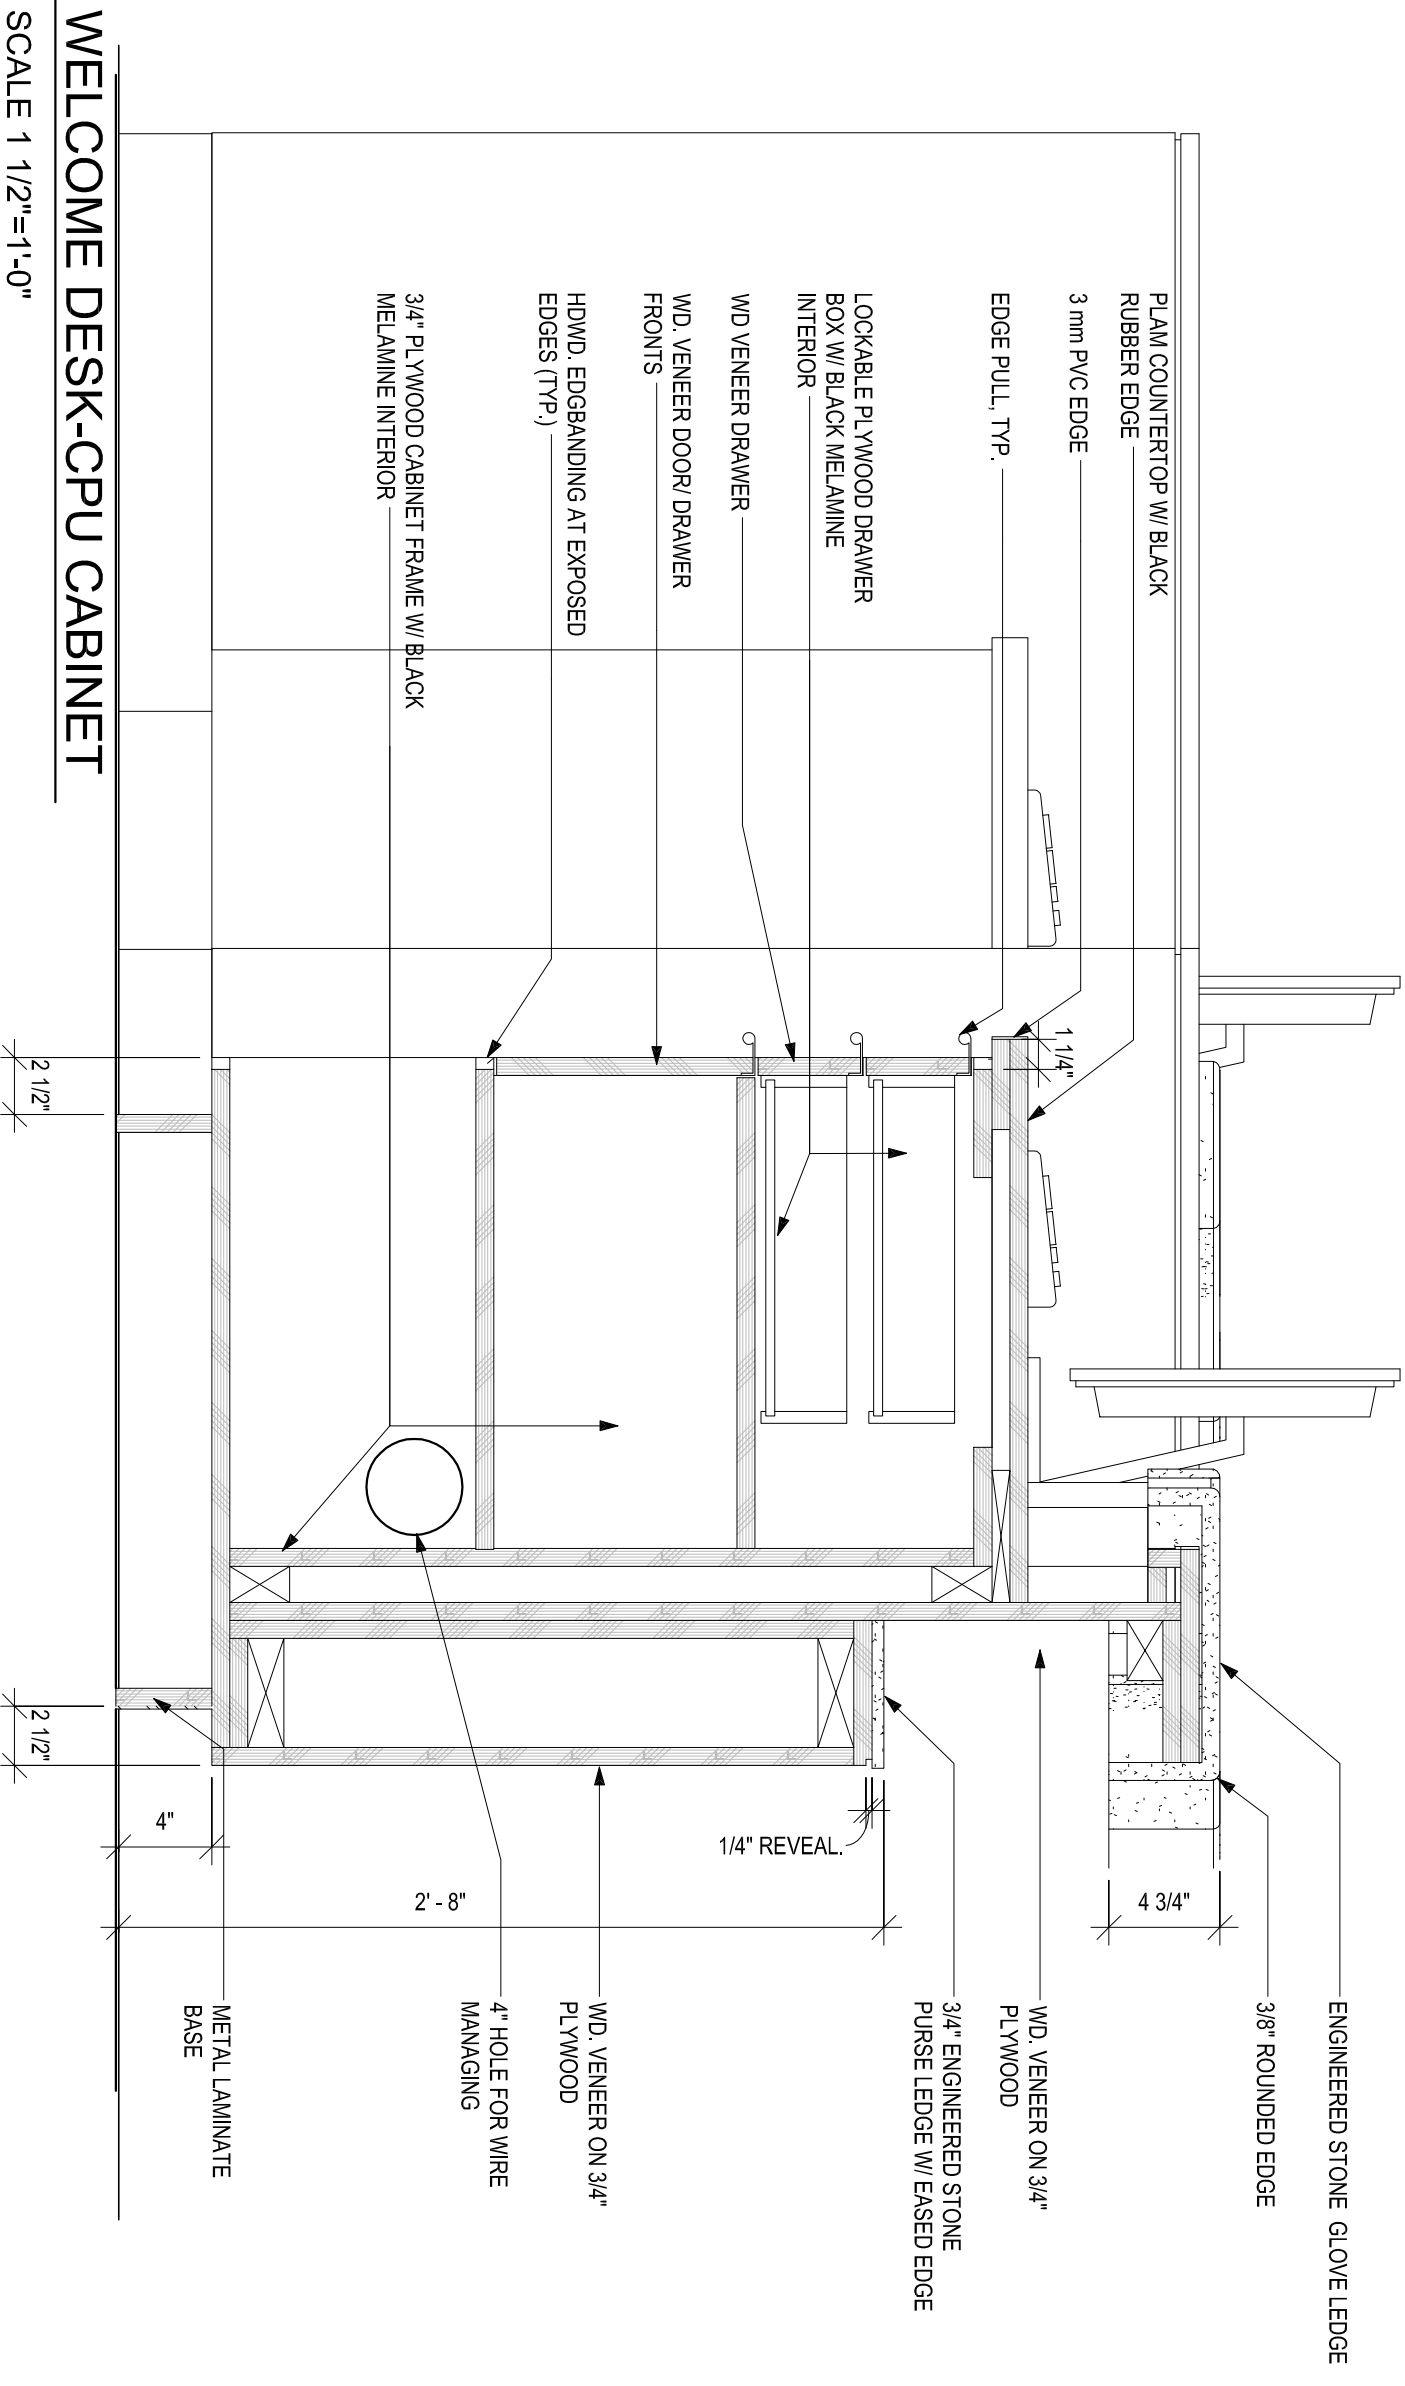

4B WELCOME DESK-CPU CABINET  
SCALE 1 1/2\"/>

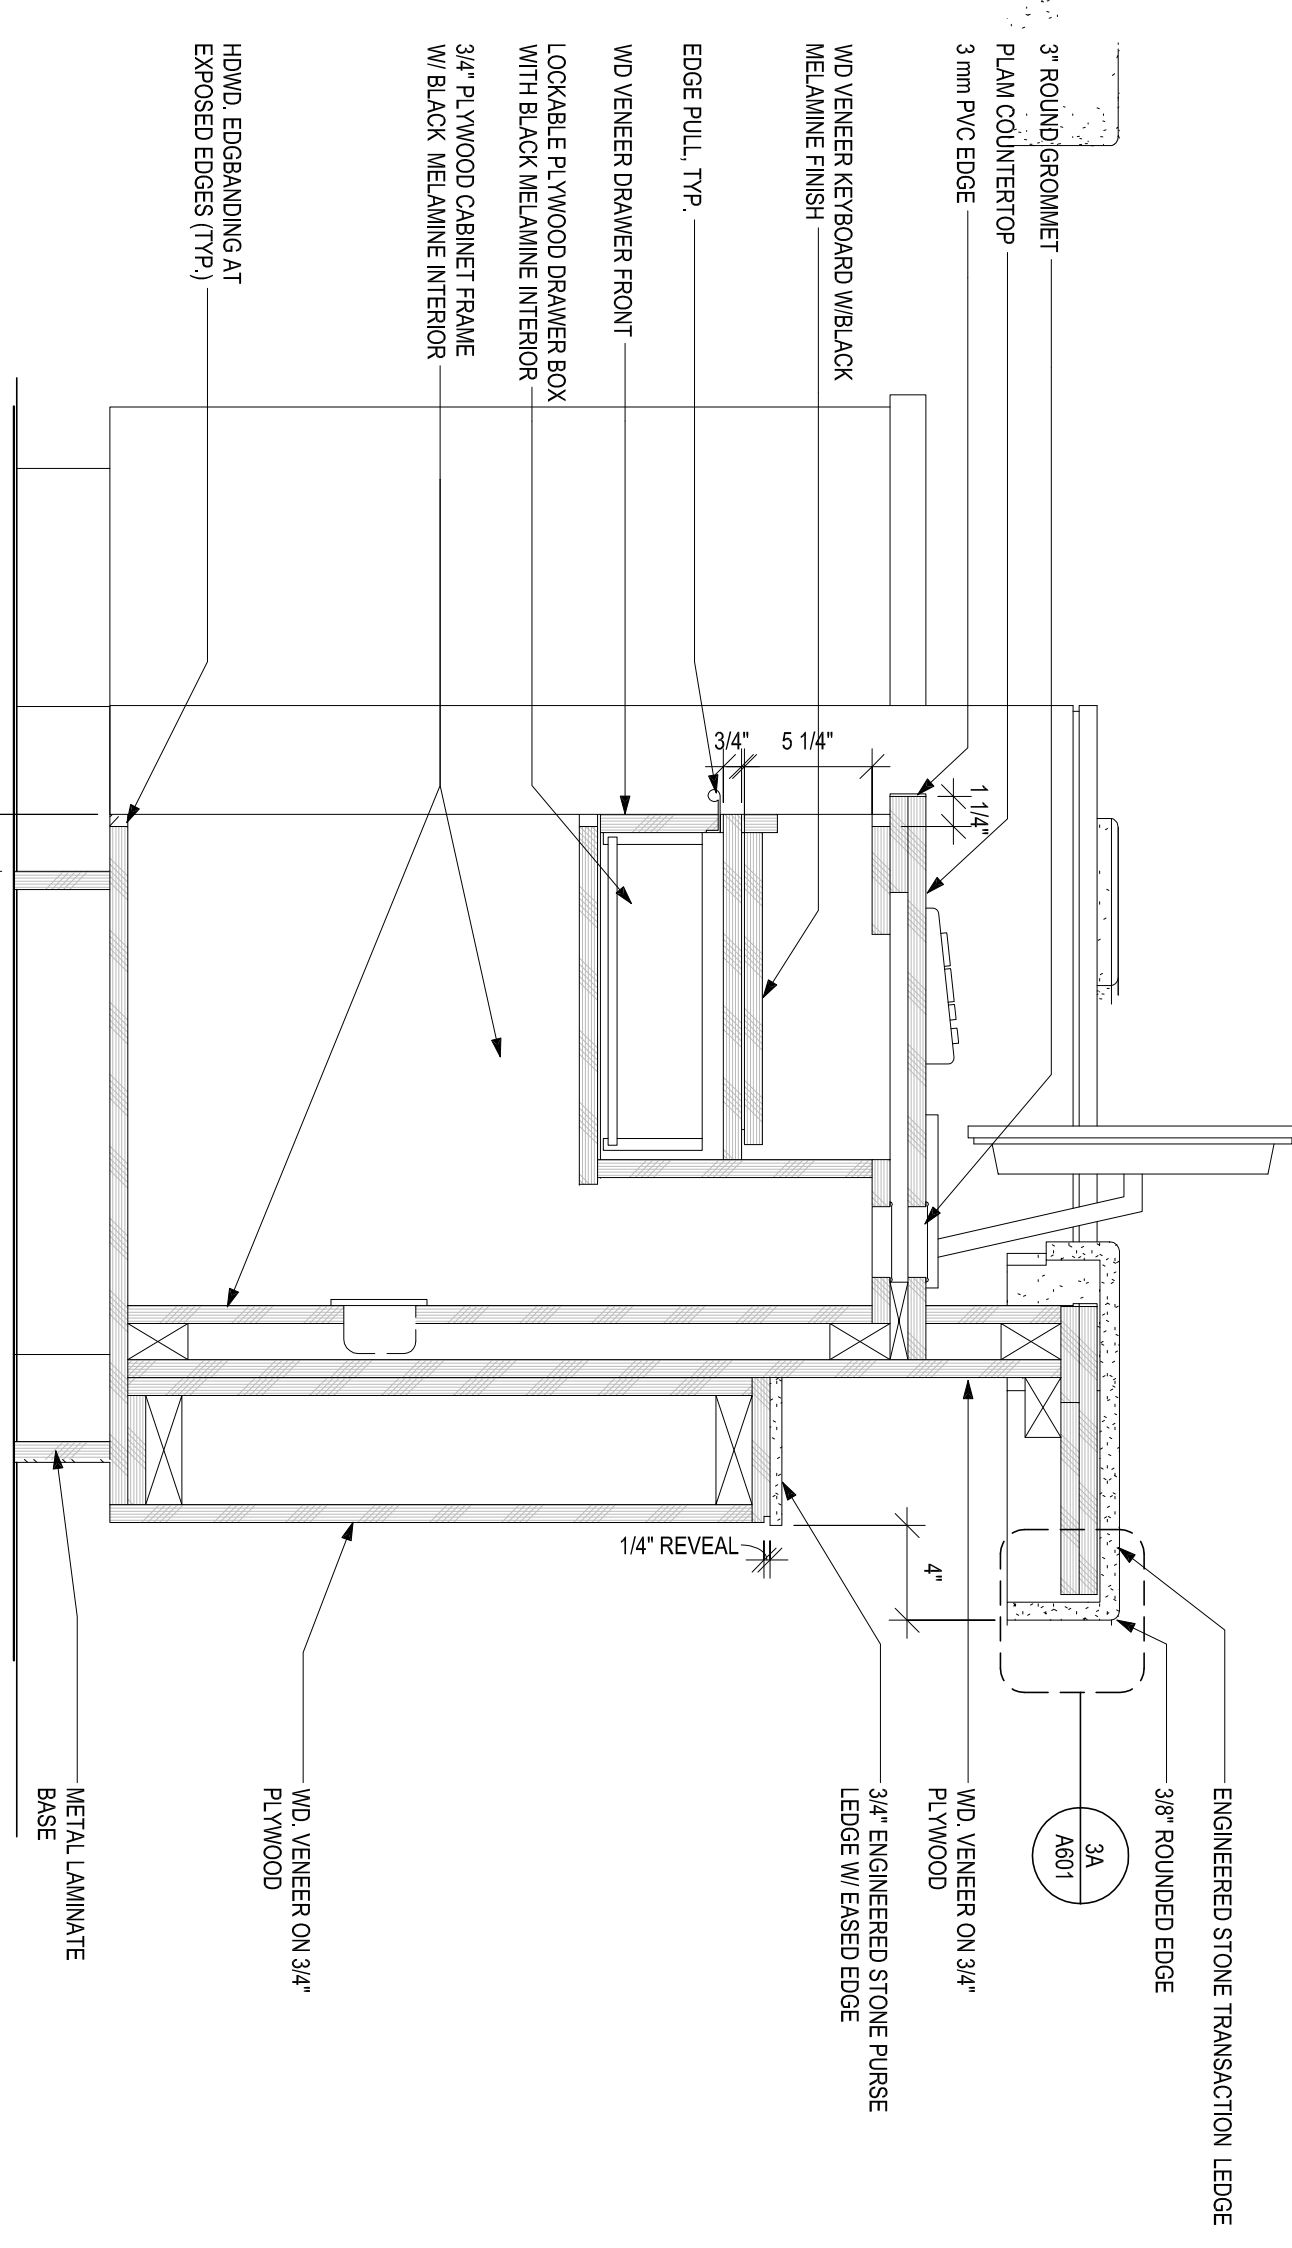


4A WELCOME DESK-KEYBOARD & PRINTER CABINET  
SCALE 1 1/2\"/>

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PROJECT NUMBER:  
DRAWING NAME:  
SHEET NAME:  
WELCOME DESK DETAILS


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**A601**


CONTRACT SECURITY MONITOR INFORMATION / DIMENSIONS CONTACT:  
 NATIONAL ACCOUNT MANAGER  
 ADAM BURAWSKI (CURRENTLY OUT ON LEAVE OF ABSENCE)  
 MAIN POINT OF CONTACT  
 NATIONAL ACCOUNT MANAGER  
 ADAM BURAWSKI (CURRENTLY OUT ON LEAVE OF ABSENCE)  
 SUITE 24  
 18 BOULDER CIRCLE  
 NEW CASTLE, DE 19720

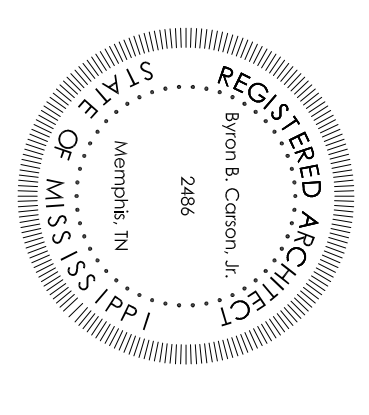SECONDARY POINT OF CONTACT  
 NATIONAL ACCOUNT MANAGER  
 BERNADETTE O'CONNOR (COVERING FOR THE NATIONAL ACCOUNT MANAGER)  
 PHONE: 219.817.2882  
 EMAIL: BFRARRELL@TFCO.COM

INSTALLATION POINT OF CONTACT  
 NICHOLE GRAY  
 PHONE: (800) 453-2247 EXT 2227  
 EMAIL: NGRAY@TFCO.COM

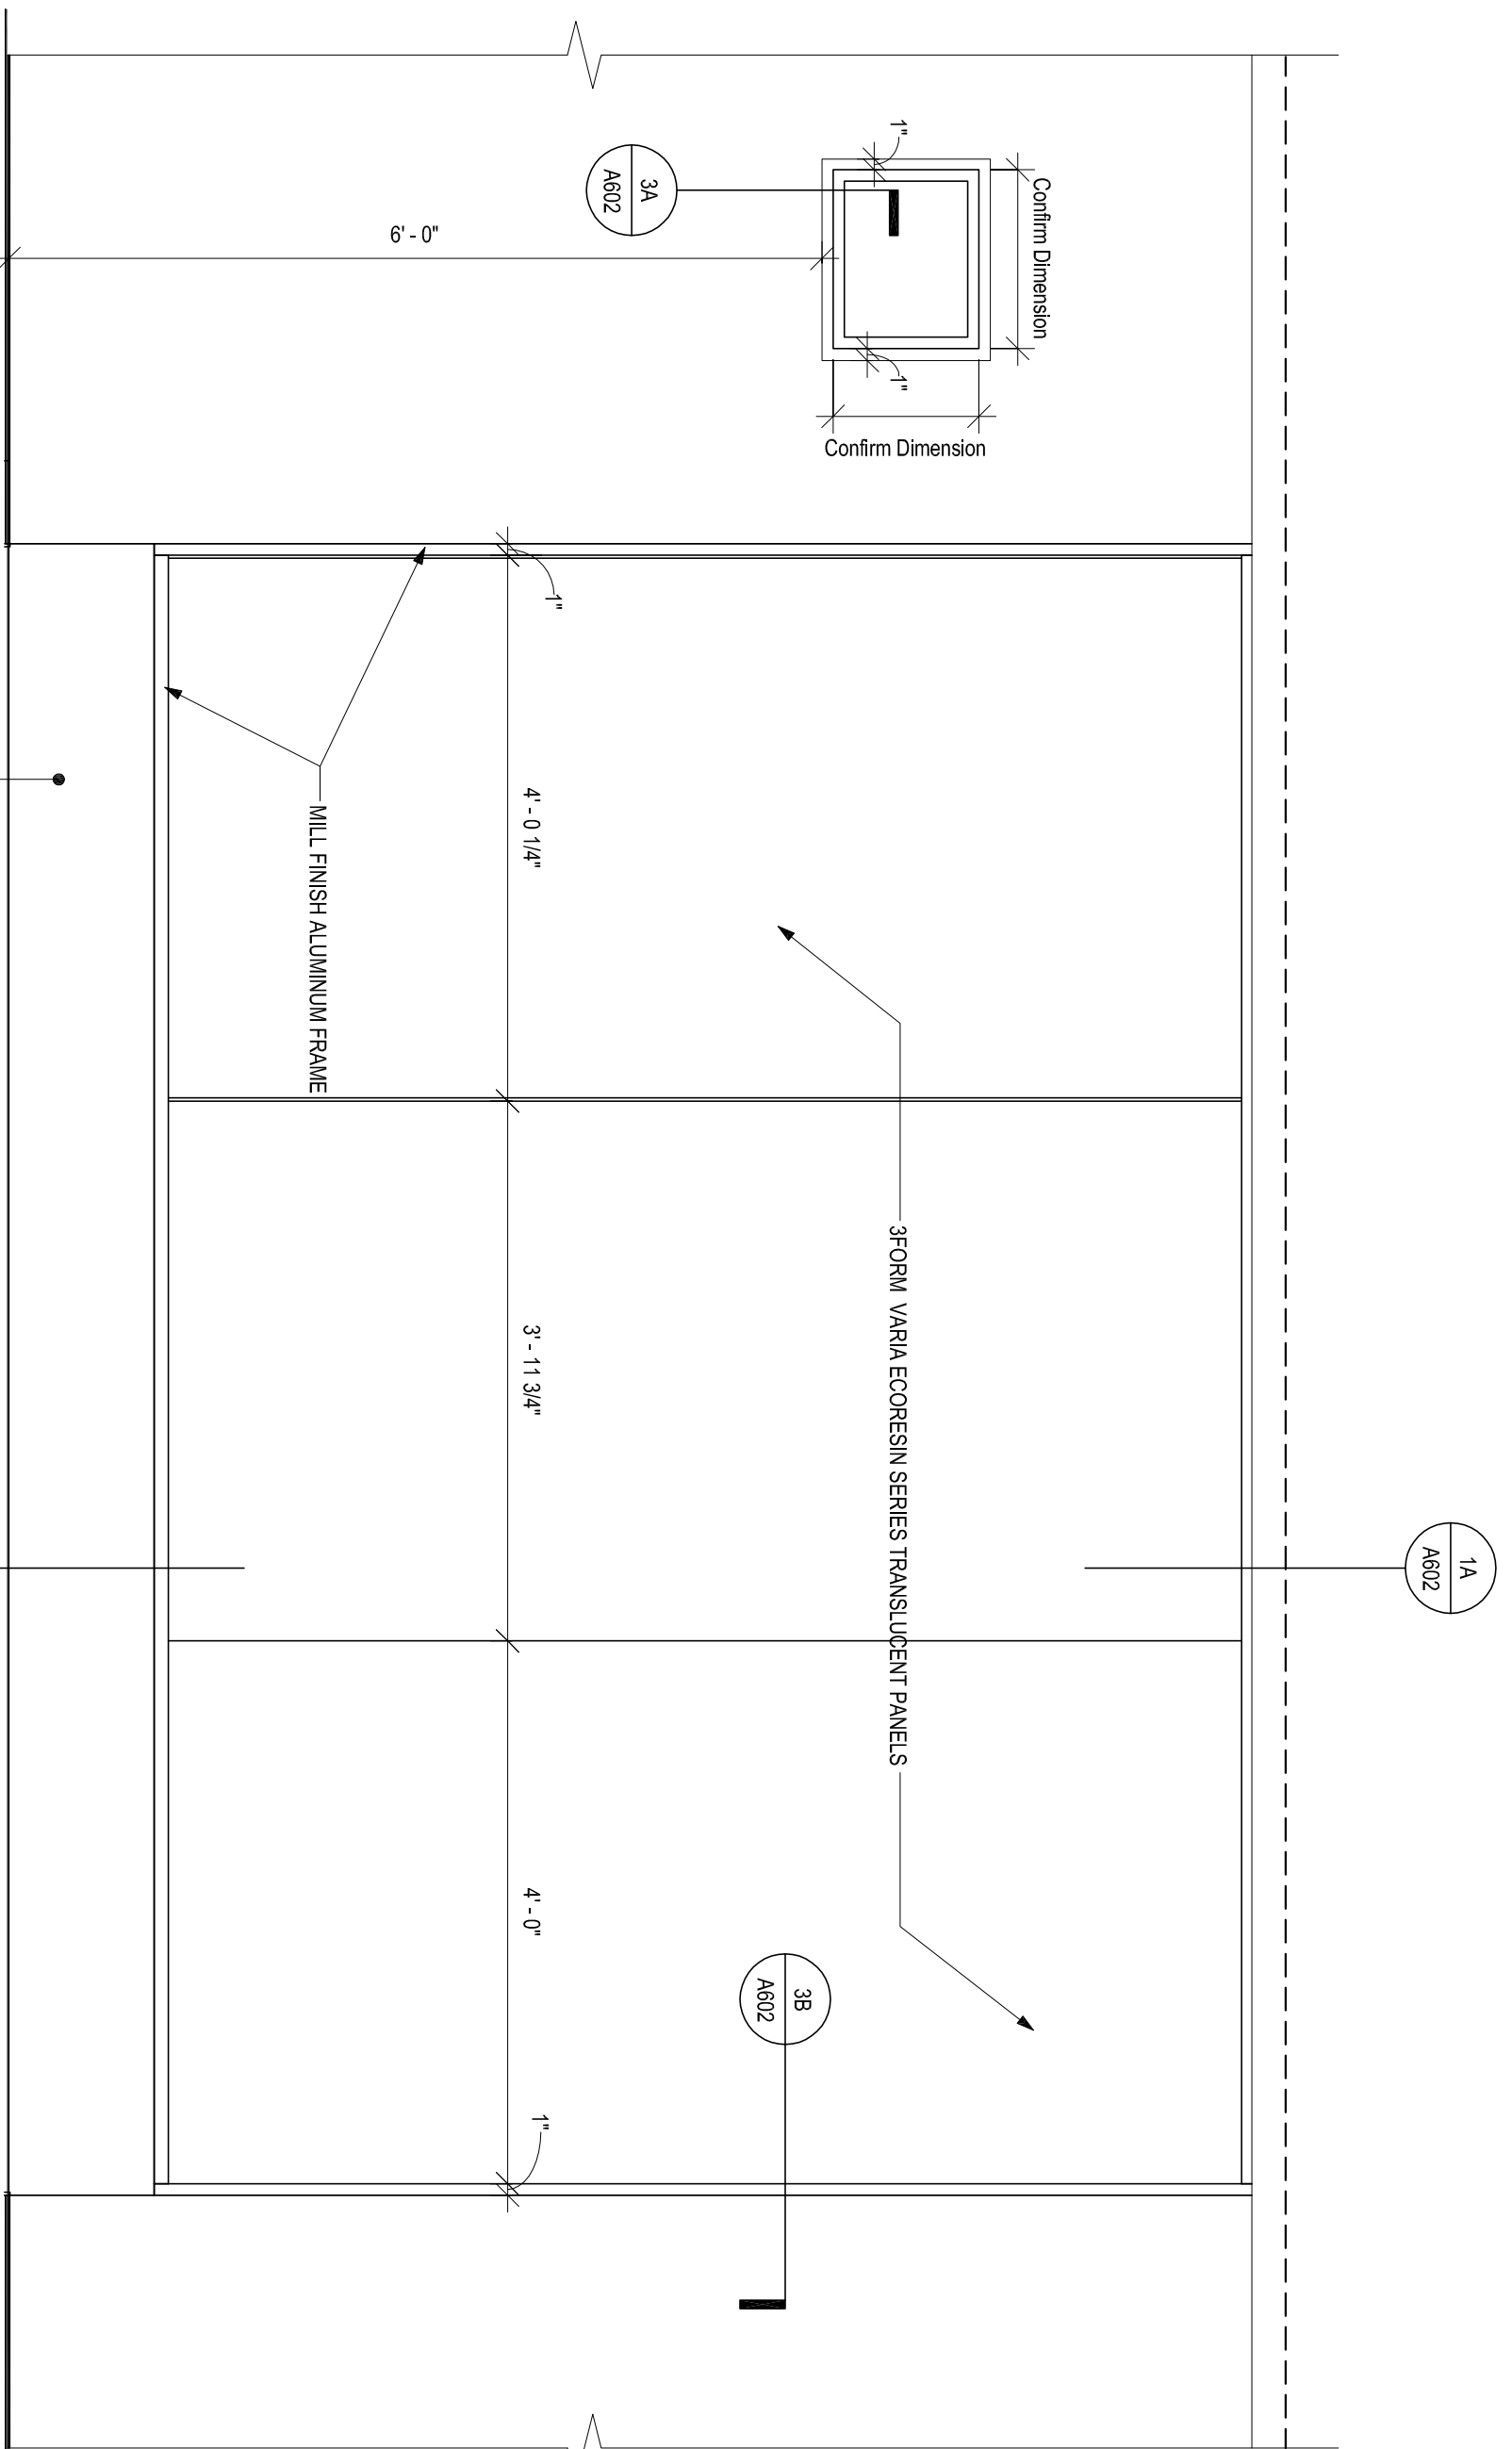

1C REGISTRATION FEATURE WALL  
 SCALE 3/4"=1'-0"

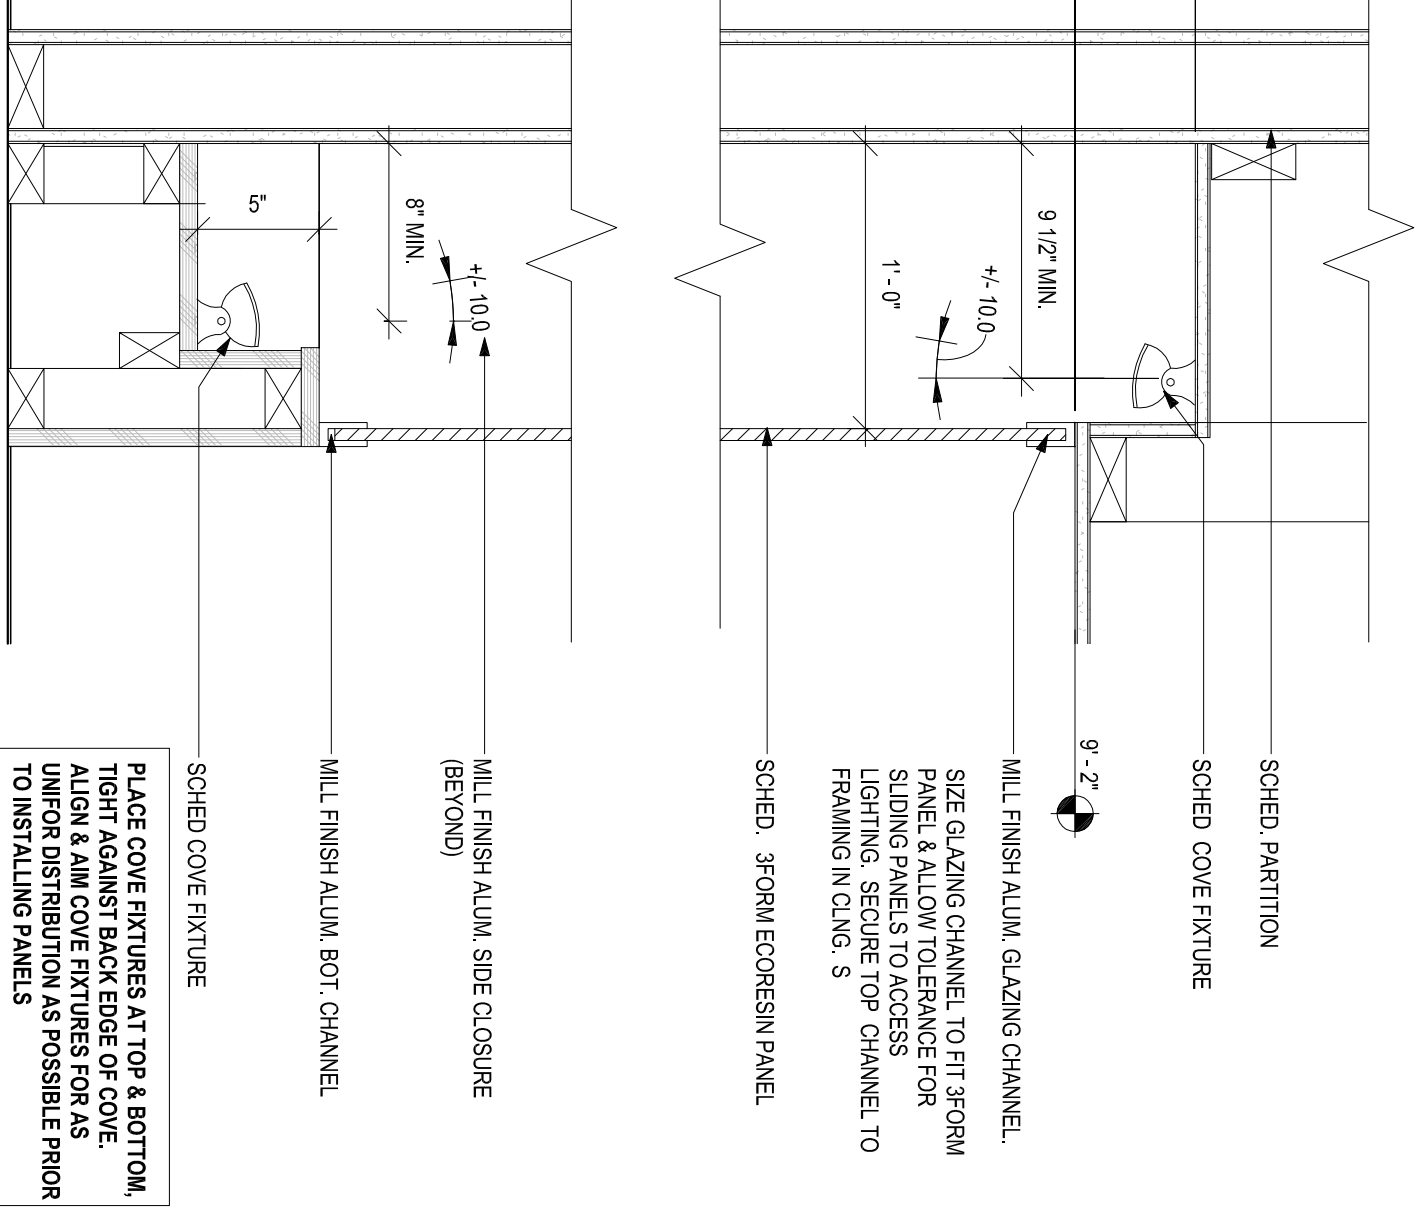

MILL FINISH ALUM. GLAZING CHANNEL  
 SIZE GLAZING CHANNEL TO FIT 3600M  
 PANEL & ALLOW TO LERANCE FOR  
 SLIDING PANELS TO ACCESS  
 FRAMING INSIDE CHANNEL TO  
 FINISH CHANNEL S

MILL FINISH ALUM. SIDE CLOSURE  
 (BEYOND)

MILL FINISH ALUM. BOT. CHANNEL

SCHED. COVE FIXTURE


SCHED. PARTITION

SCHED. COVE FIXTURE


SCHED. 3600M ECORESN PANEL

PLACE COVE FIXTURE AT TOP & BOTTOM  
 TIGHT AGAINST BACK EDGE OF COVE  
 UNIFORM DISTRIBUTION AS POSSIBLE PRIOR  
 TO INSTALLING PANELS


1A REGISTRATION FEATURE WALL  
 SCALE 1 1/2"=1'-0"

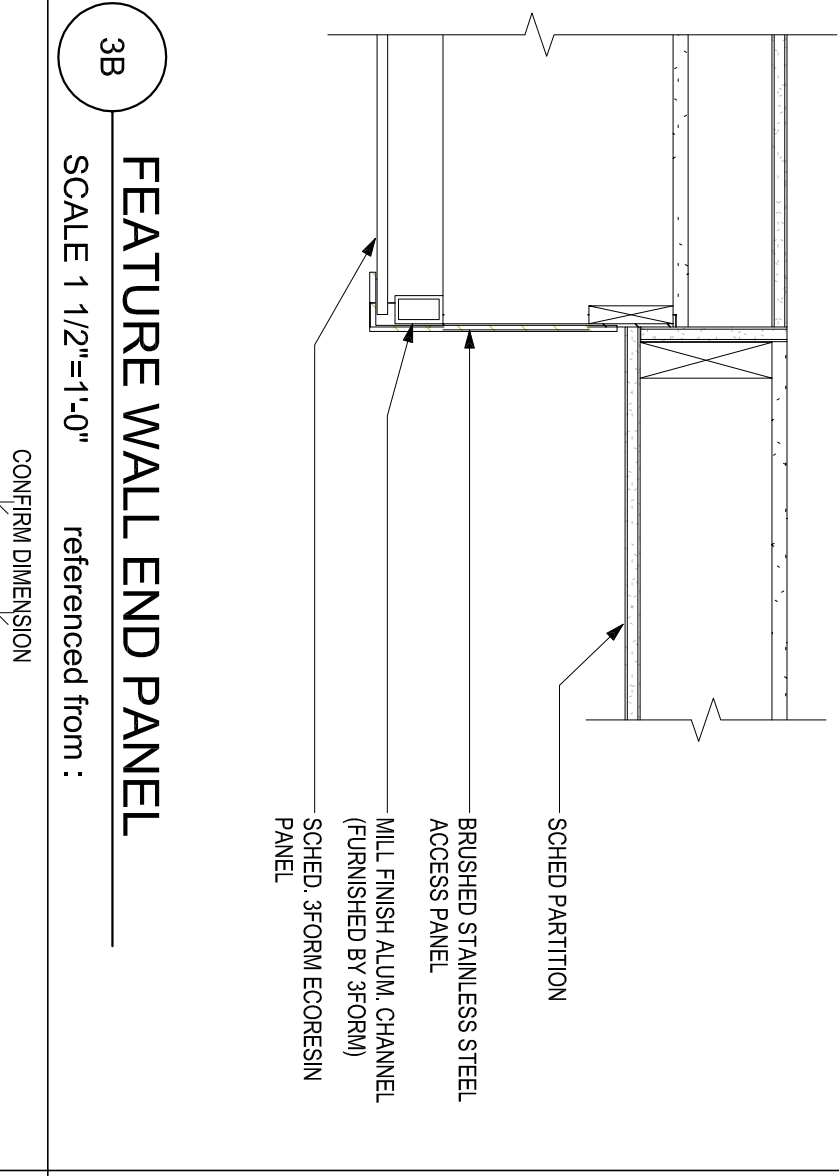


38 FEATURE WALL END PANEL  
 SCALE 1 1/2"=1'-0" referenced from :

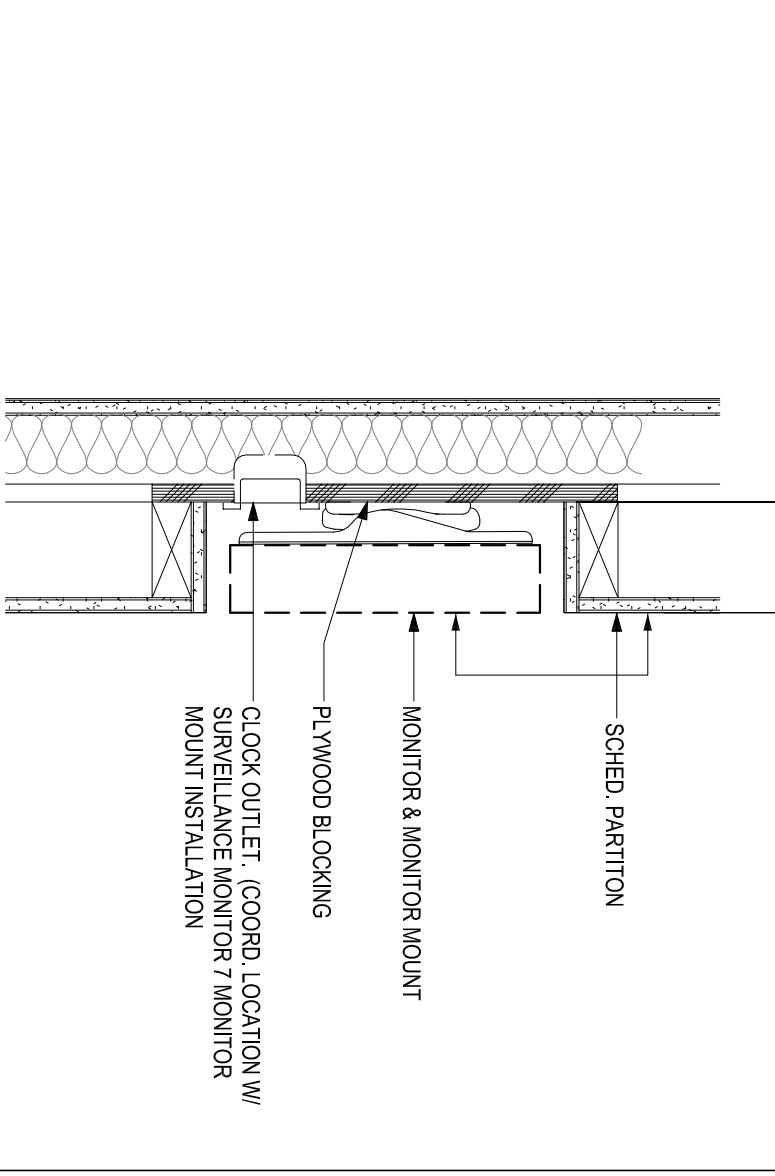


3A RECESSED SURVEILLANCE MONITOR  
 SCALE 1 1/2"=1'-0"

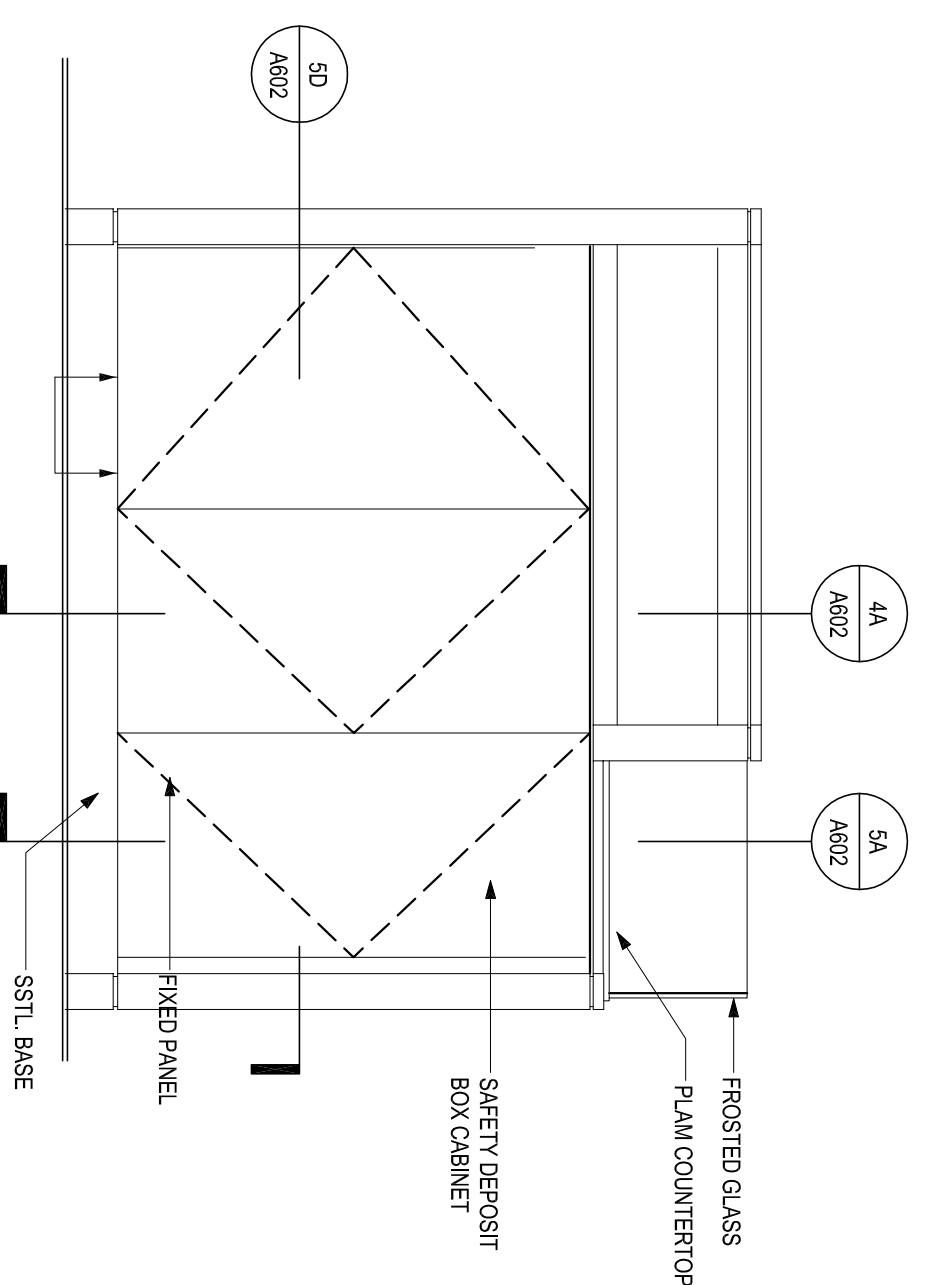


4D GUEST SERVICE PEDESTAL - FRONT  
 SCALE 3/4"=1'-0"

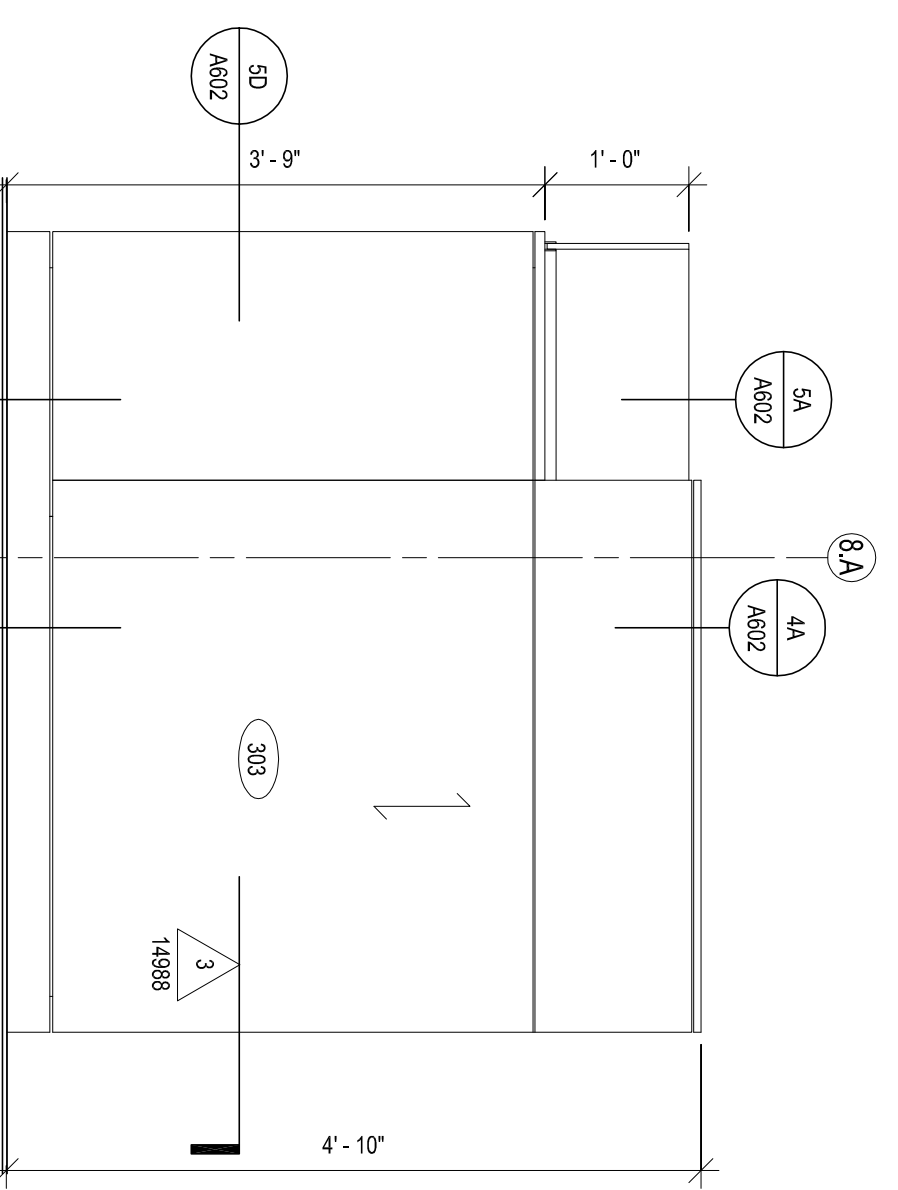


4C GUEST SERVICE PEDESTAL - REAR  
 SCALE 3/4"=1'-0"

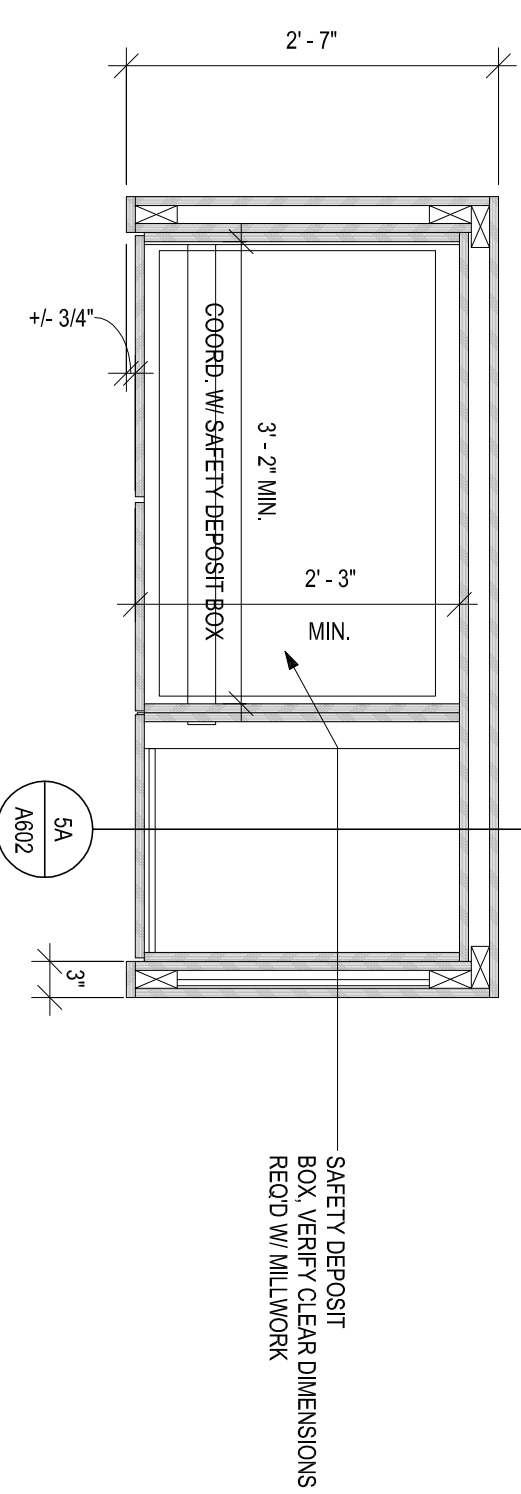


5D GUEST SERVICE PEDESTAL  
 SCALE 3/4"=1'-0"

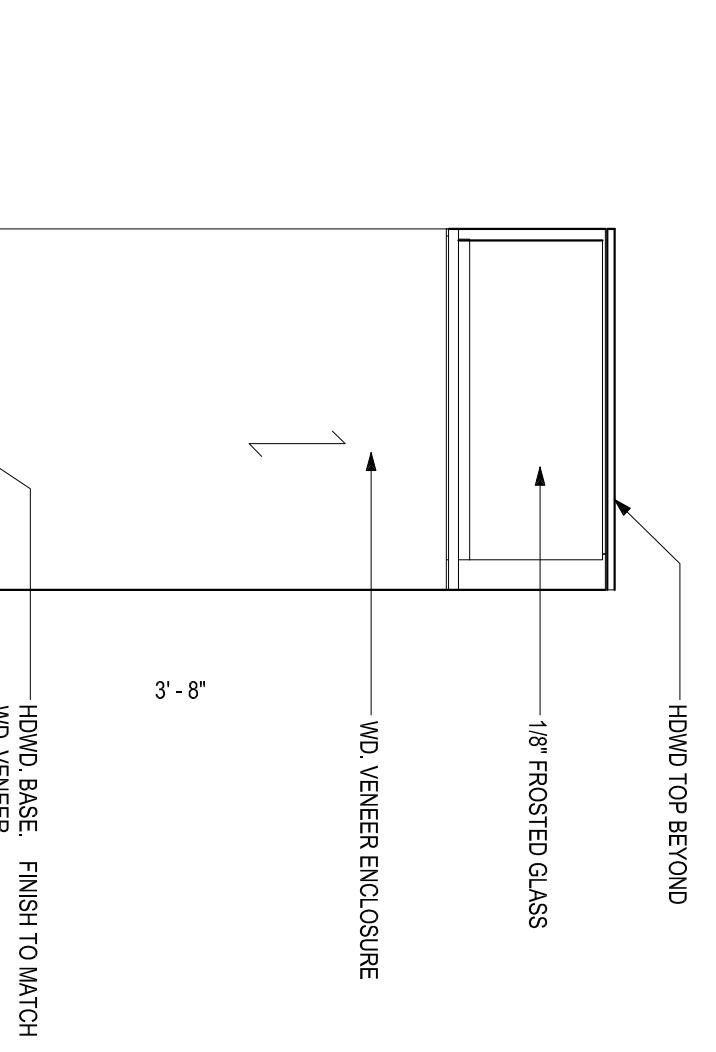

5C GUEST SERVICES PEDESTAL - SIDE  
 SCALE 3/4"=1'-0"

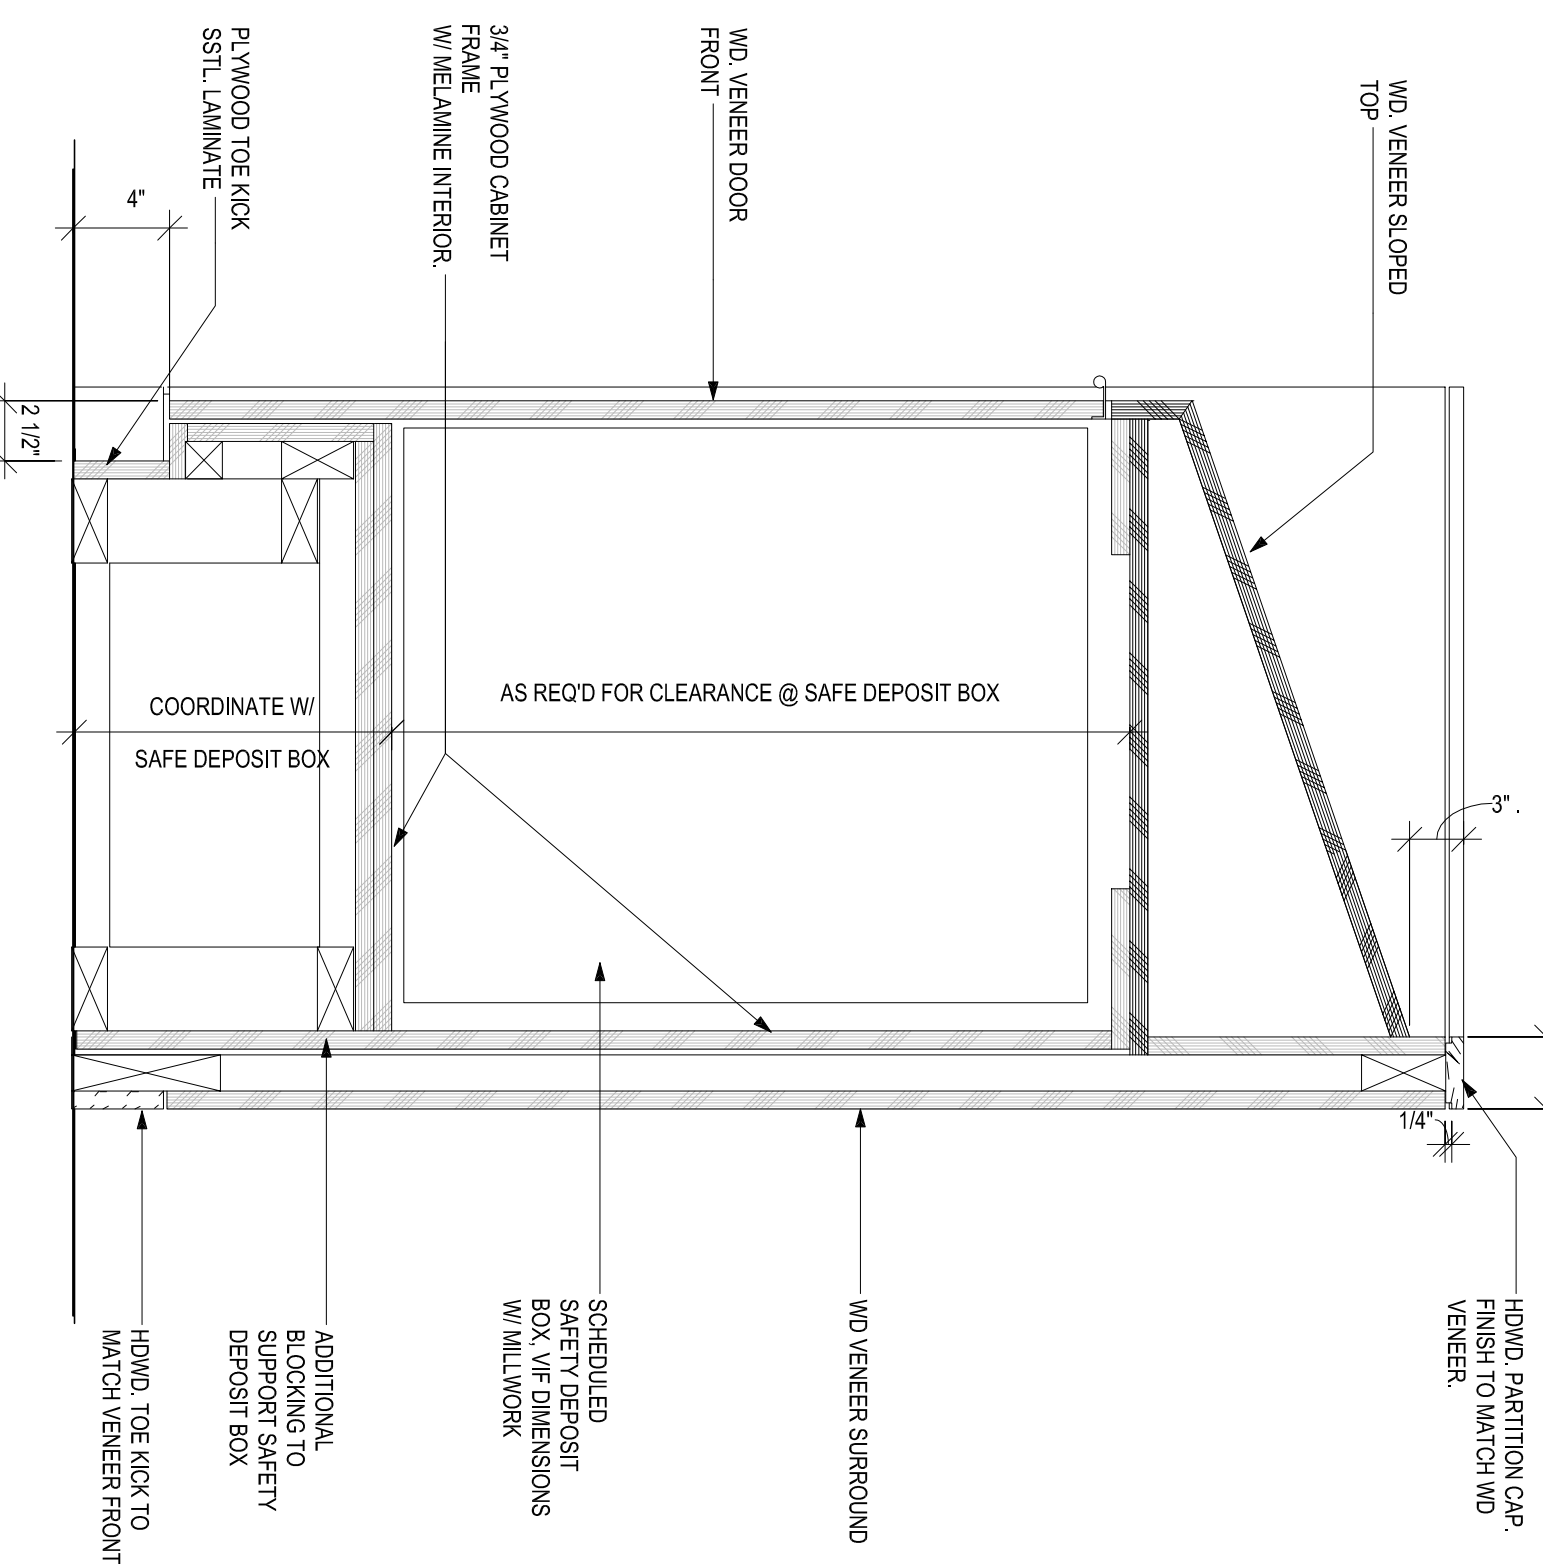

4A 502 SAFETY DEPOSIT BOX CABINET SECTION  
 SCALE 1 1/2"=1'-0"

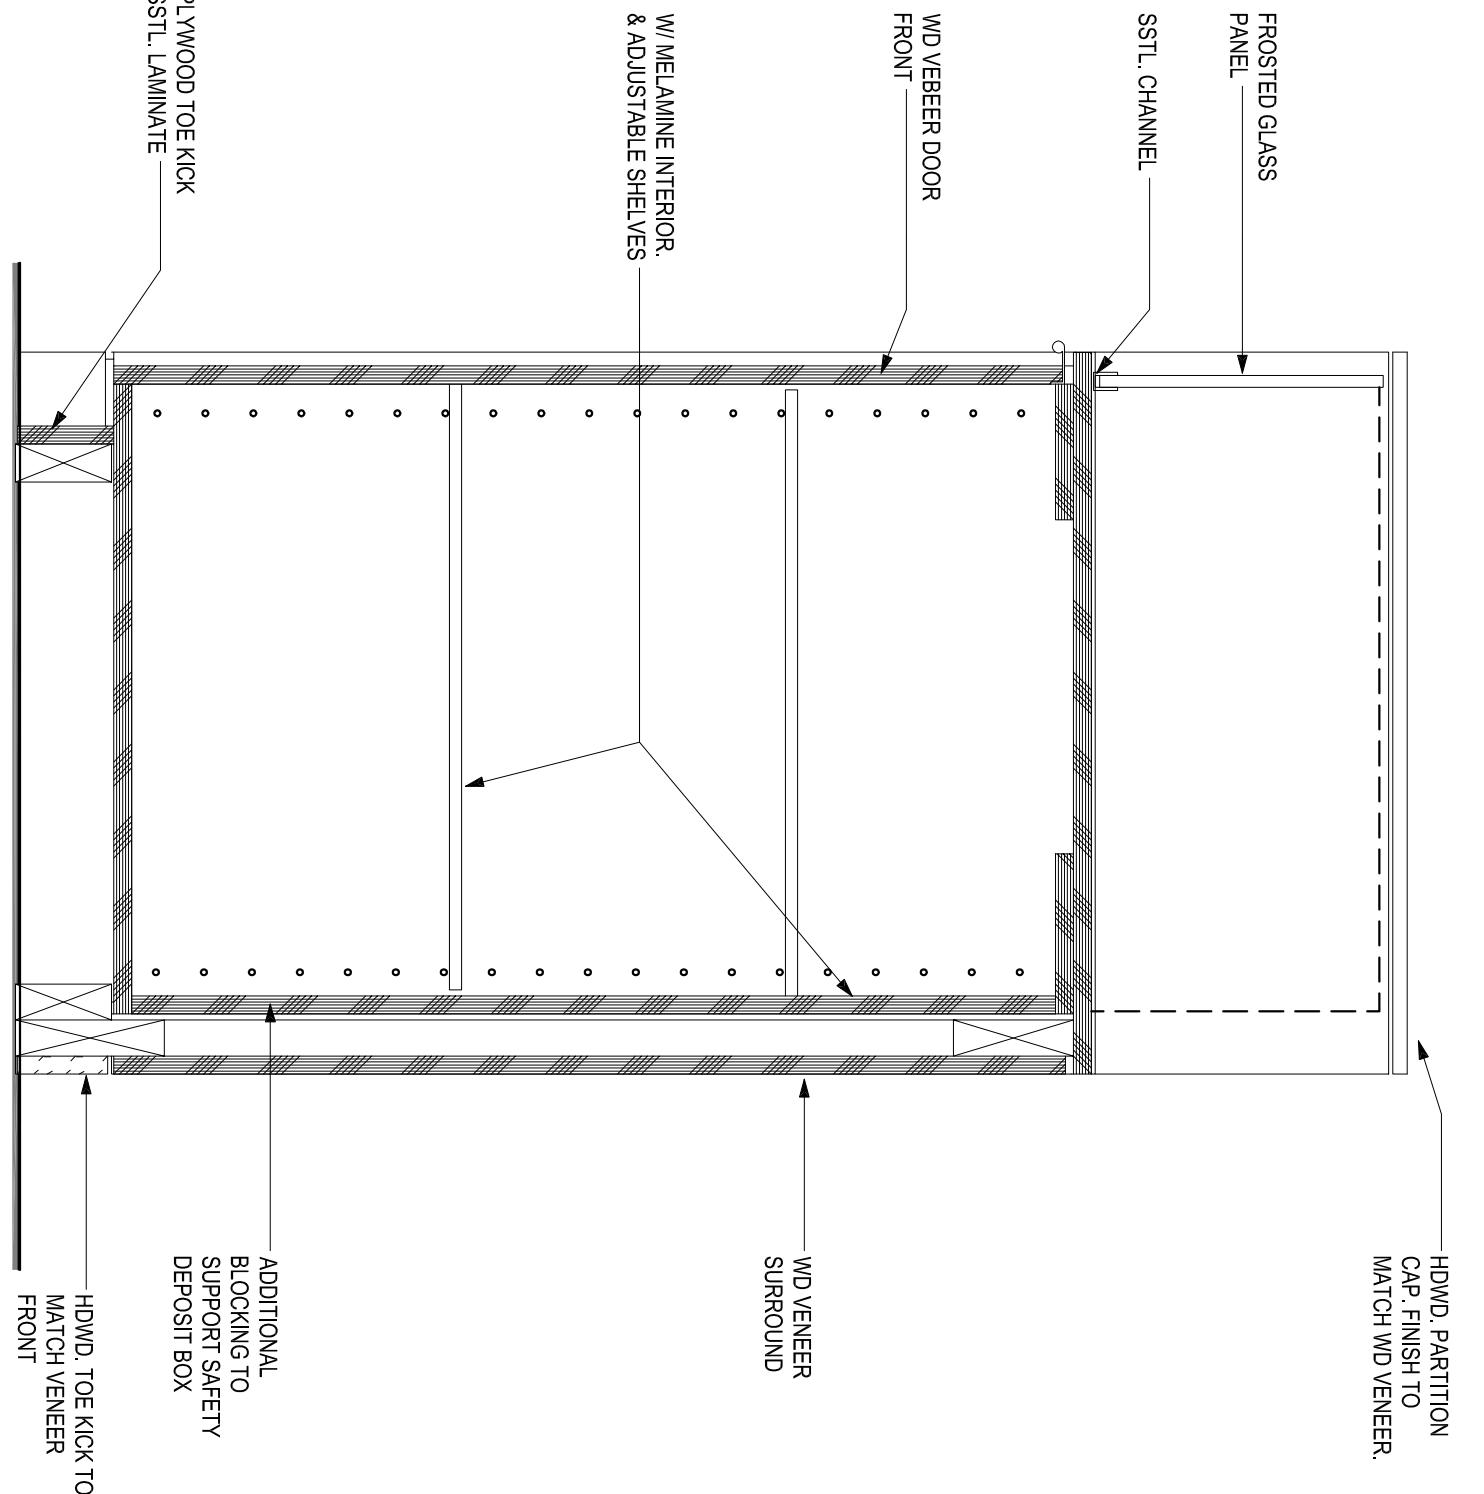

5A SAFETY DEPOSIT BOX CABINET SECTION @ GLASS  
 SCALE 1 1/2"=1'-0"

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2	11/22/15	50% REVIEW SET
3	1/22/16	100% REVIEW SET






NO.	DATE	DESCRIPTION
1	09/22/15	30% REVIEW SET
2	11/22/15	50% REVIEW SET
3	1/22/16	100% REVIEW SET

PROJECT NUMBER: 15180

DRAWING NAME: WELCOME DESK DETAILS

DRAWN BY: BBC  
 CHECKED BY: BBC  
 DATE: 12-22-15  
 SCALE: AS NOTED

DRAWING NUMBER: A602

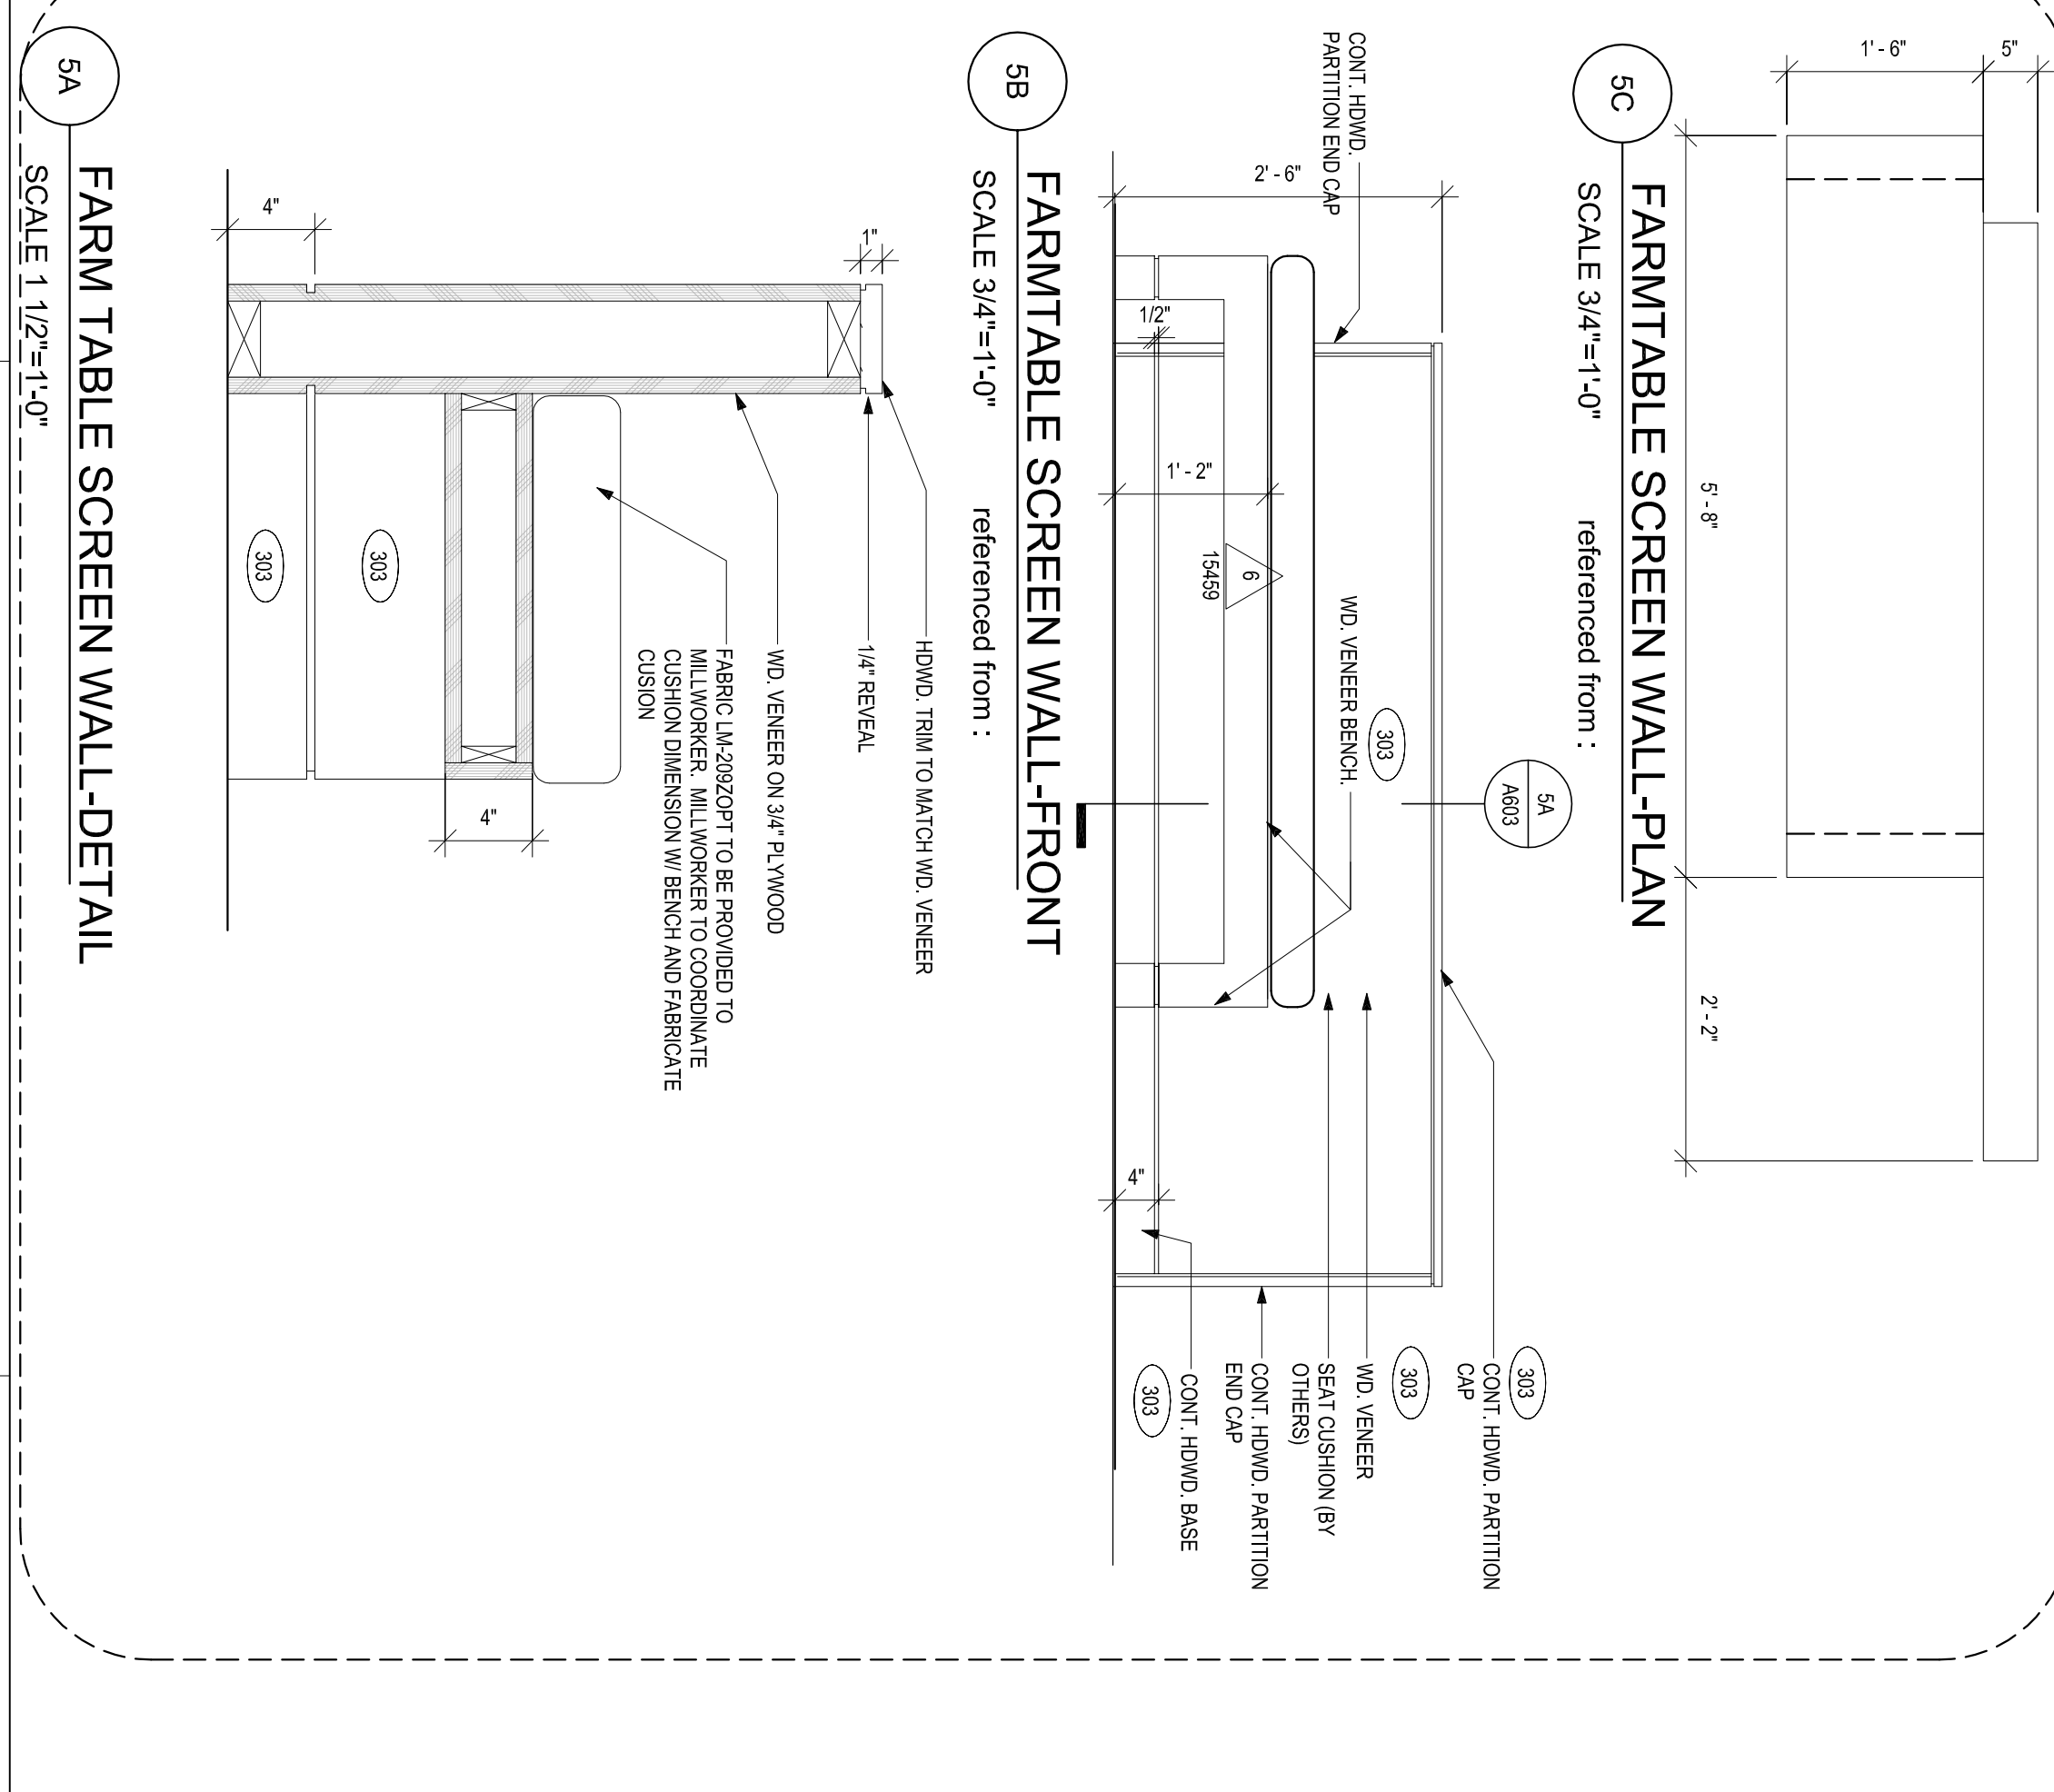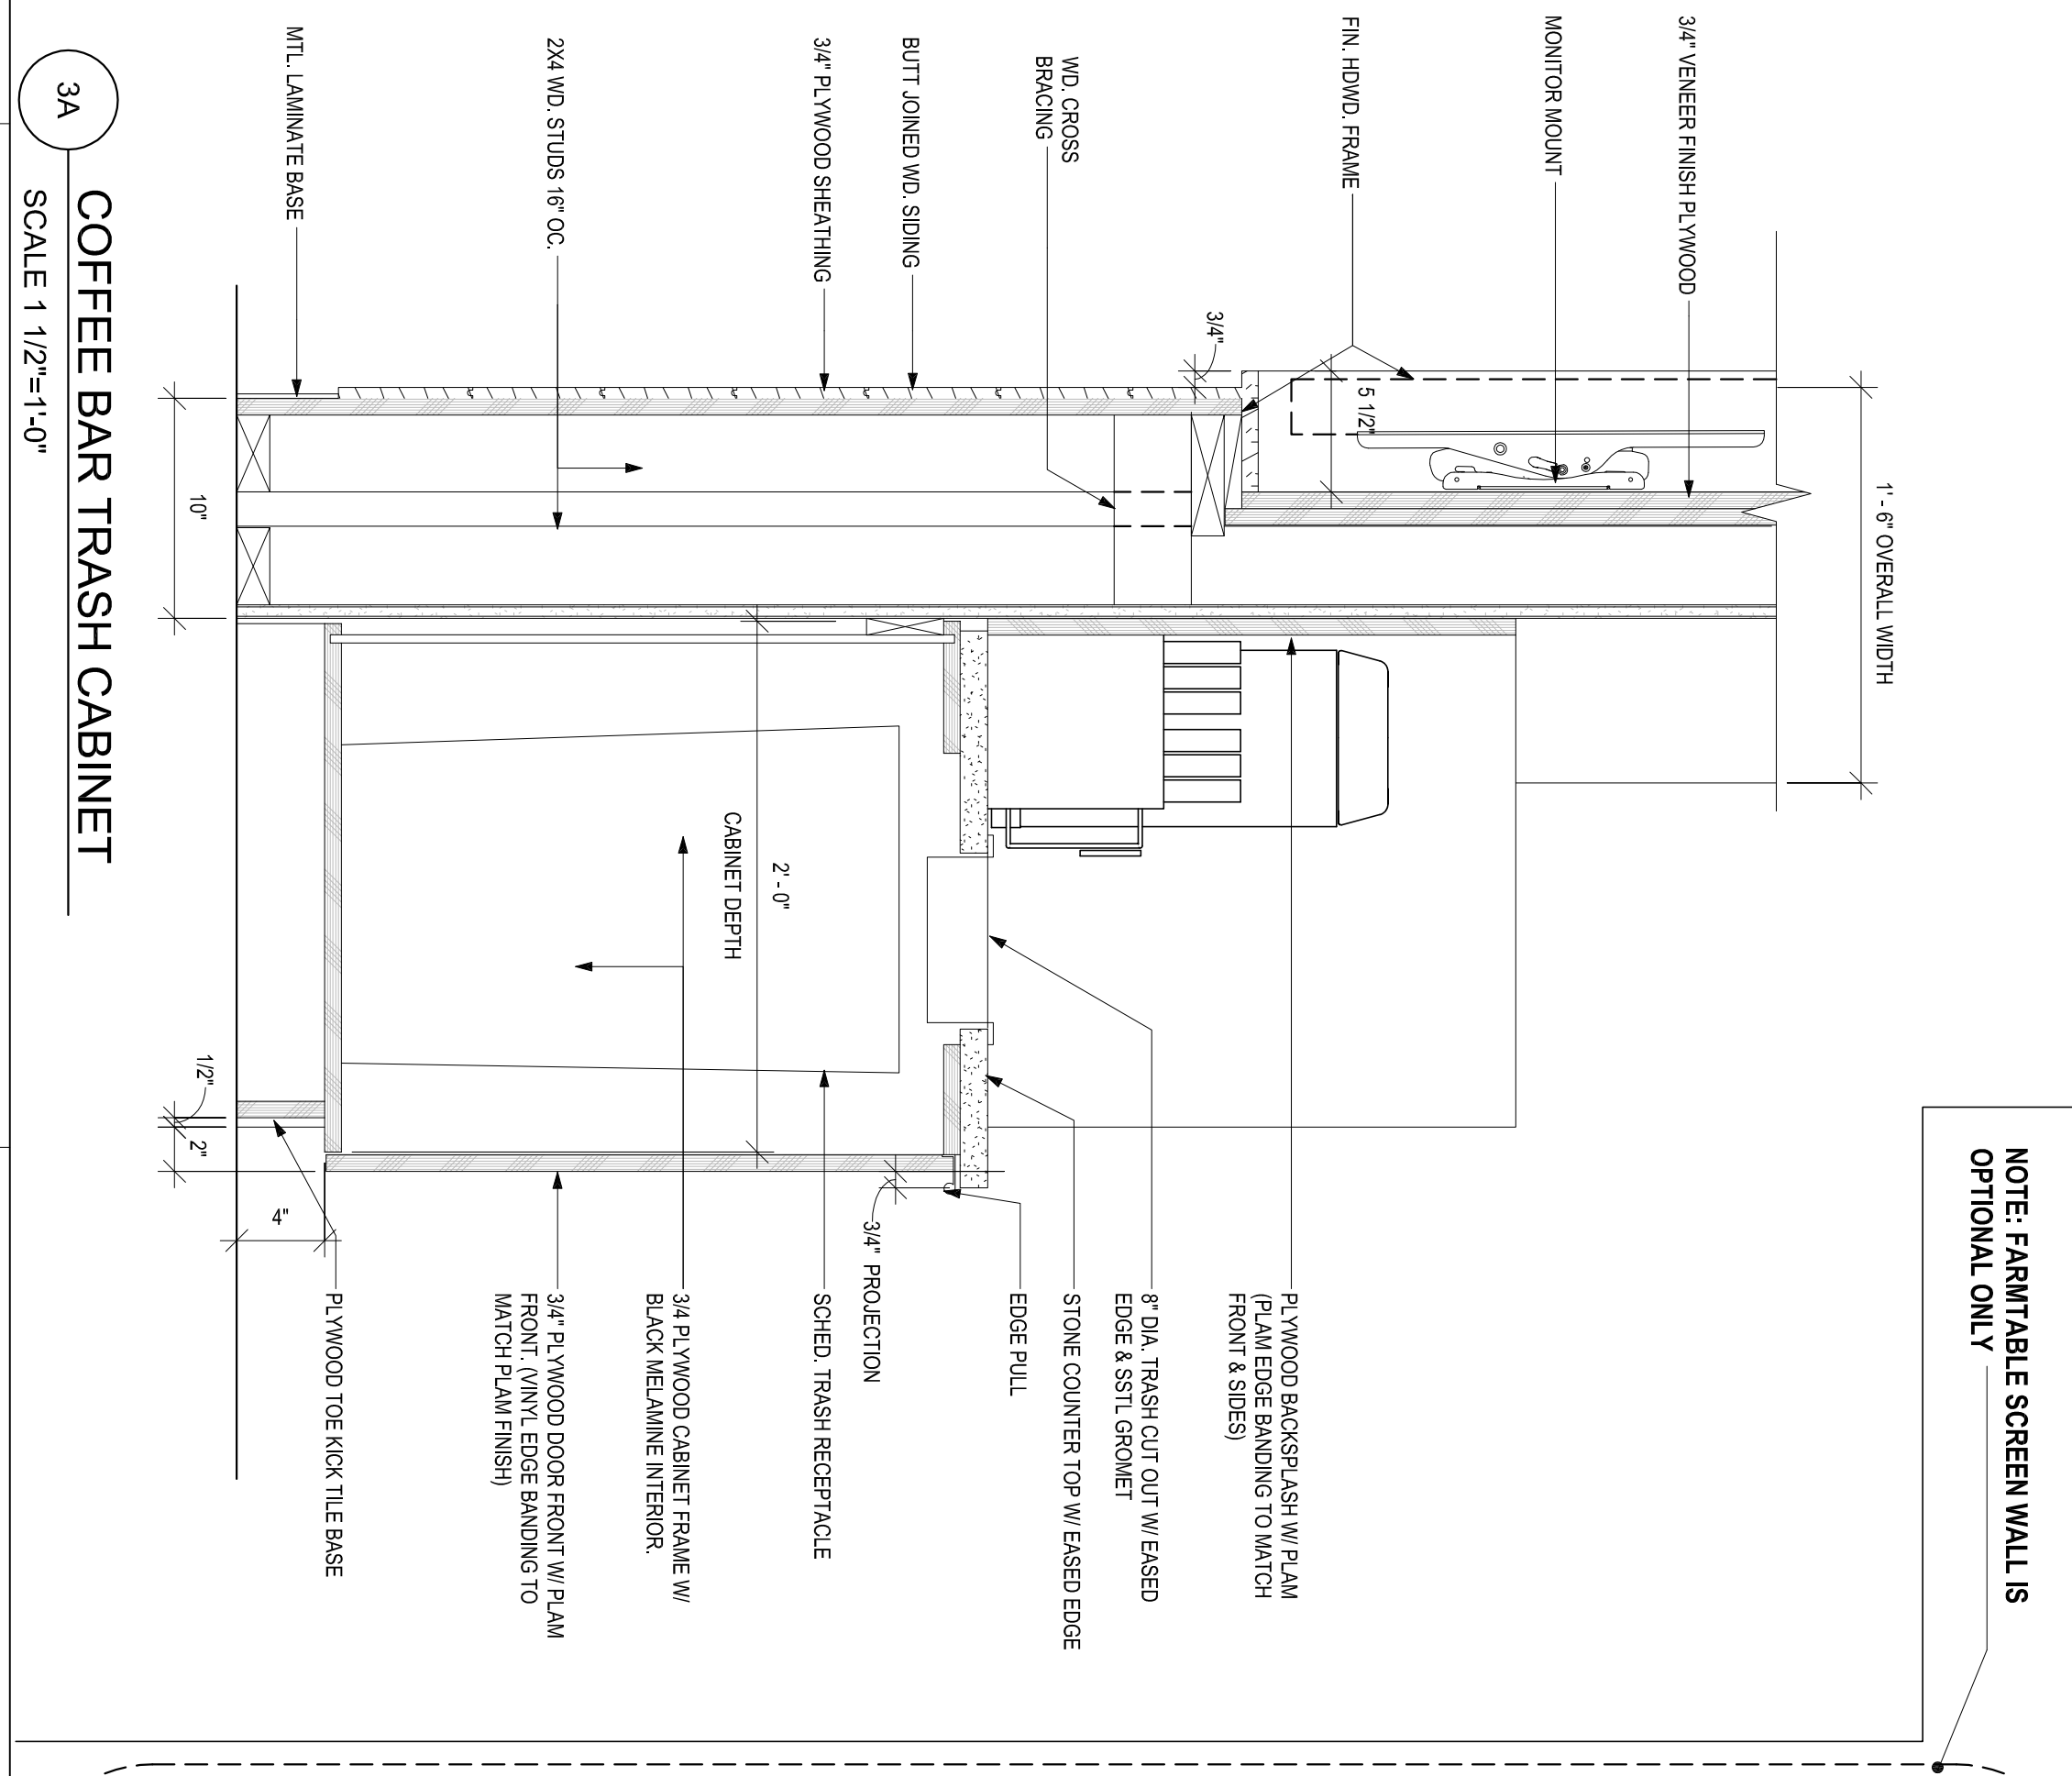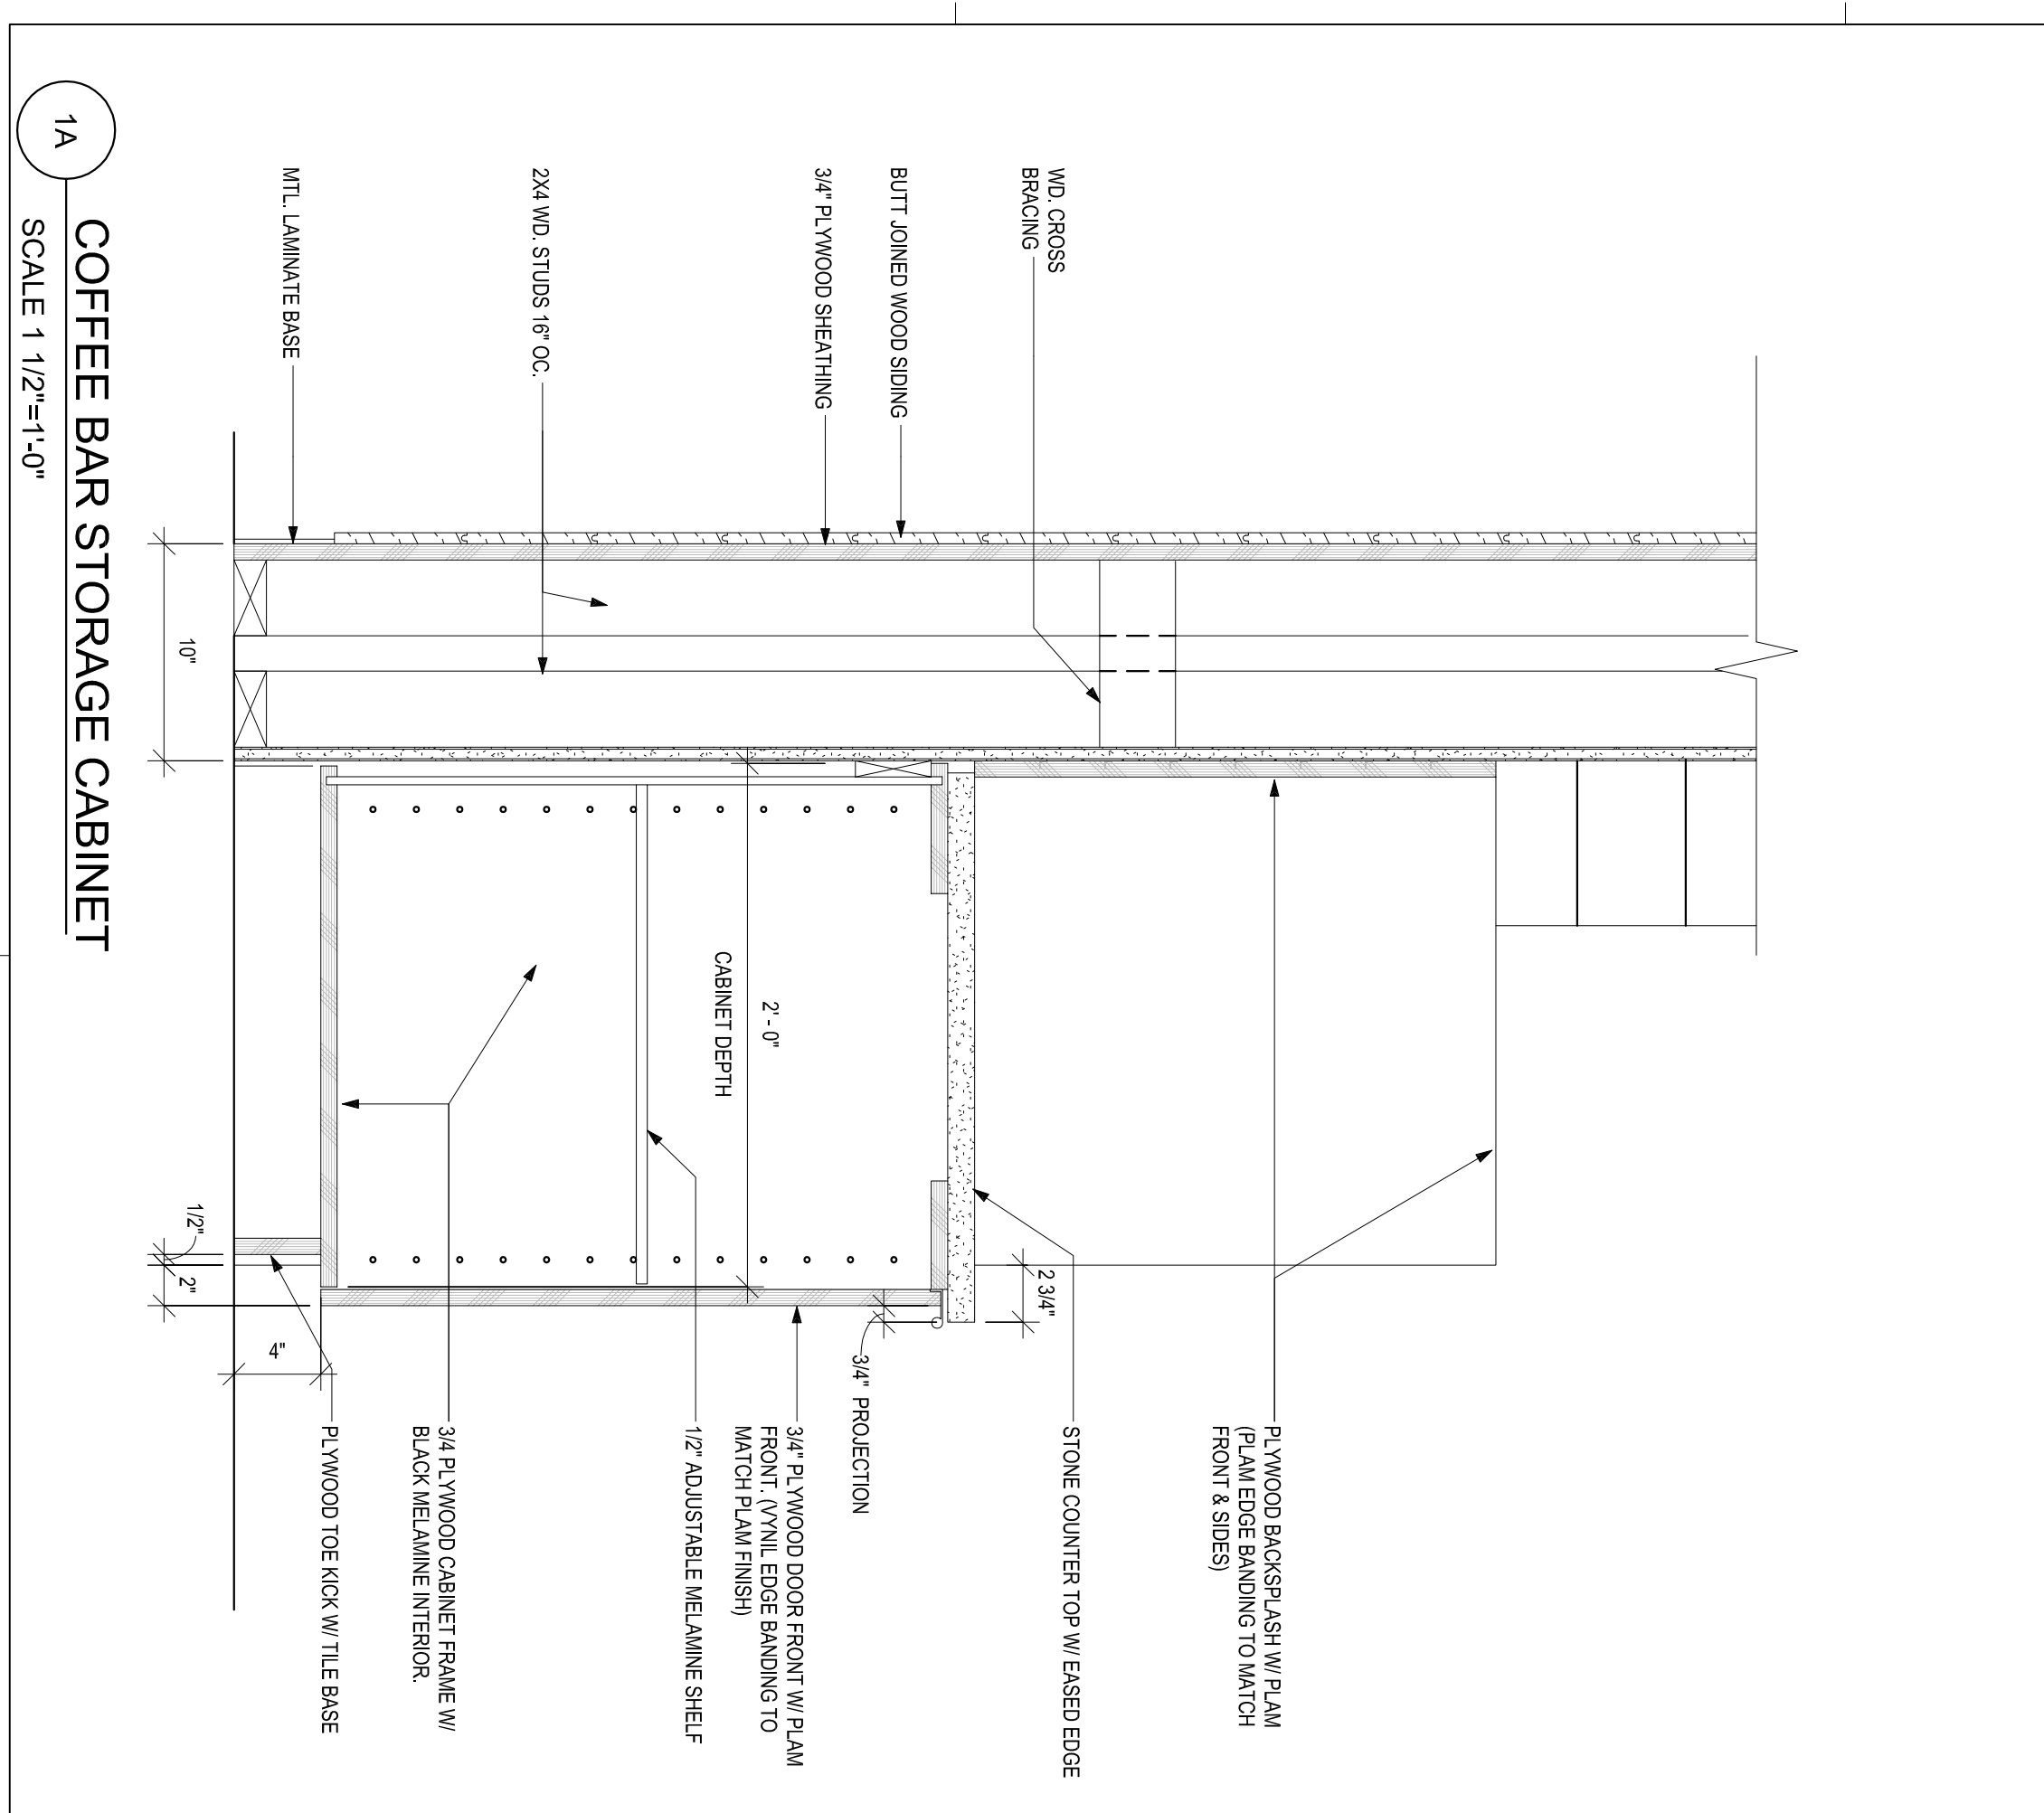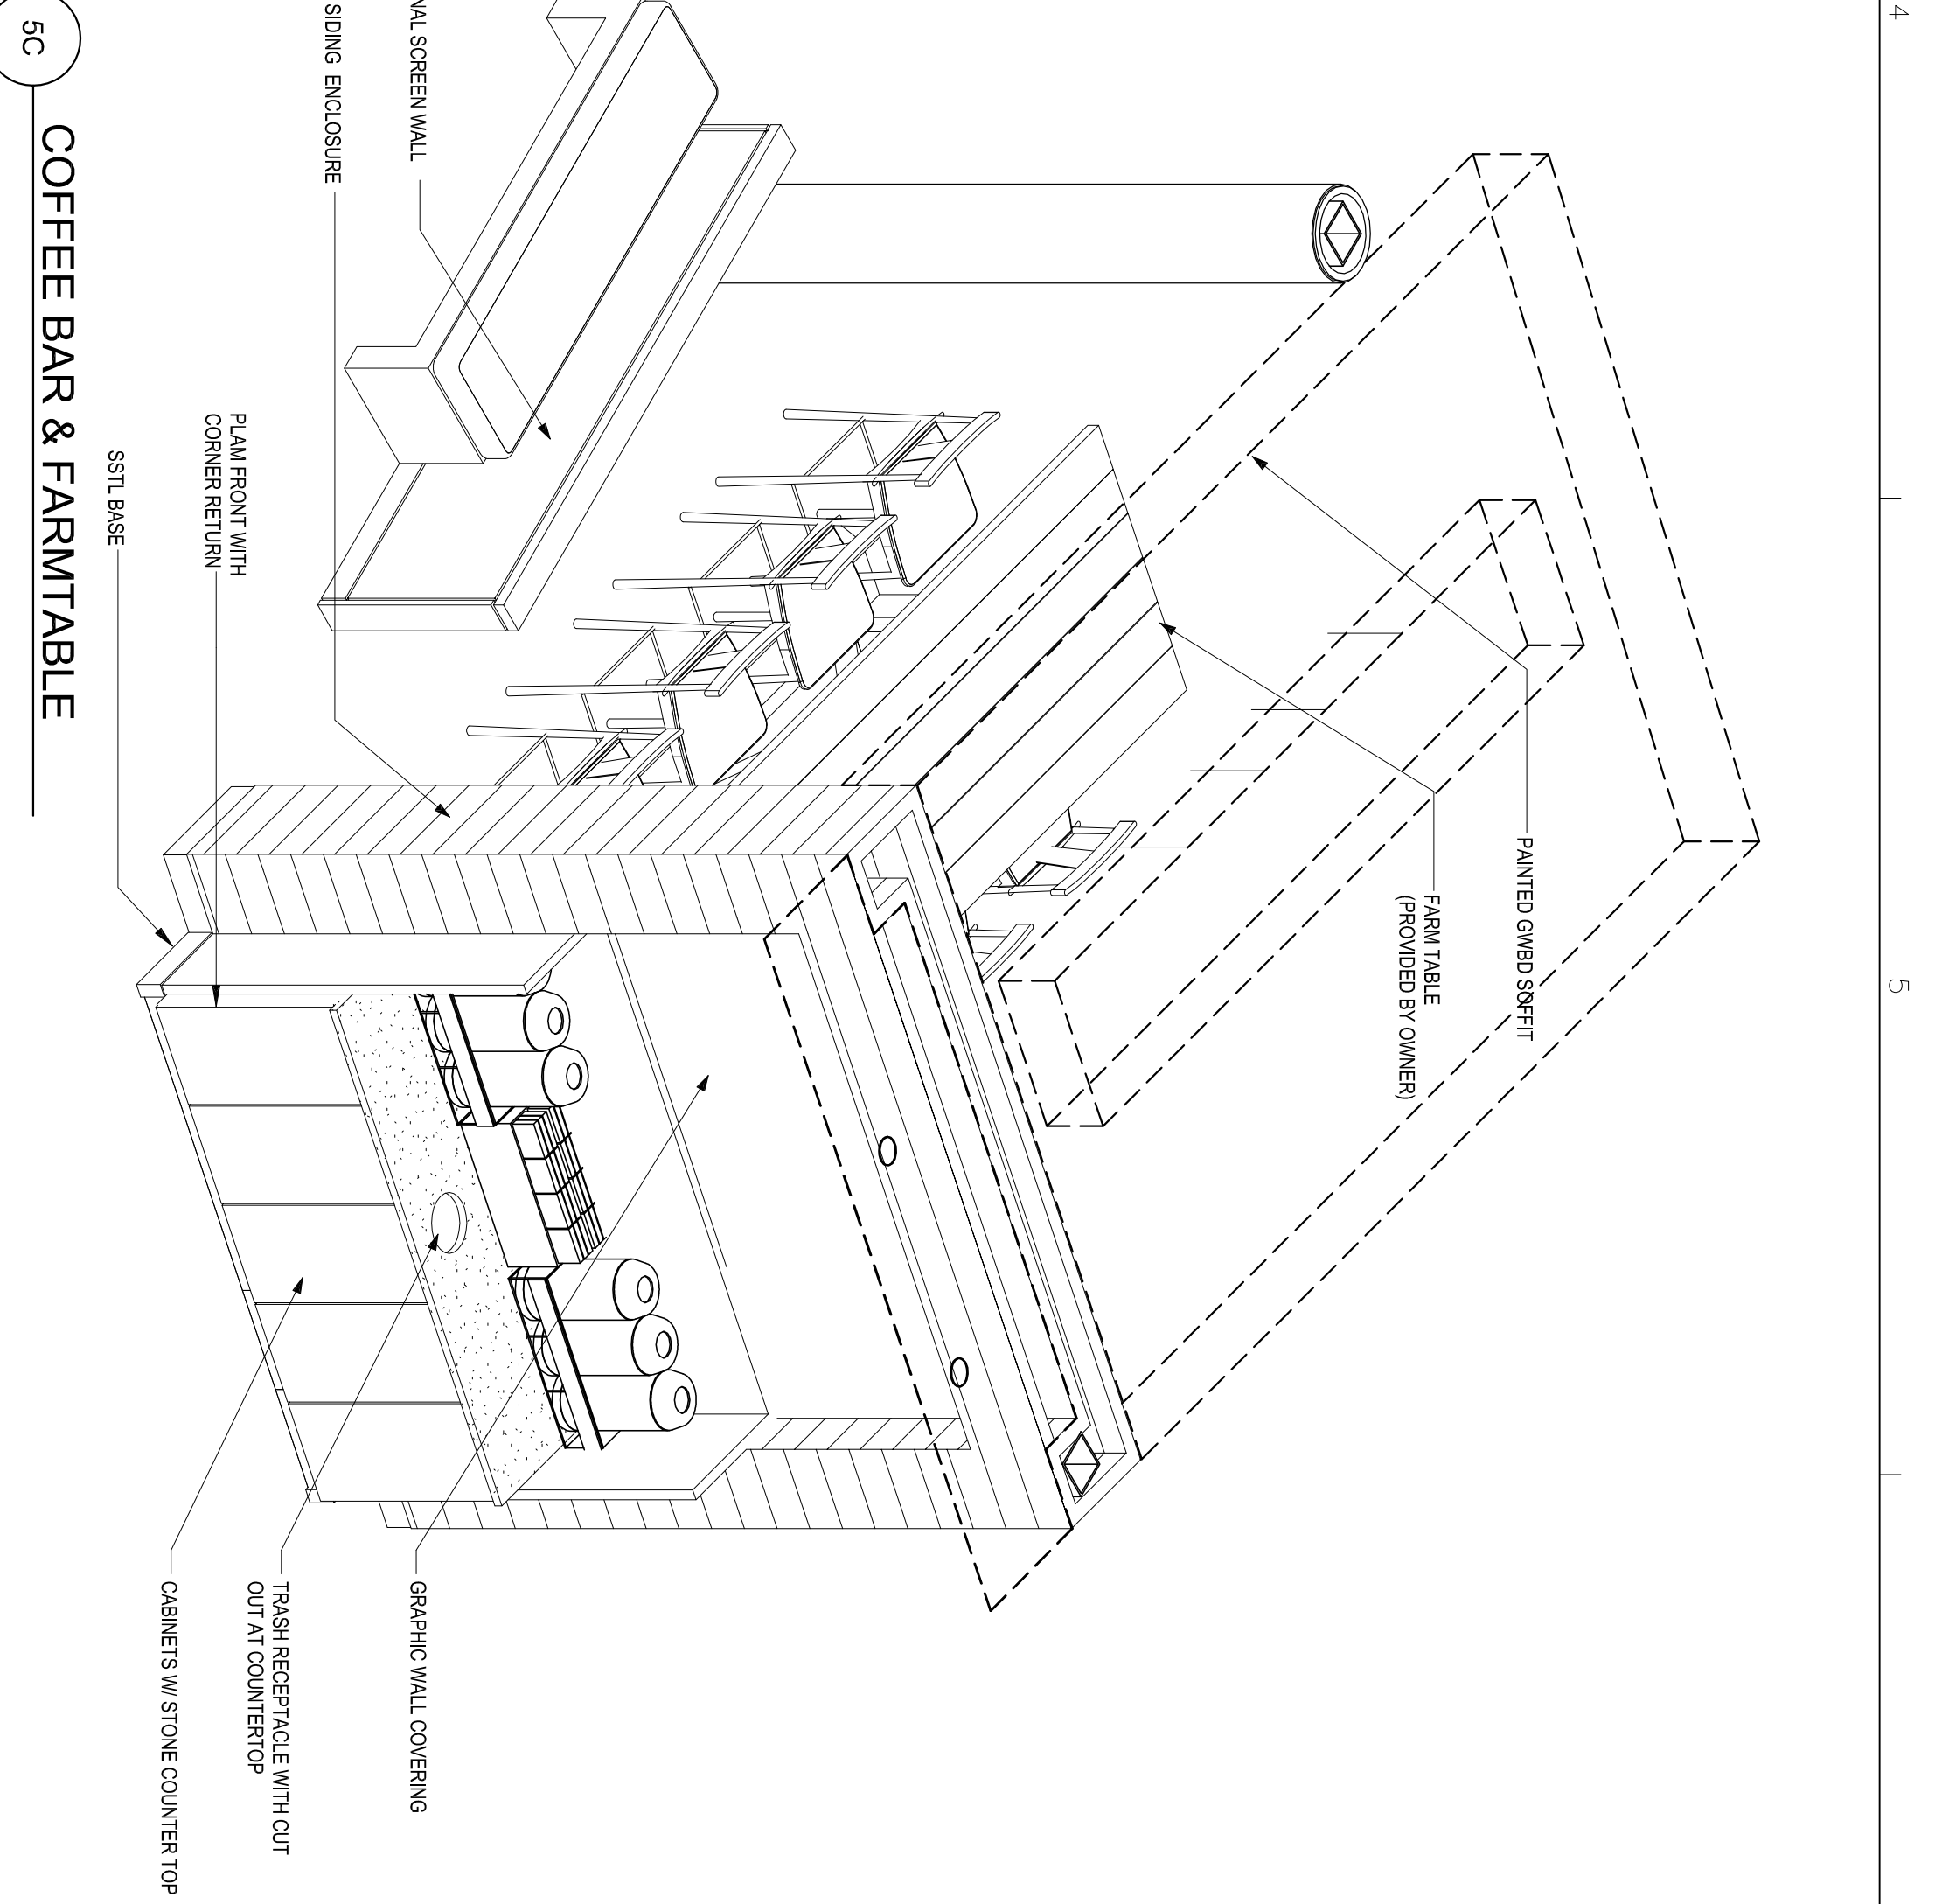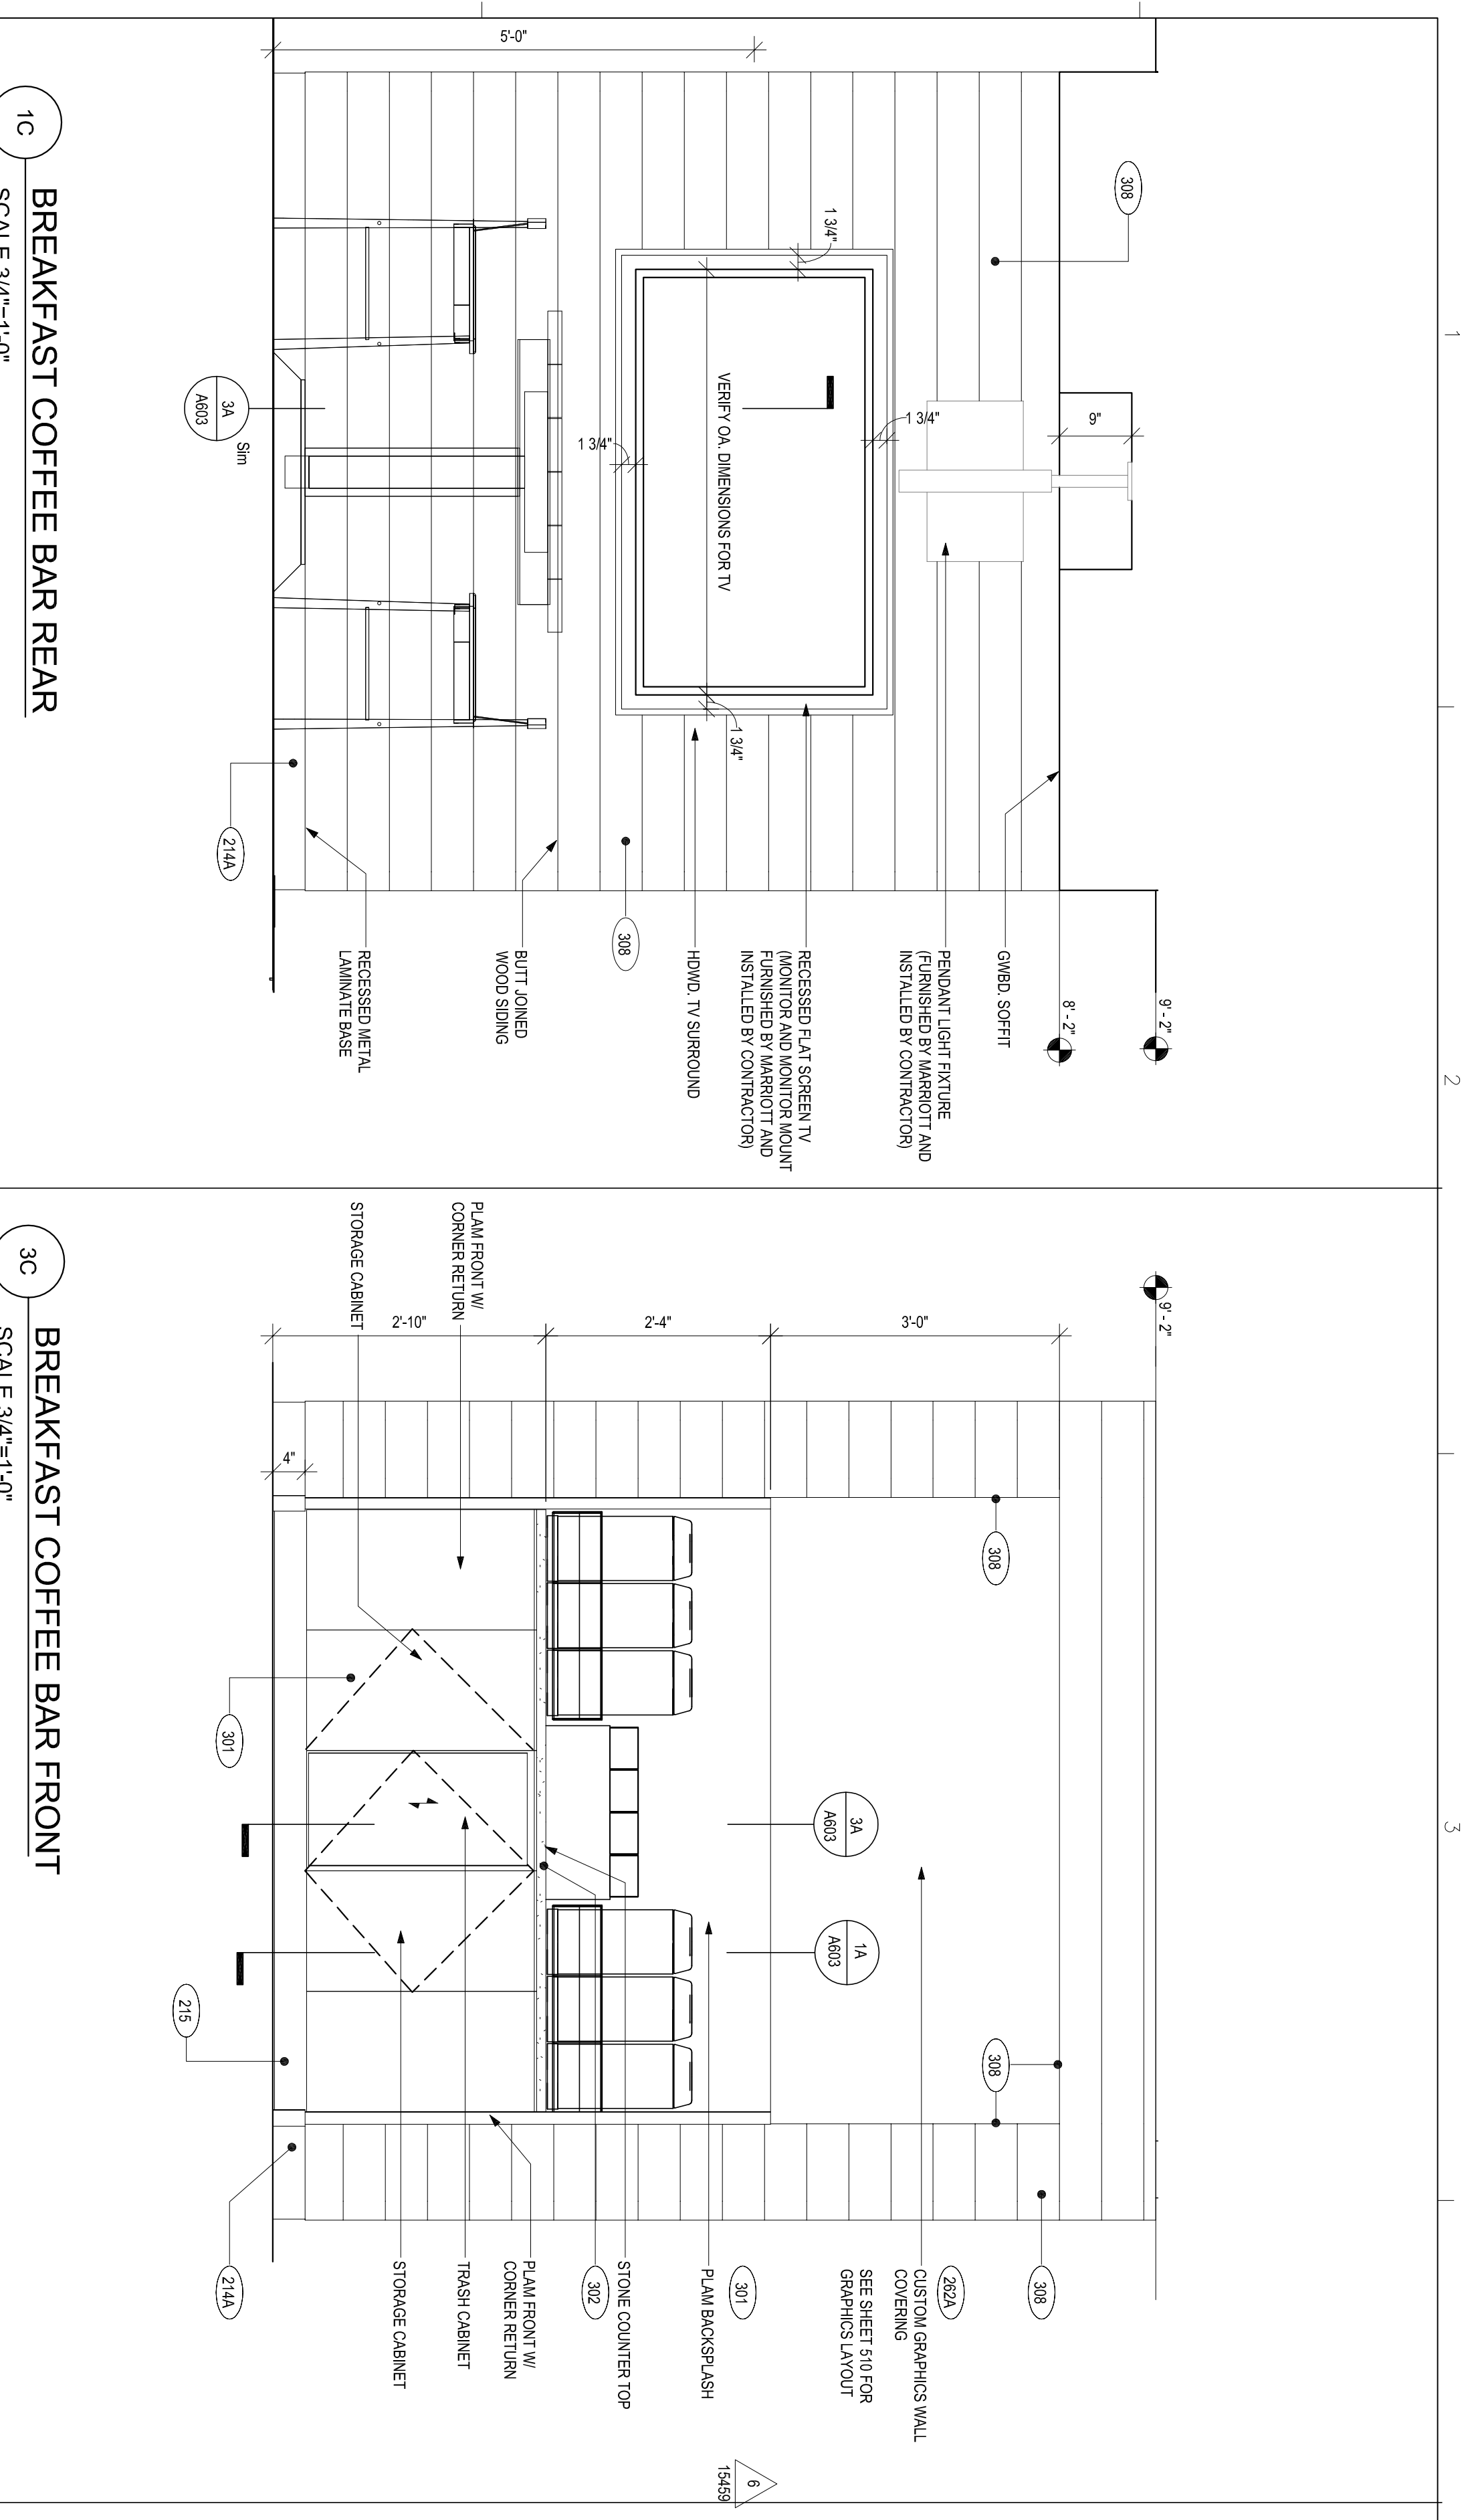

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2	10/22/2015	50% REVIEW SET
3	12/22/2015	100% REVIEW SET

ISSUES & REVISIONS

DRAWN BY: BNC  
 CHECKED BY: BBC  
 DATE: 12-22-15  
 SCALE: AS NOTED  
 DRAWING NUMBER: **A603**

PROJECT NAME: COFFEE BAR & FARM TABLE DETAILS

SHEET NAME: COFFEE BAR & FARM TABLE DETAILS

REFERENCE NOTES

WORKING FIREPLACE IS OPTIONAL.  
CONTACT MARRIOTT REPRESENTATIVE FOR PLUS  
REQUIREMENTS AND APPROPRIATE CONDUIT AND UTILITY  
REQUIREMENTS.  
SEE INTERIOR ELEVATIONS & PLANS FOR FEE ITEM.

BYRON B. CARSON, JR., AIA

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bbccjson148@gmciil.com


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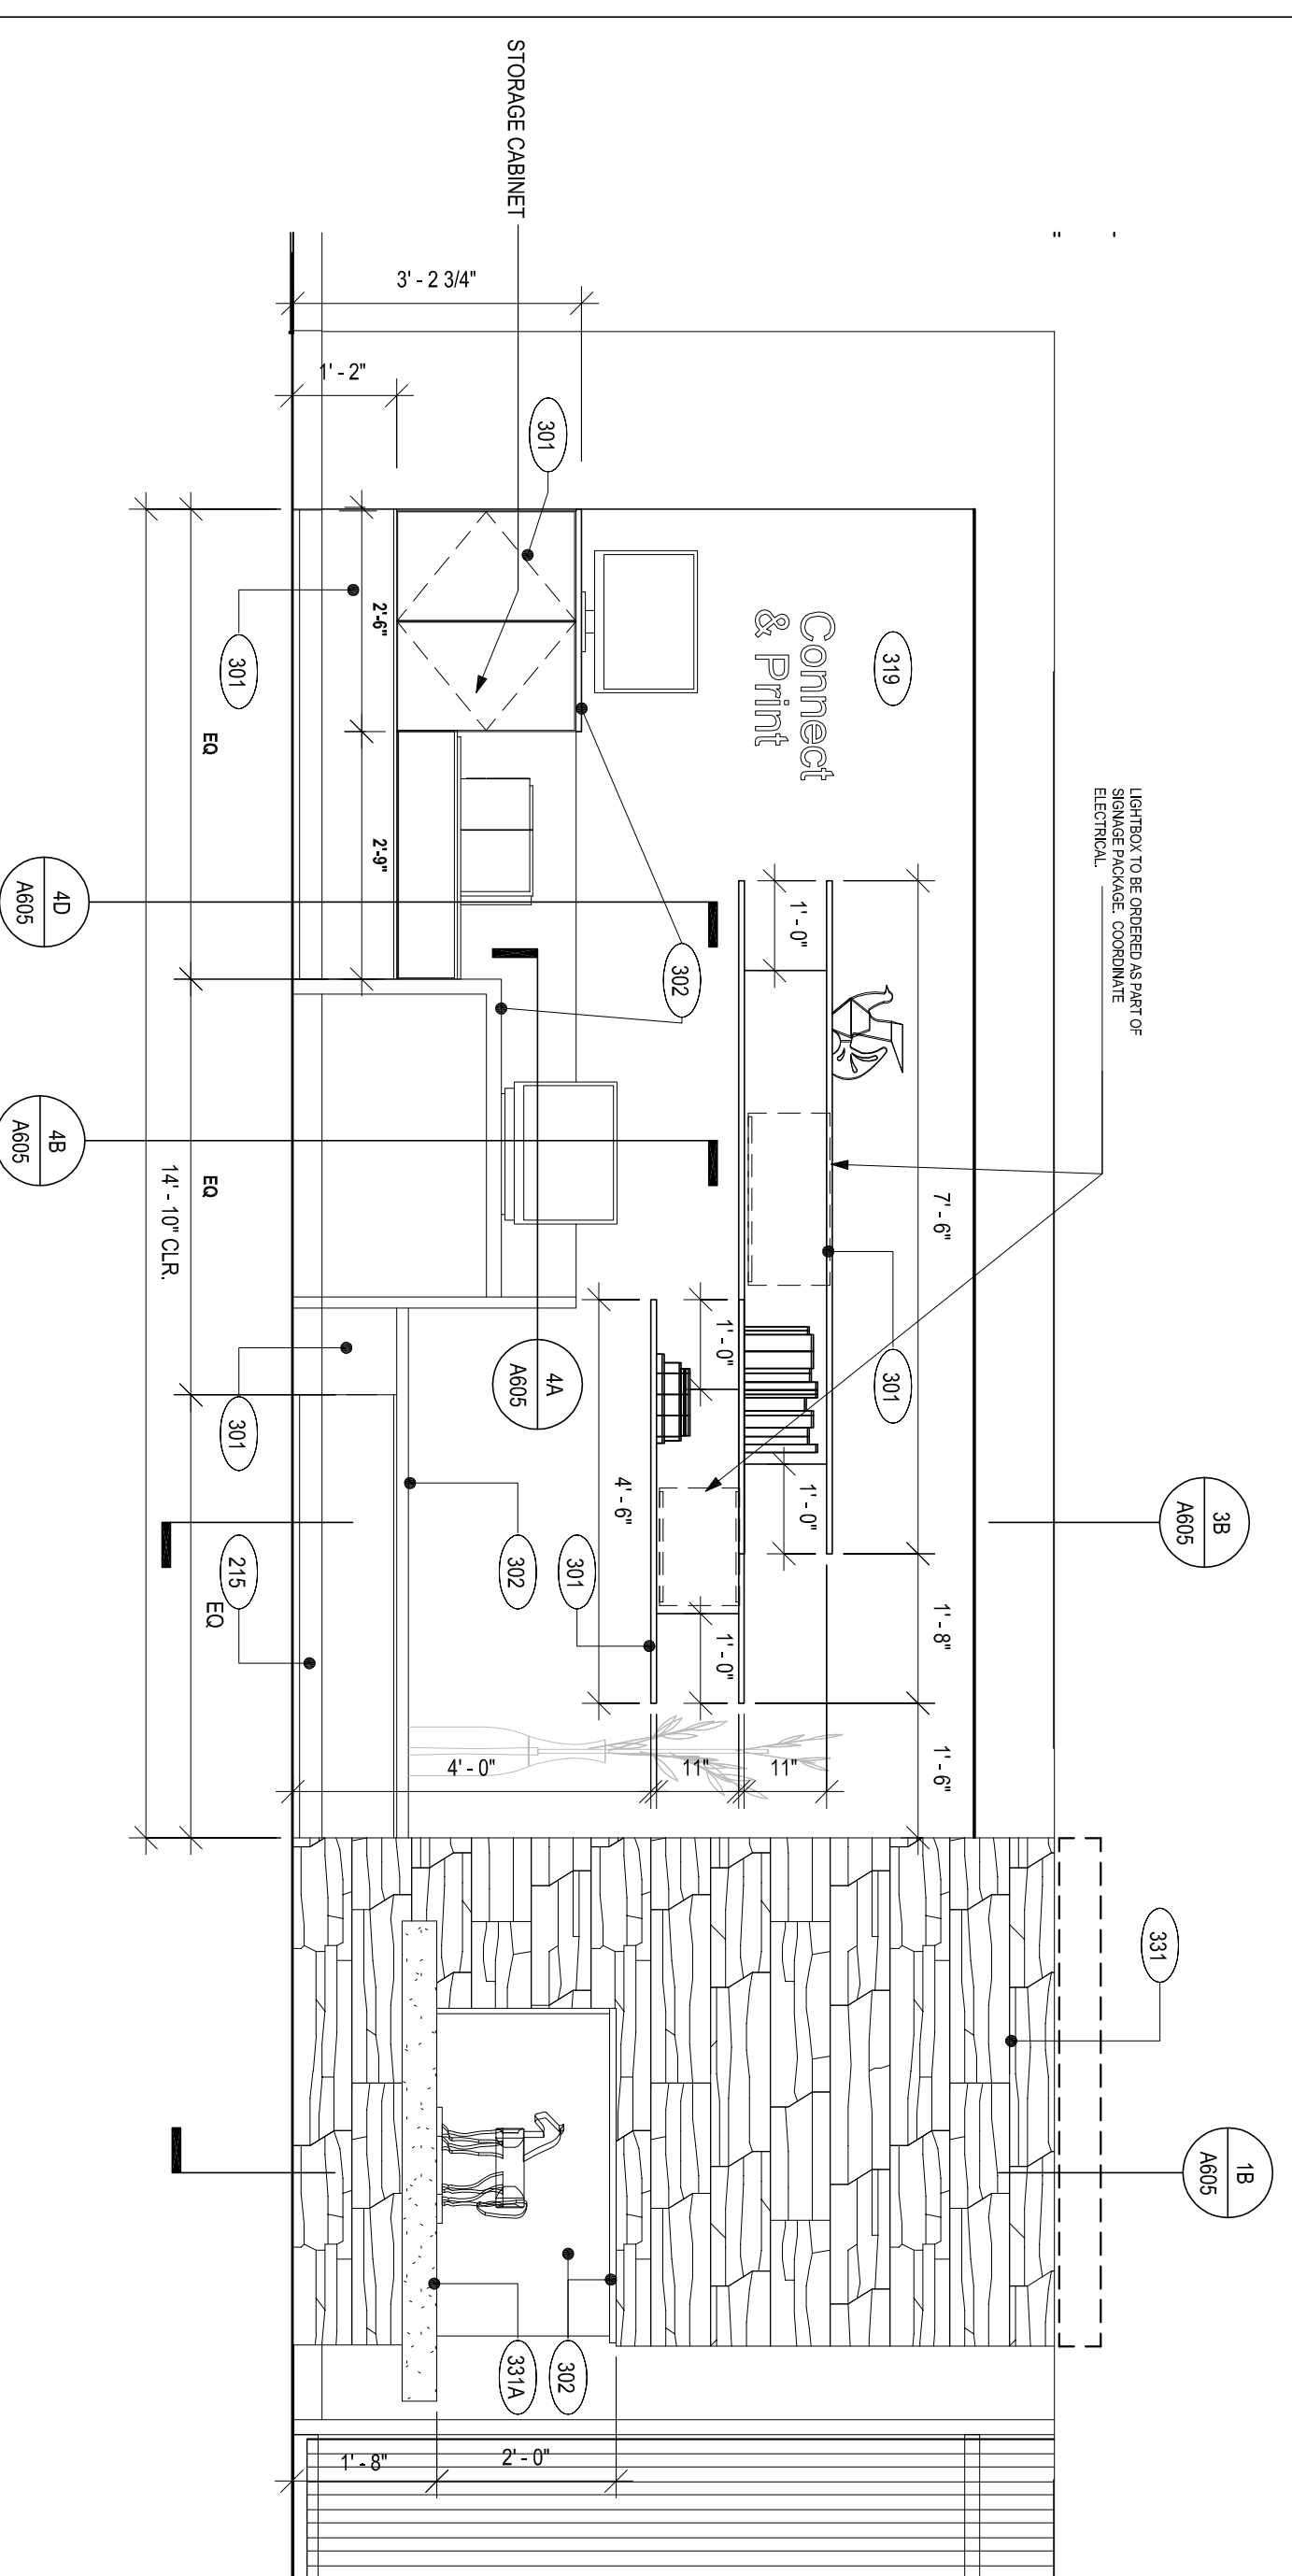
SEAL

CULTURED STONE  
STONE HEARTH  
CUT OUT IN CABINET FOR TRASH  
CONNECT AND PRINT SIGNAGE (BY OWNER)  
STONE COUNTERTOP  
CUT OUT IN CABINET FOR TRASH  
PRINTER CABINET



3C CONNECT AND PRINT/LIVING ROOM

LIGHTING TO BE ORDERED AS PART OF  
SERVICE PACKAGE COMPONENT  
BY OWNER

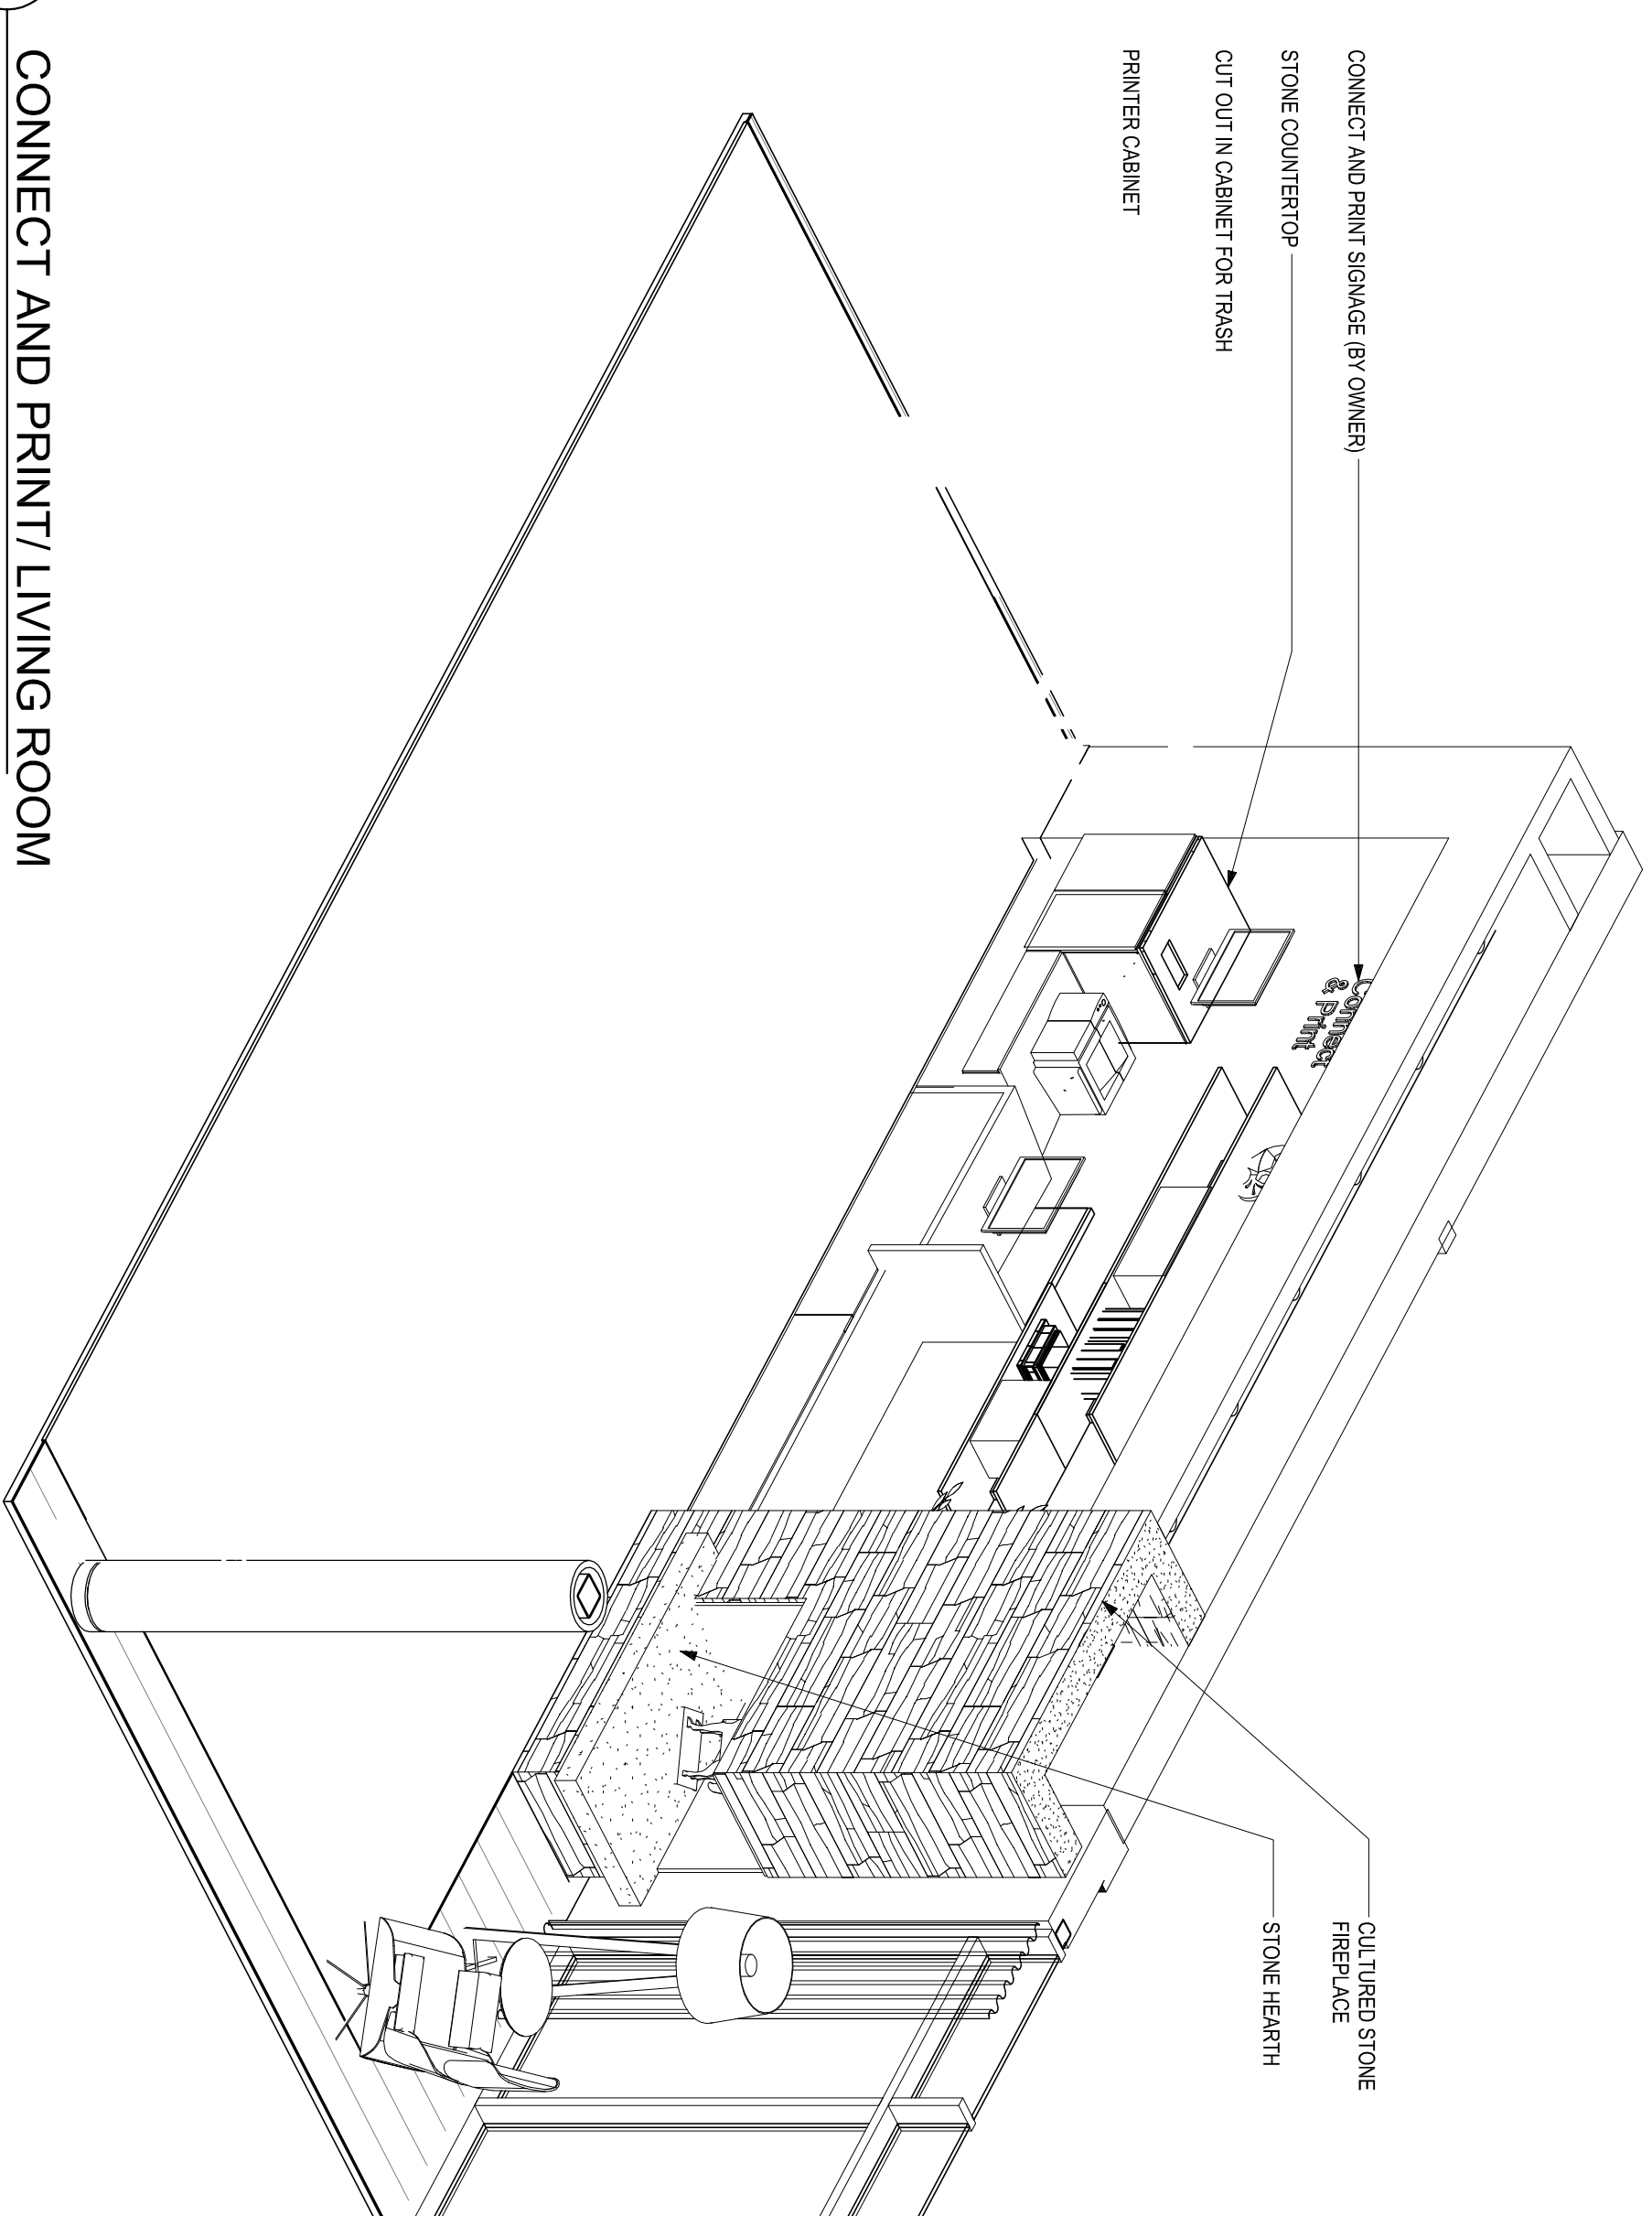

3A CONNECT AND PRINT WALL  
SCALE 1/2"=1'-0"

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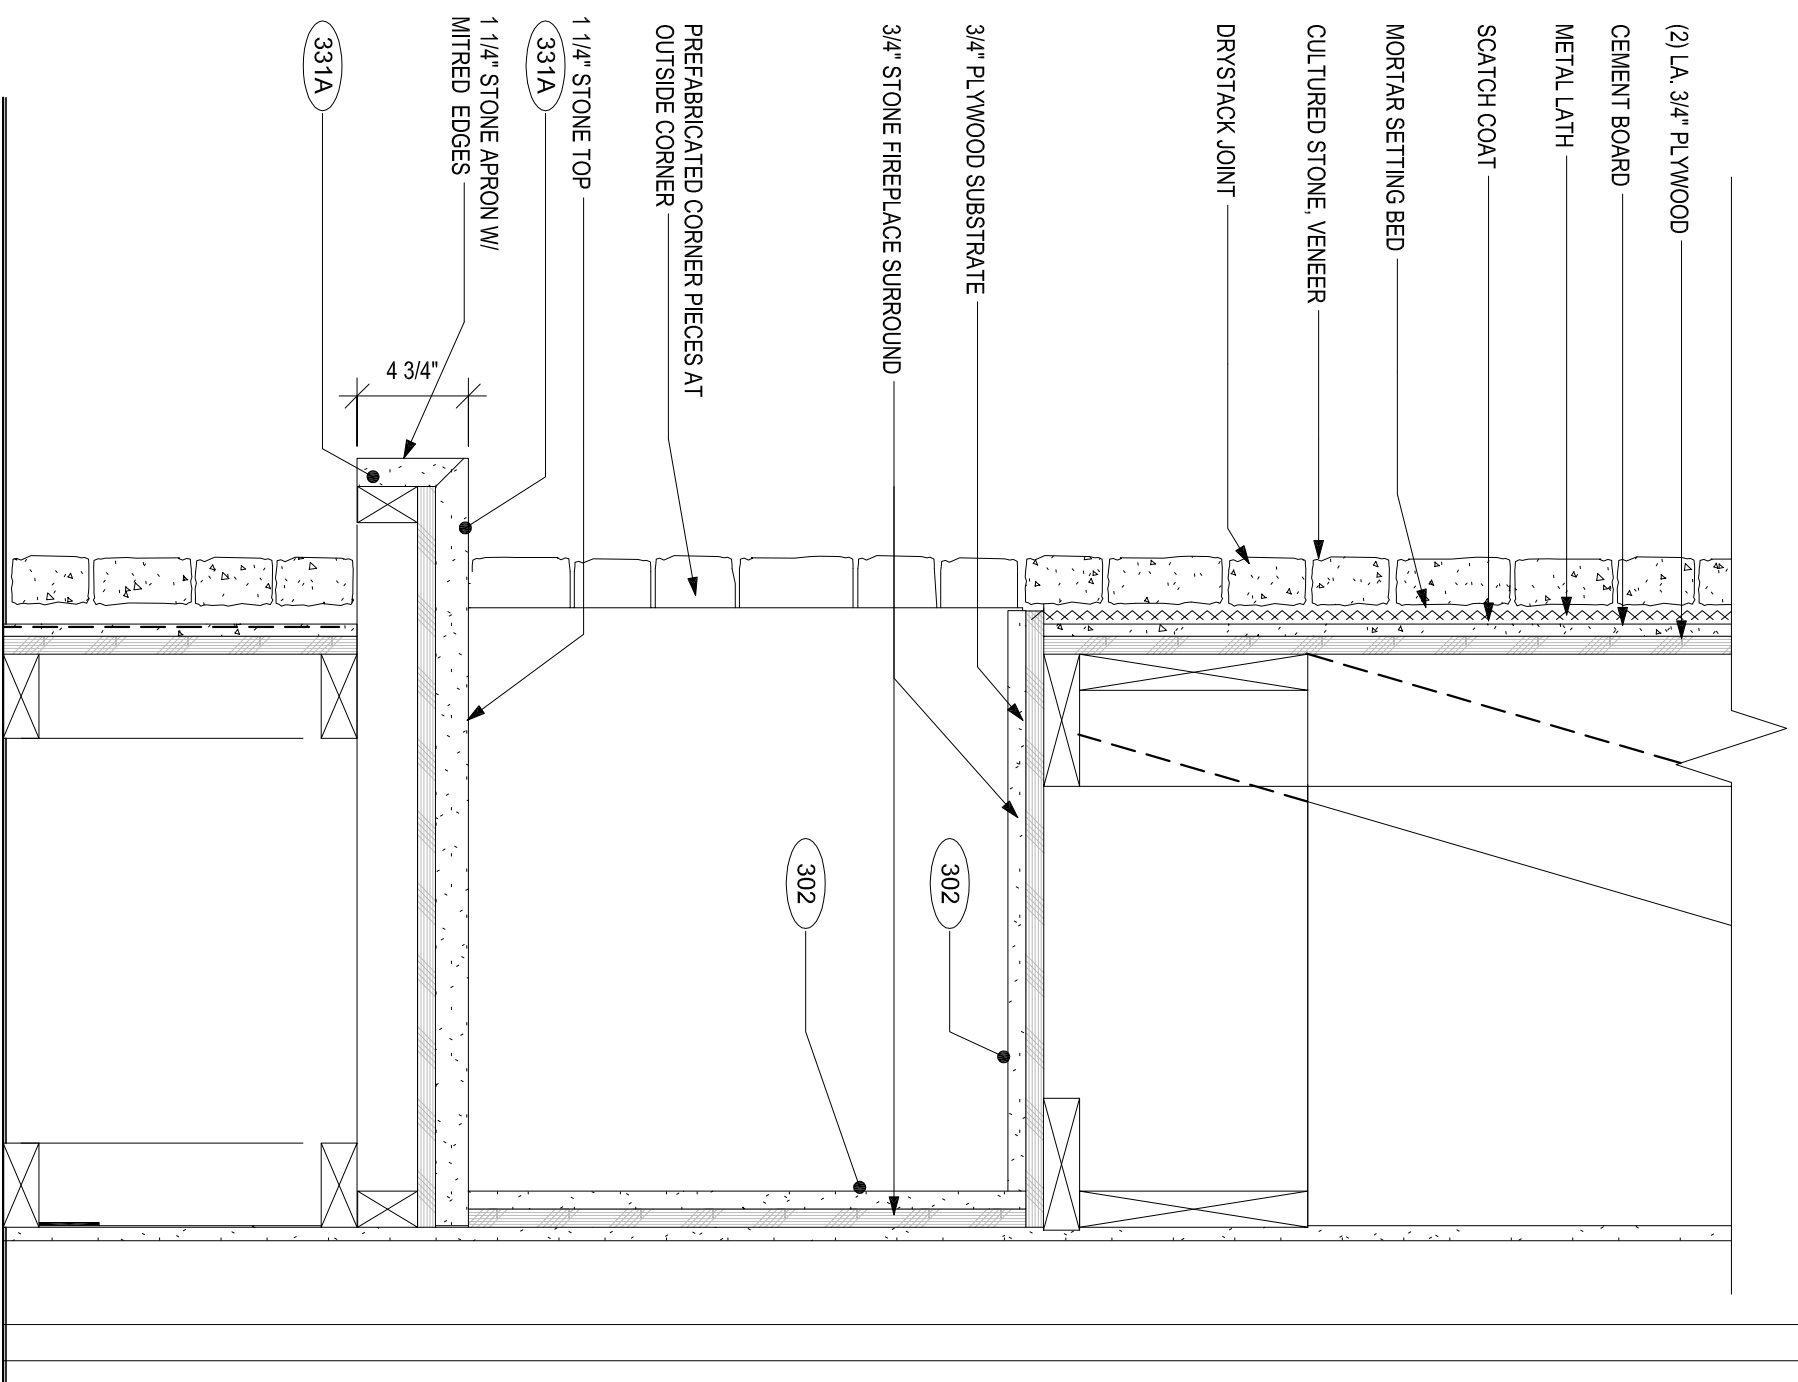
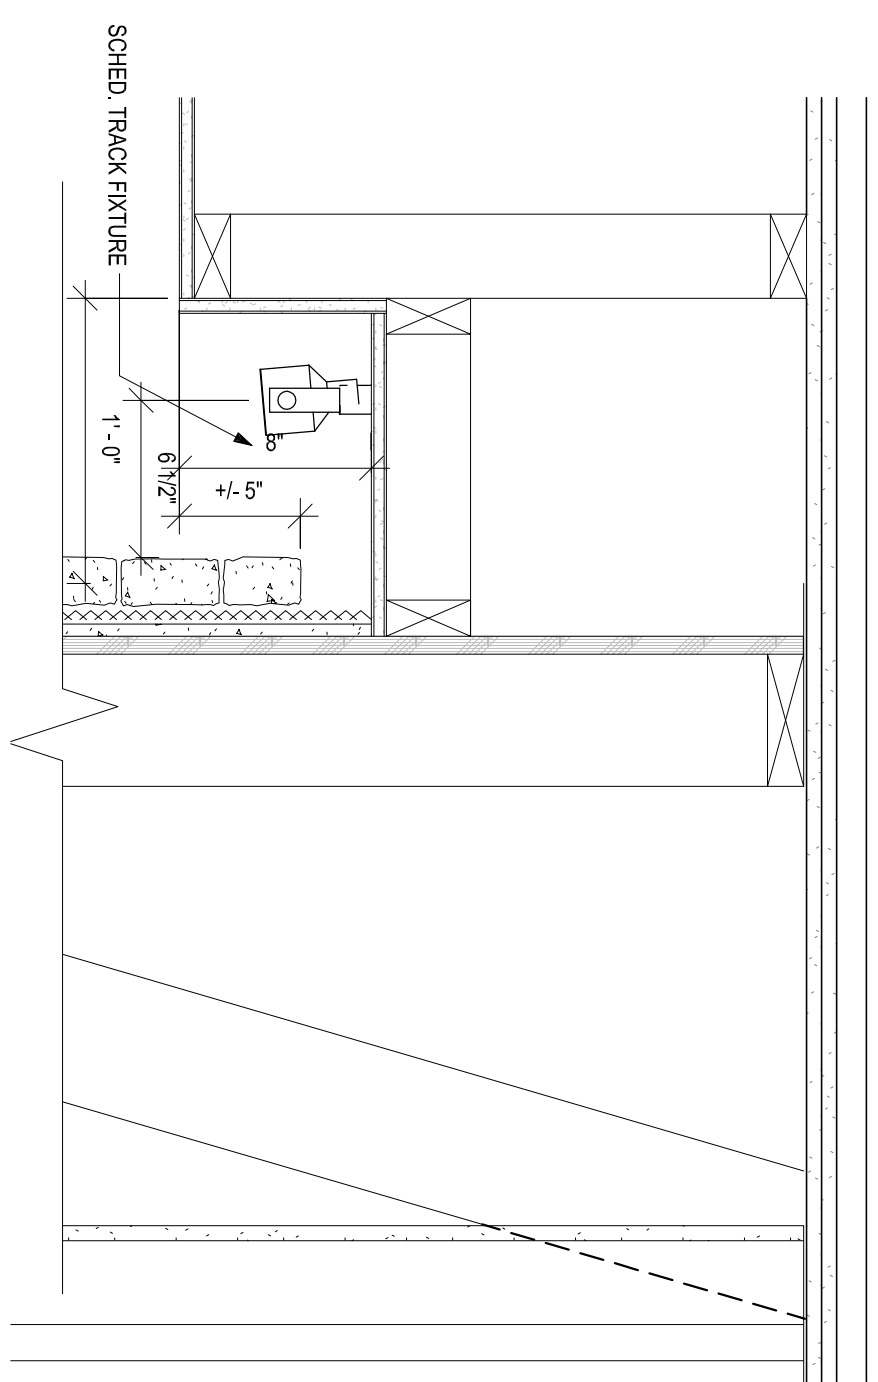
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2	11/22/2015	90% REVIEW SET
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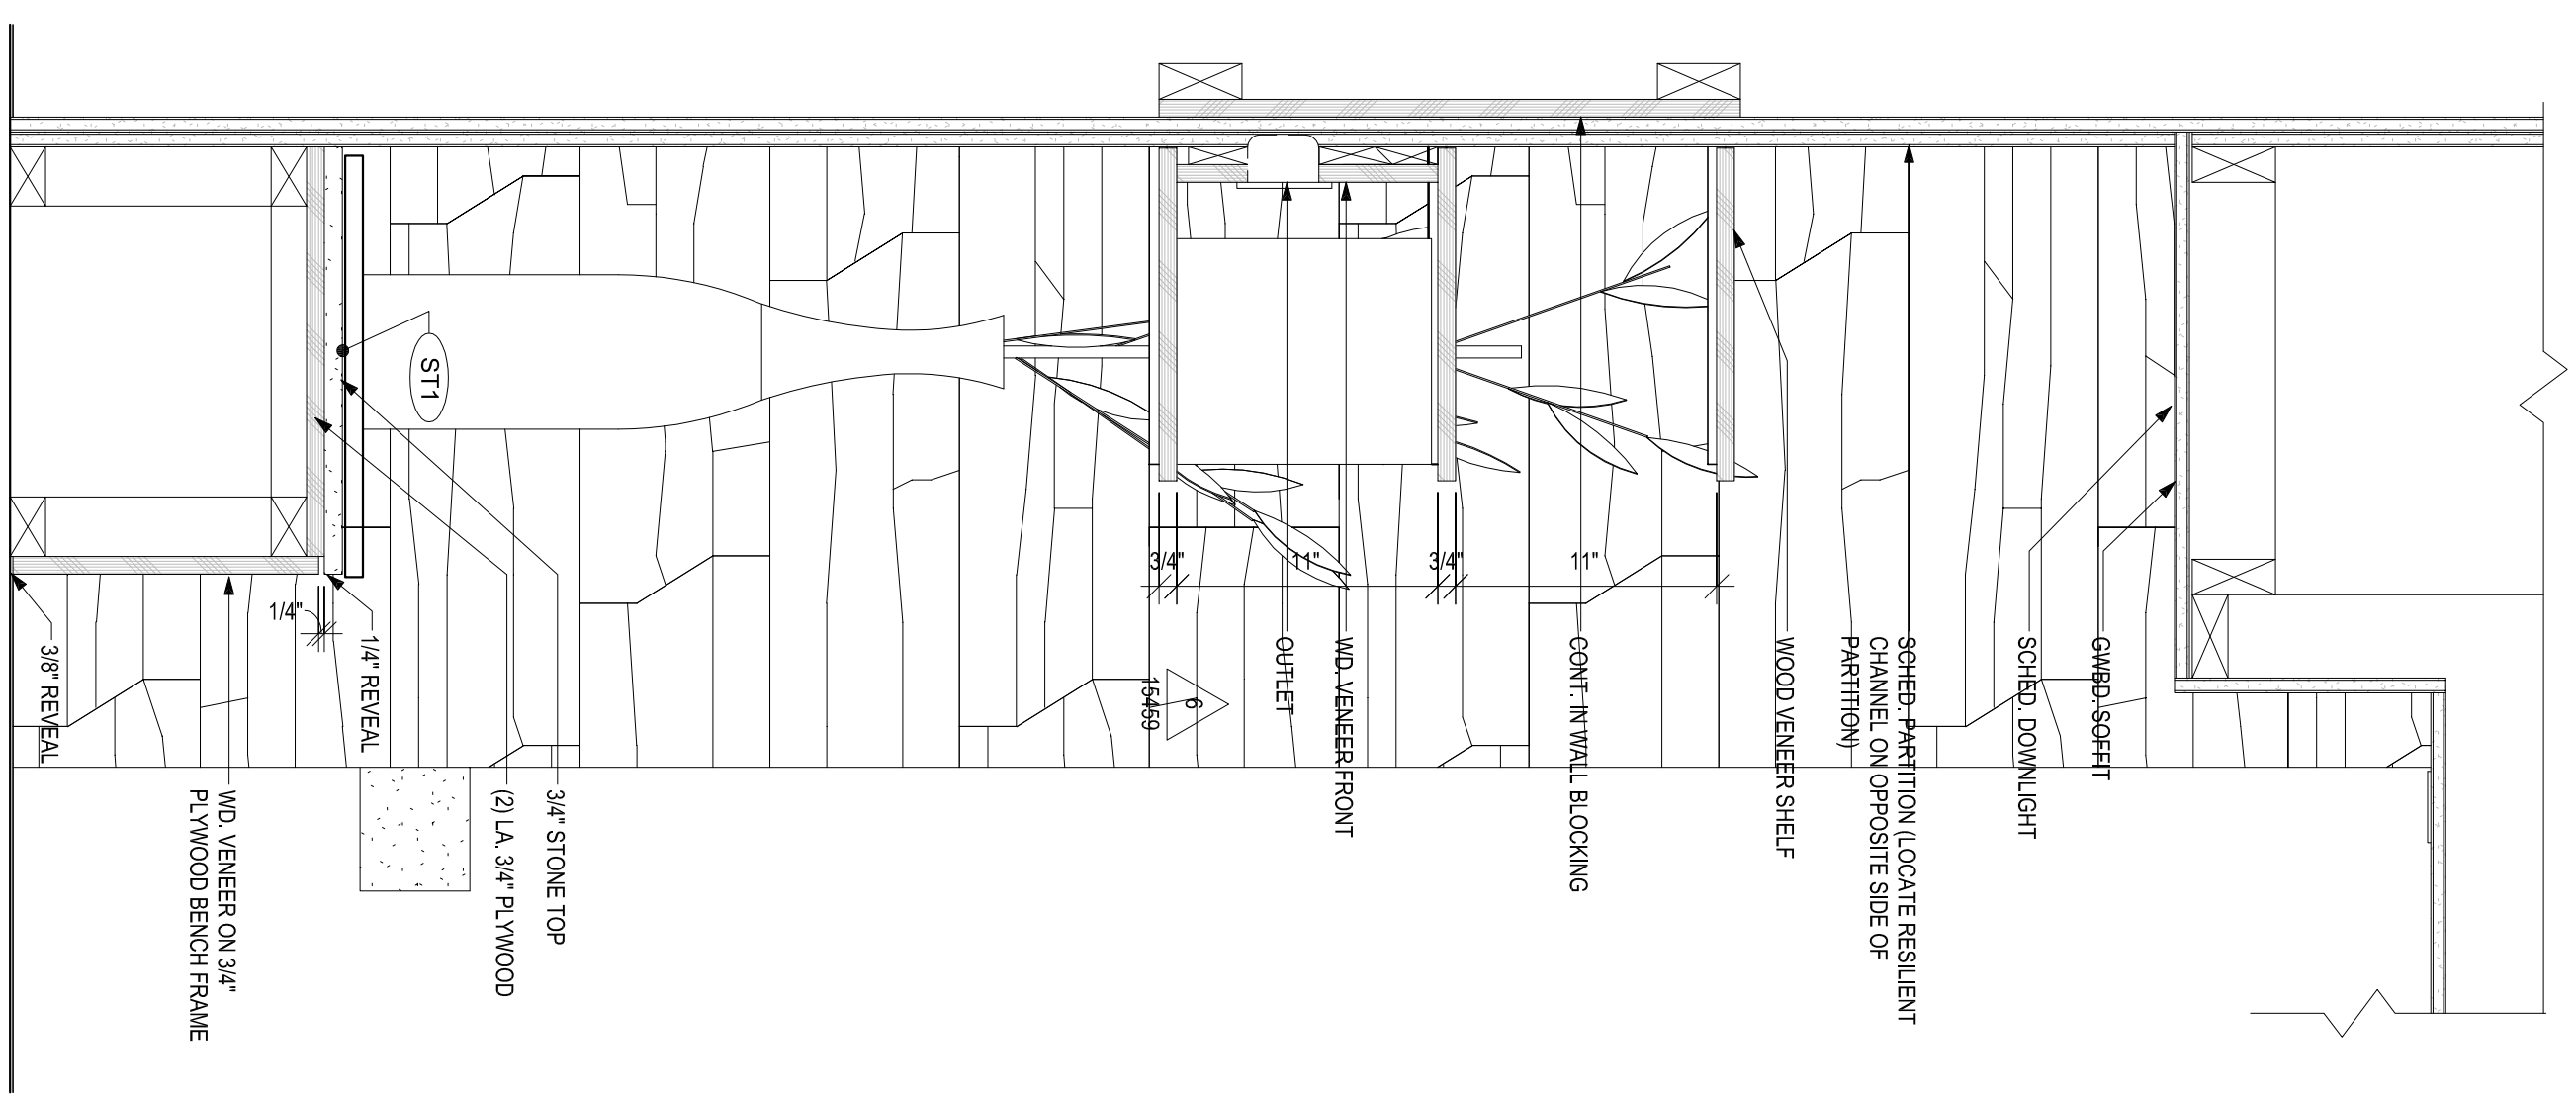
PROJECT NAME:	
DRAWING NUMBER:	A604
DRAWING NAME:	CONNECT AND PRINT WALL
SHEET NAME:	CONNECT AND PRINT DETAILS
DRAWN BY:	BBC
CHECKED BY:	BBC
DATE:	12-22-15
SCALE:	AS NOTED

DRAWING NUMBER  
**A604**







**1B FAUX - PLACE**  
SCALE 1 1/2"=1'-0"




**3B CONNECT & PRINT @ BENCH**  
SCALE 1 1/2"=1'-0"

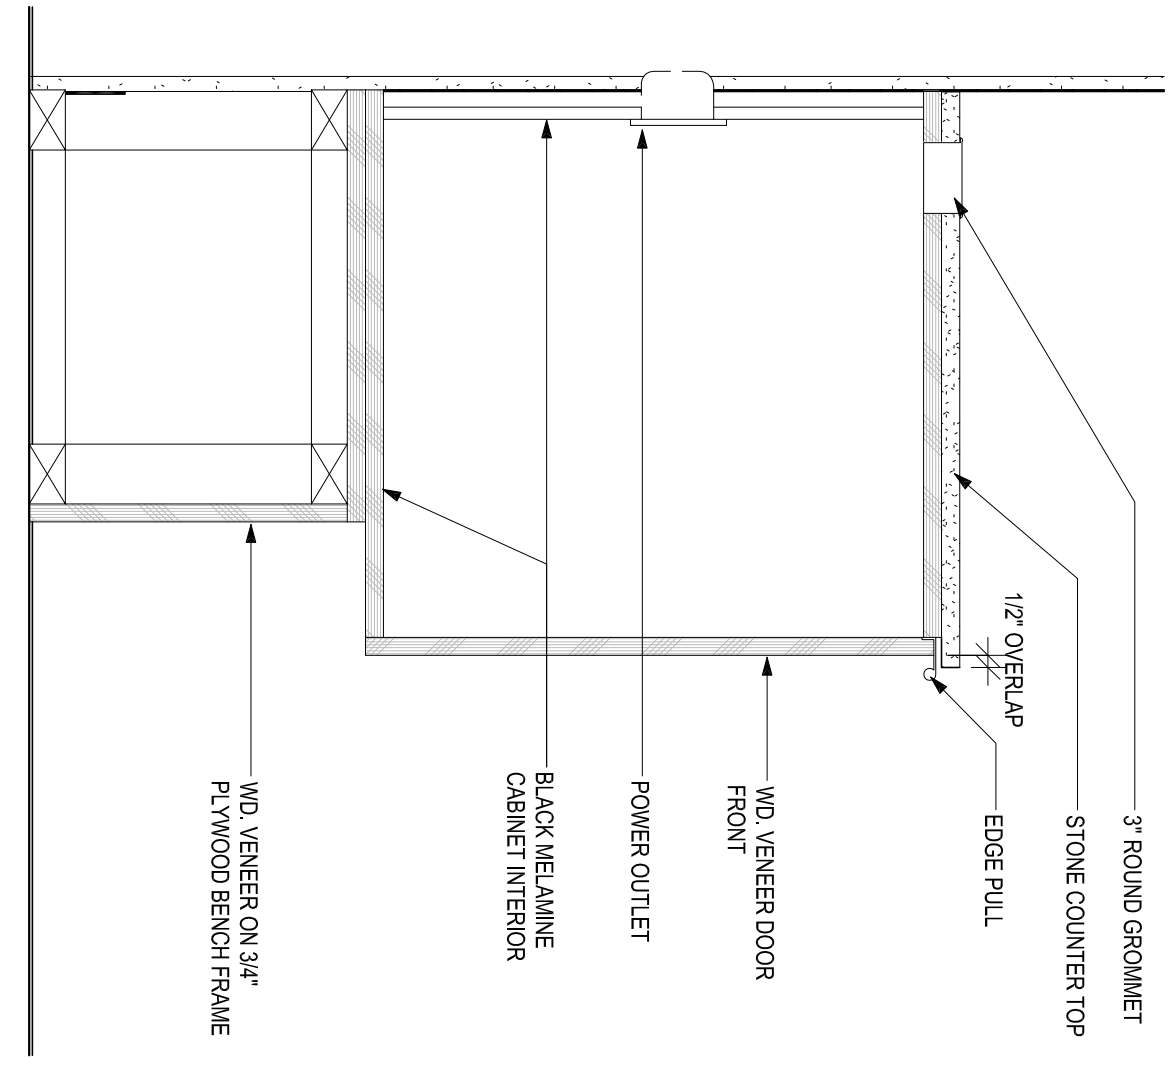


**4D CONNECT & PRINT**  
SCALE 1 1/2"=1'-0"

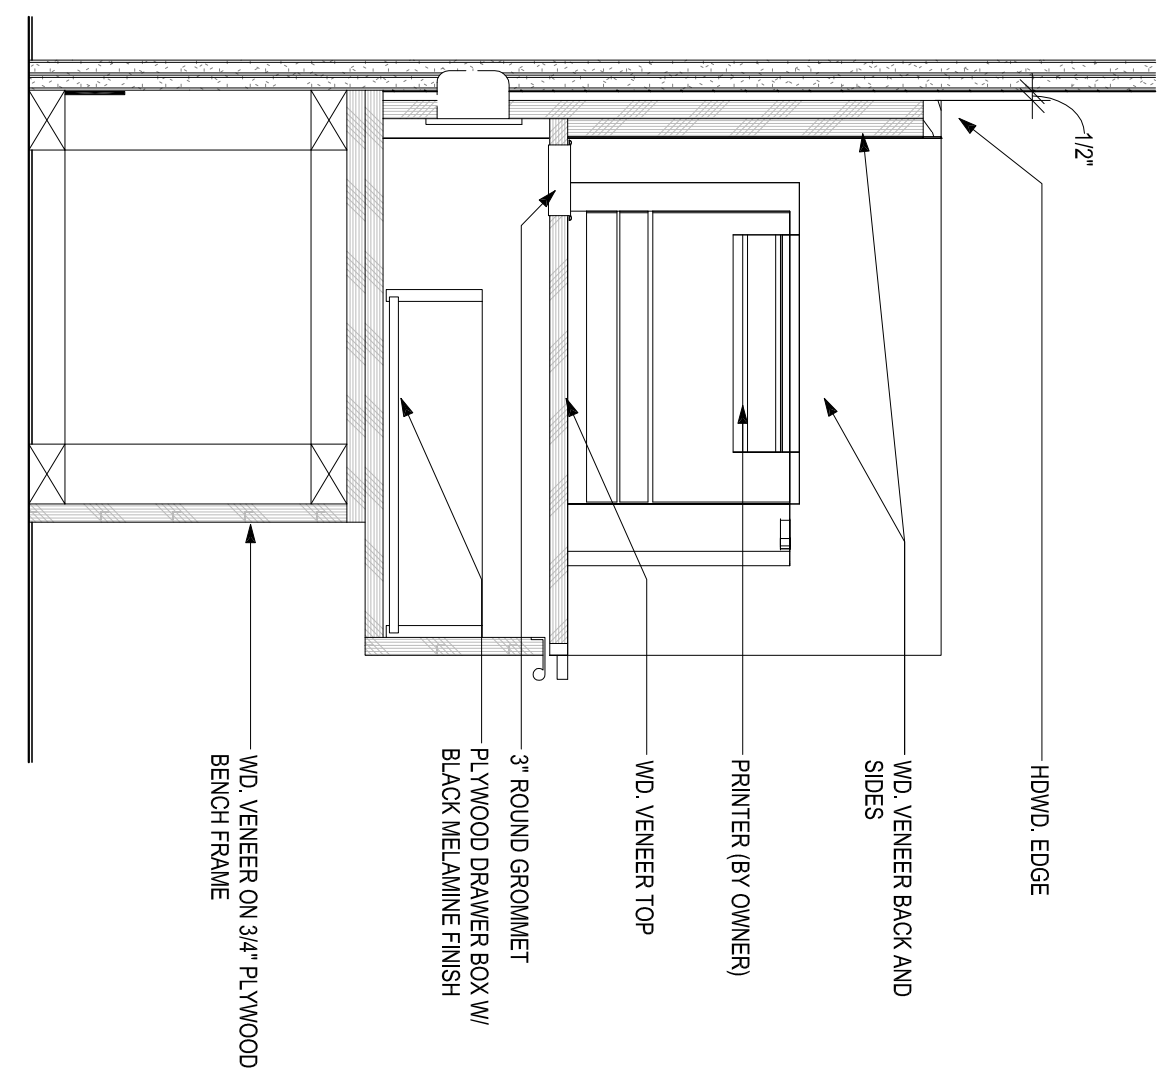

**4B CONNECT & PRINT @ PRINTER**  
SCALE 1 1/2"=1'-0"

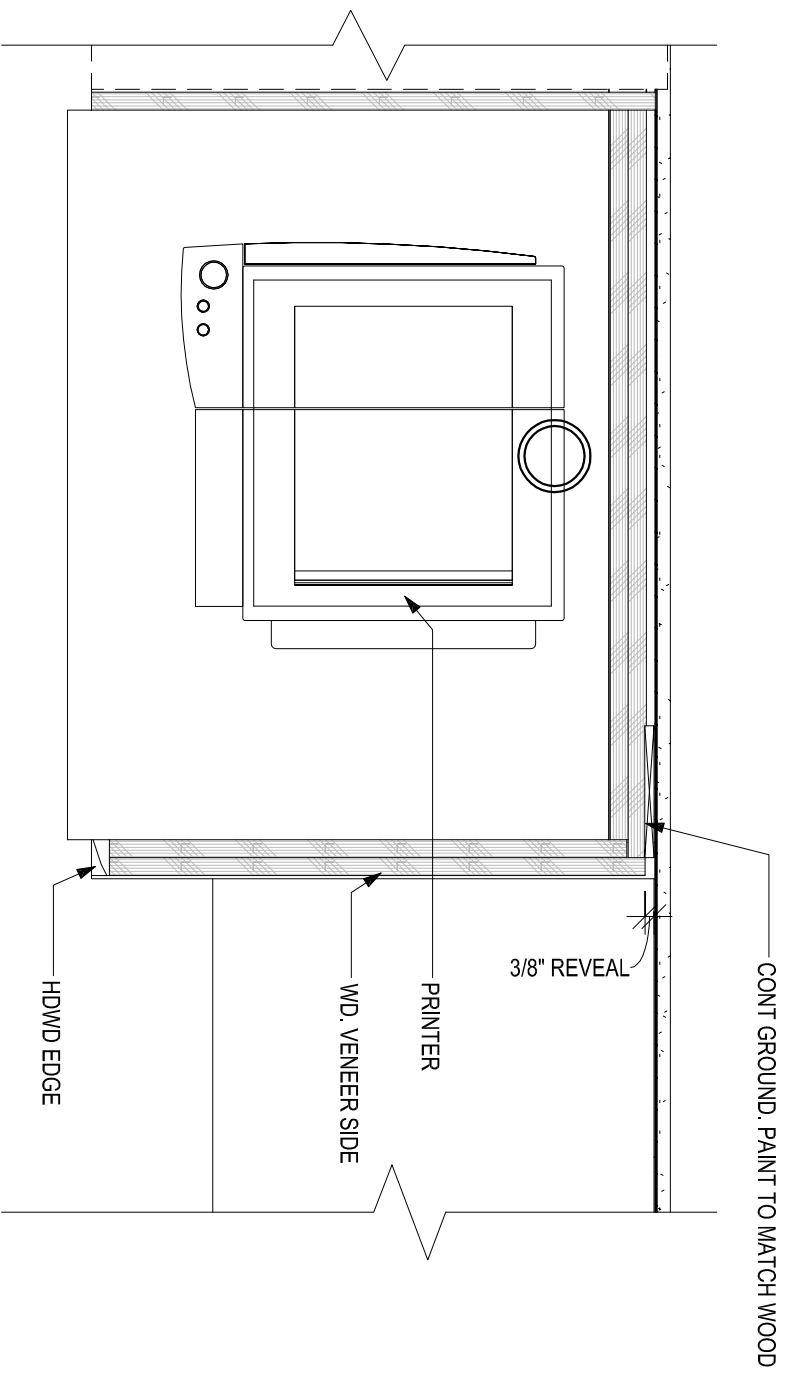

**4A CONNECT & PRINT @ PRINTER**  
SCALE 1 1/2"=1'-0"

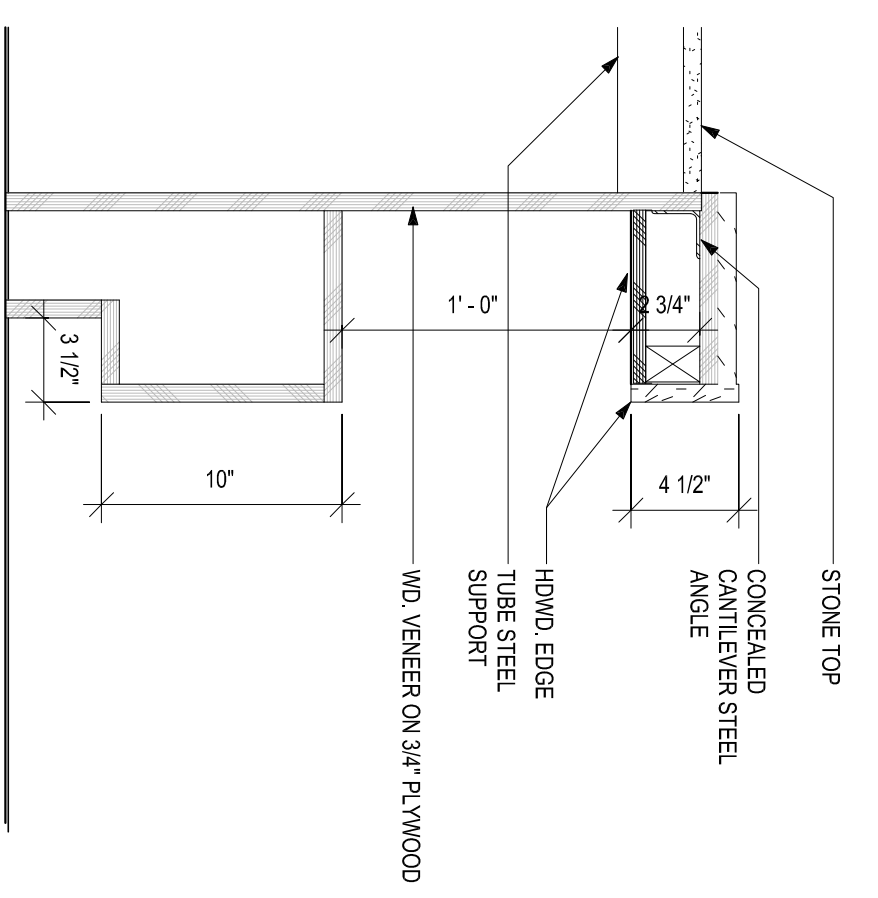

**5A BUSINESS DESK FRONT**  
SCALE 1 1/2"=1'-0"

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1	08/20/15	30% REVIEW SET
2	11/22/2015	50% REVIEW SET
3	12/22/2015	100% REVIEW SET

PROJECT NAME:

PROJECT NUMBER: 15180

DRAWING NAME:


SHEET NAME:

CONNECT & PRINT DETAILS


DRAWN BY: NK, BBC  
CHECKED BY: BBC  
DATE: 12-22-15  
SCALE: AS NOTED

DRAWING NUMBER  
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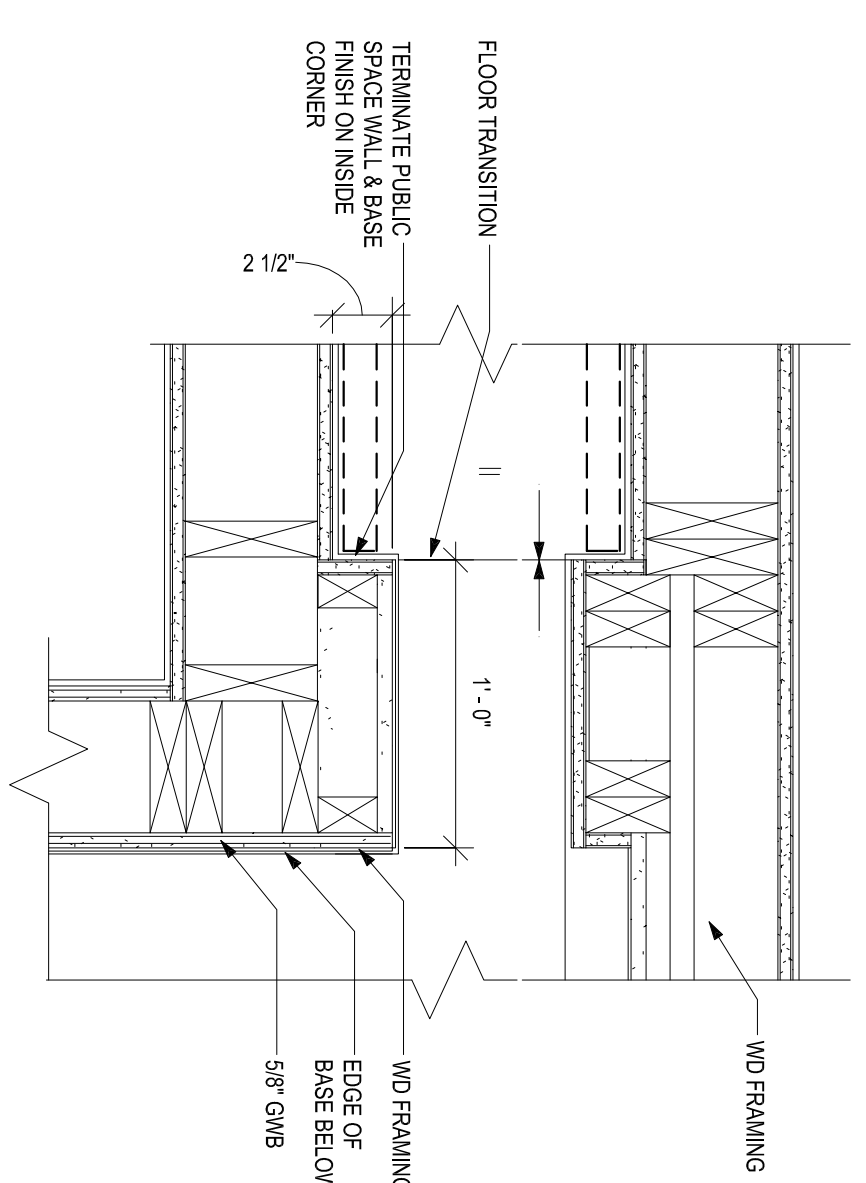


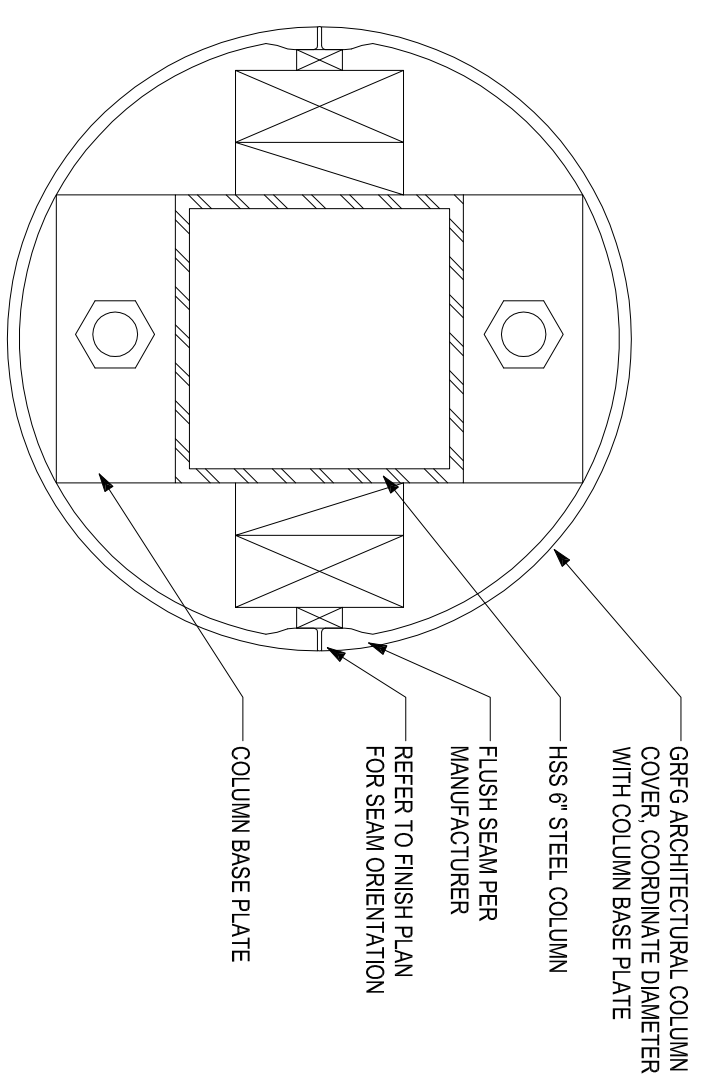


1D RECEPTION COLUMN DETAIL  
SCALE 3/8"=1'-0"

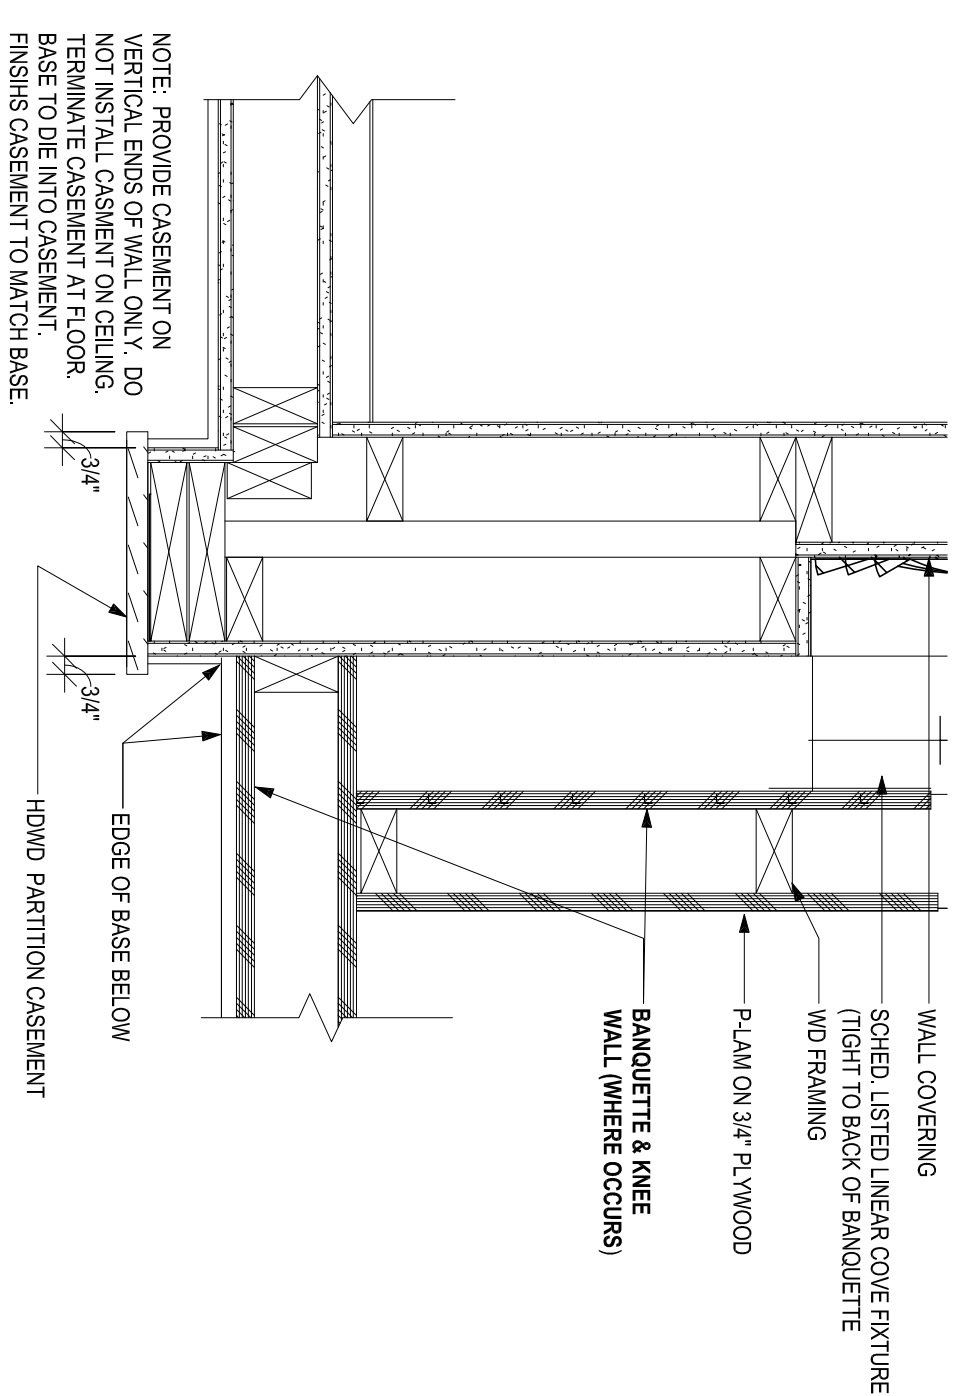


3D BREAKFAST CORNER DETAIL ELEVATOR LOBBY  
SCALE 1 1/2"=1'-0"




4D CORRIDOR DETAIL  
SCALE 1 1/2"=1'-0"

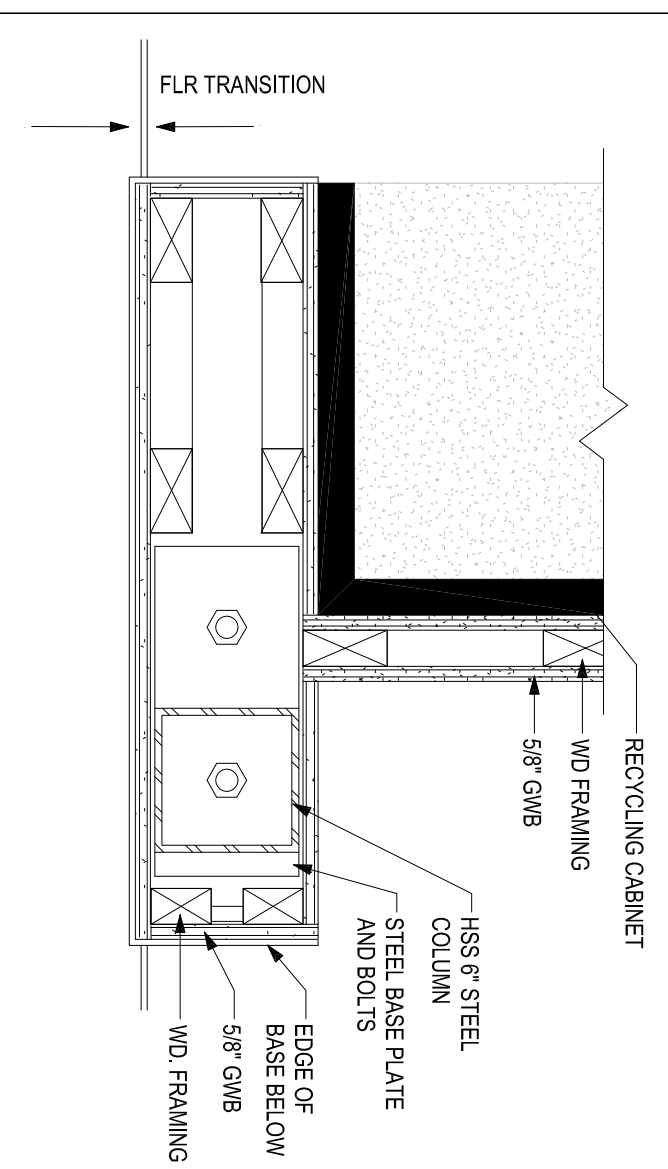


5D BOOTH COLUMN ENCLOSURE DETAIL  
SCALE 1 1/2"=1'-0"

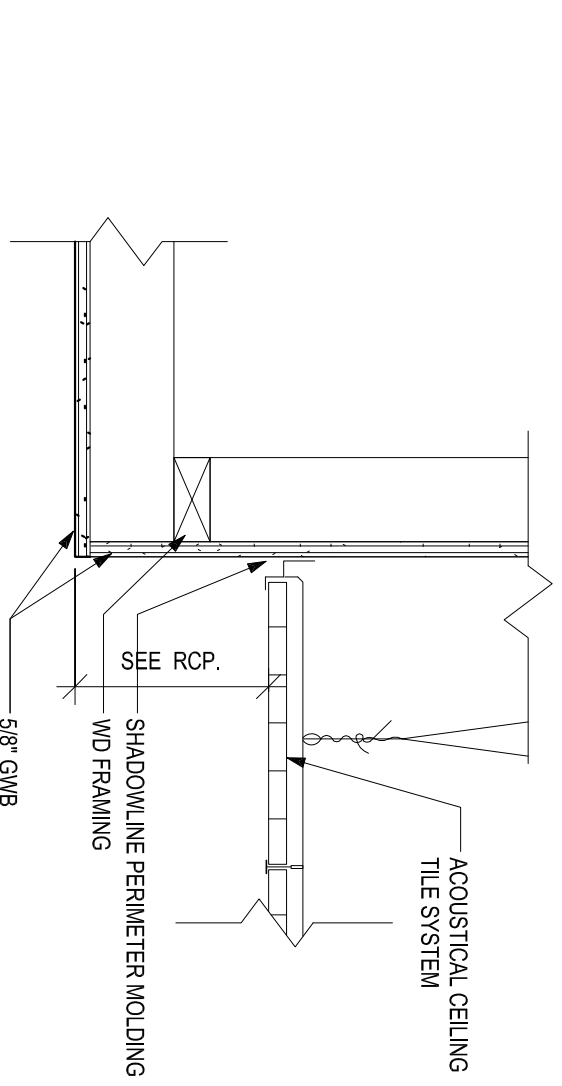


1C SOFFIT  
SCALE 1 1/2"=1'-0"

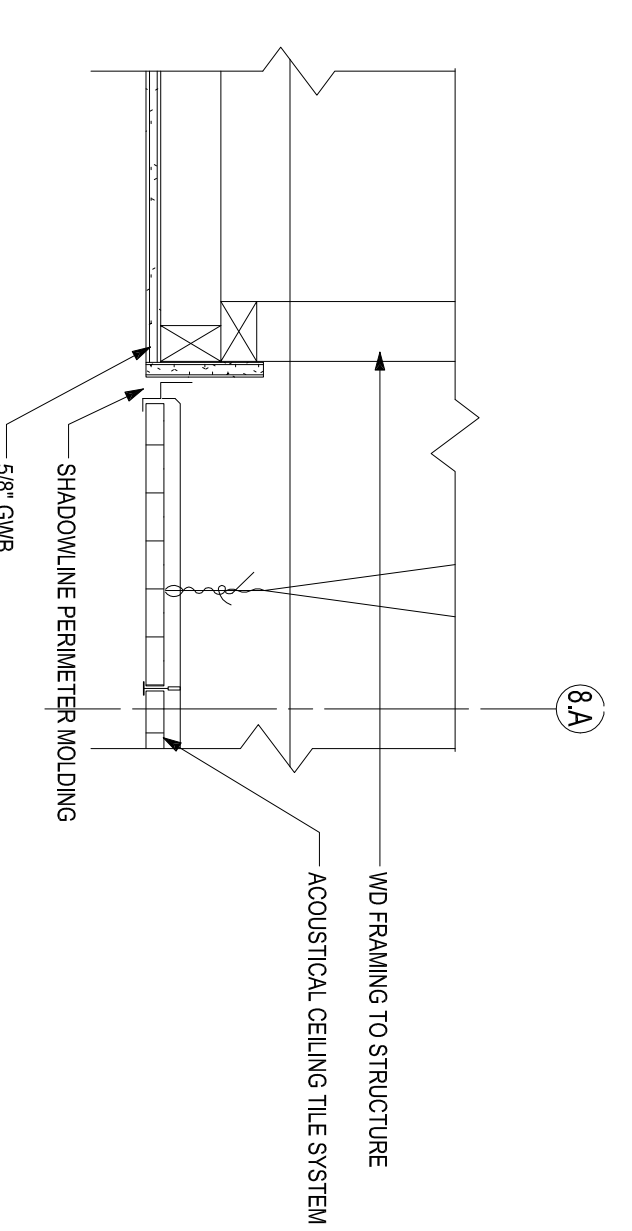


3C TYPICAL CORRIDOR DETAIL  
SCALE 1 1/2"=1'-0"

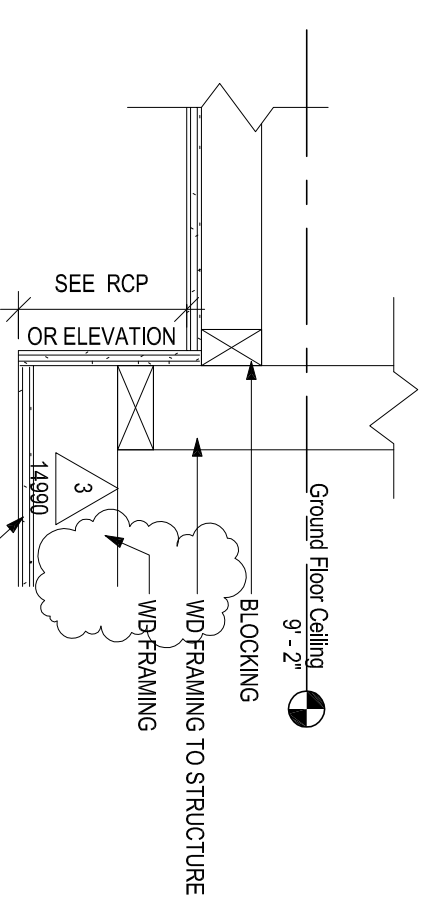


4C SOFFIT @ HARD CEILINGS  
SCALE 1 1/2"=1'-0"

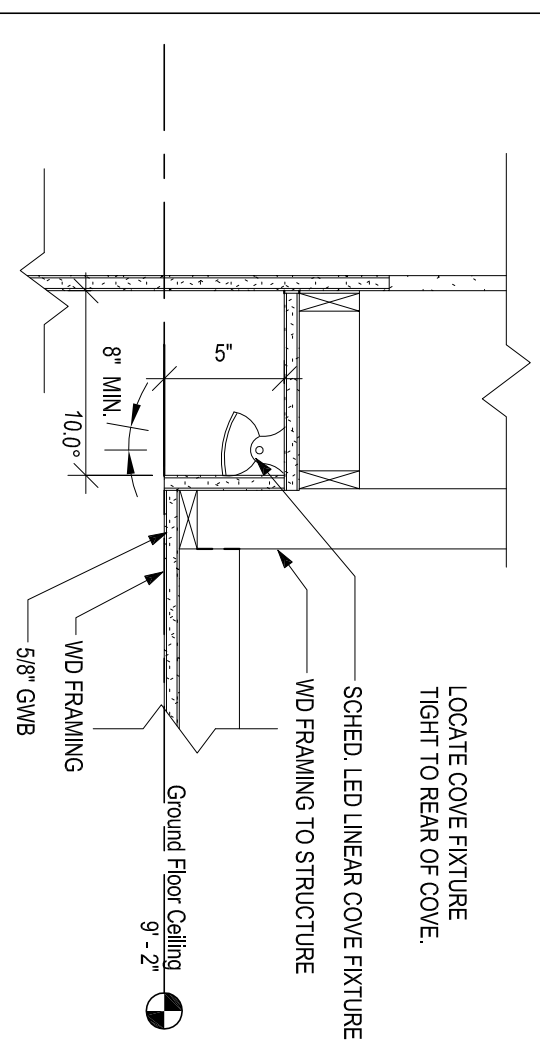


5C CEILING DETAIL @ RECEPTION  
SCALE 1 1/2"=1'-0"

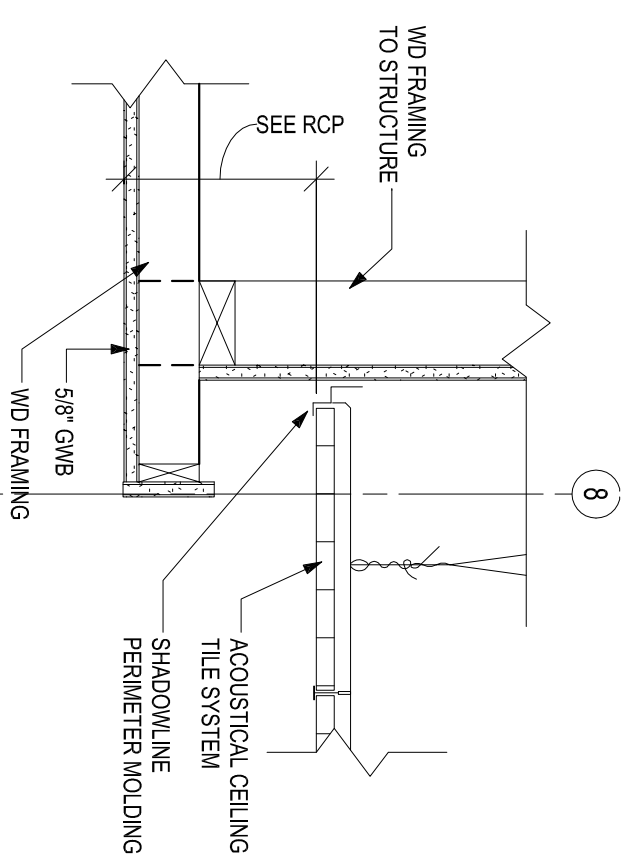


1B SOFFIT @ ELEVATOR LOBBY  
SCALE 1 1/2"=1'-0"

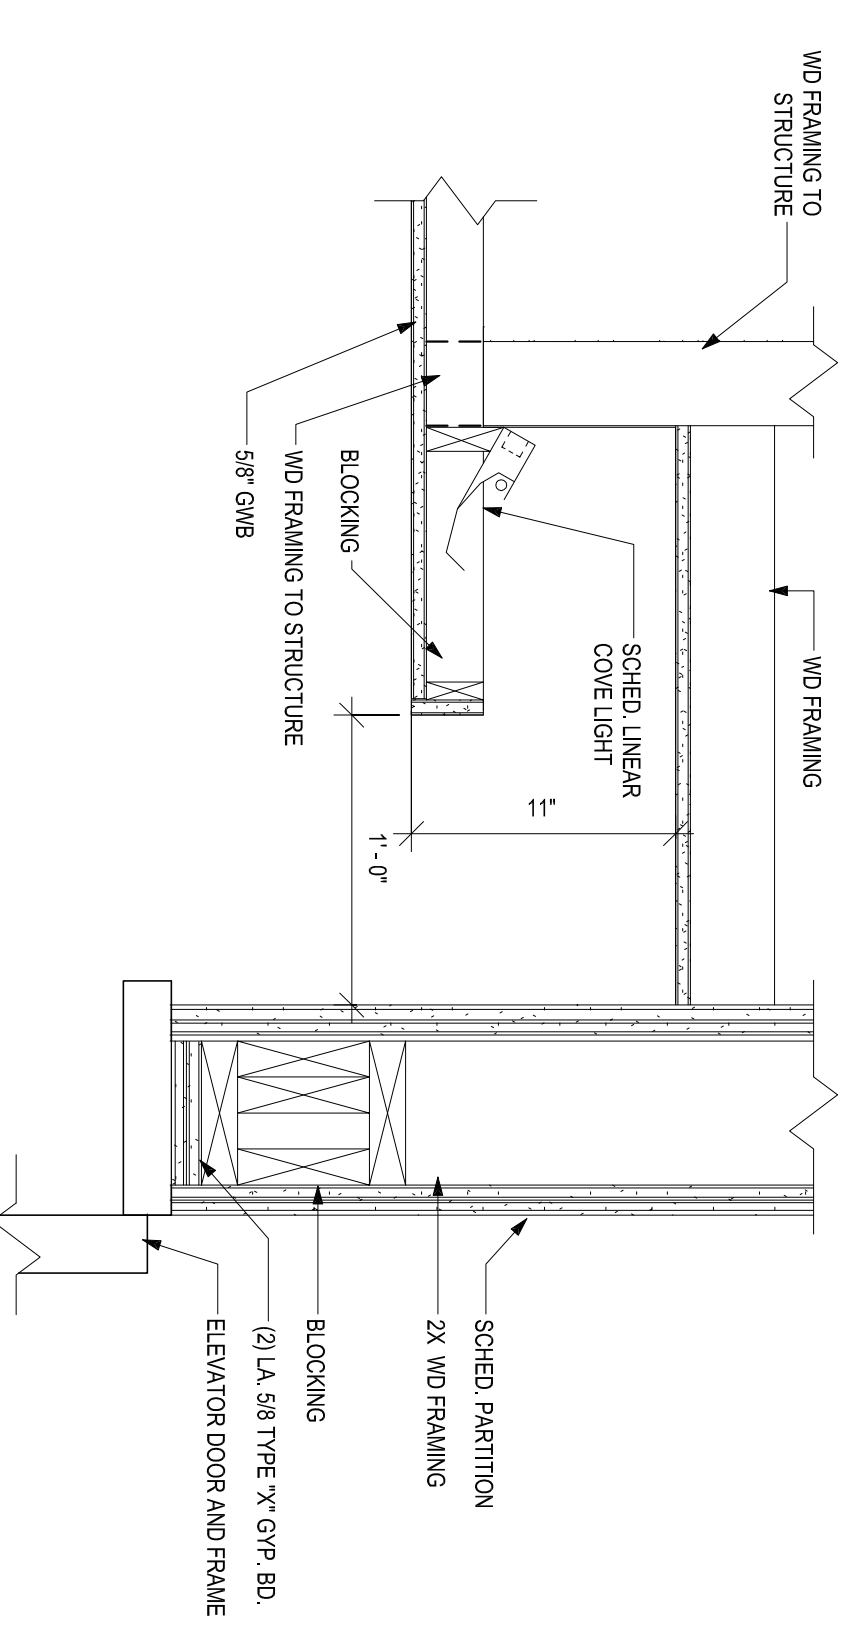


3B LIGHT COVE SOFFIT  
SCALE 1 1/2"=1'-0"

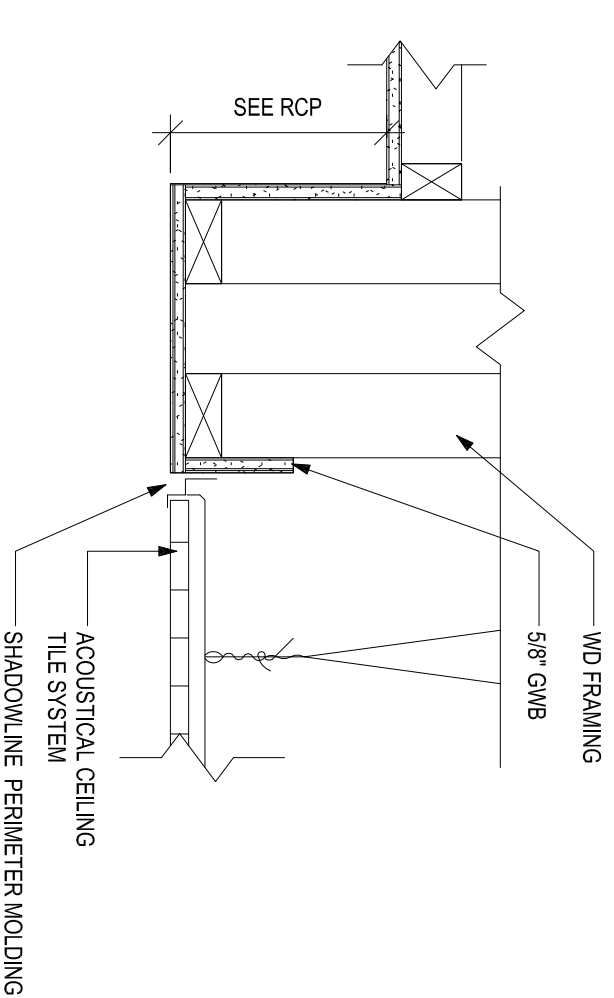


4B GROUND FLOOR CORRIDOR TRANSITION  
SCALE 1 1/2"=1'-0"

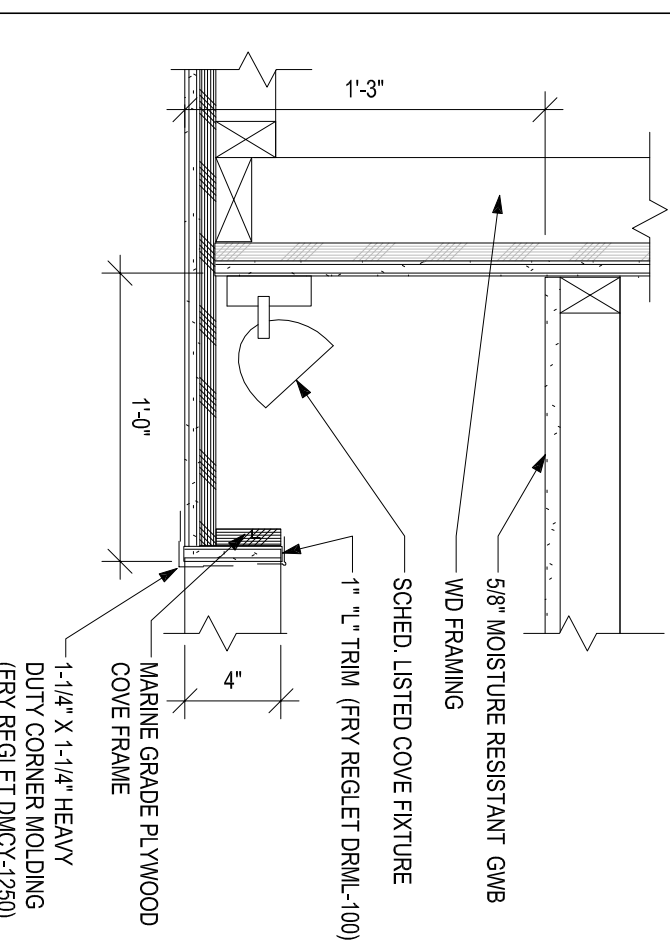


5B INDOOR POOL COVE LIGHT DETAIL  
SCALE 1 1/2"=1'-0"

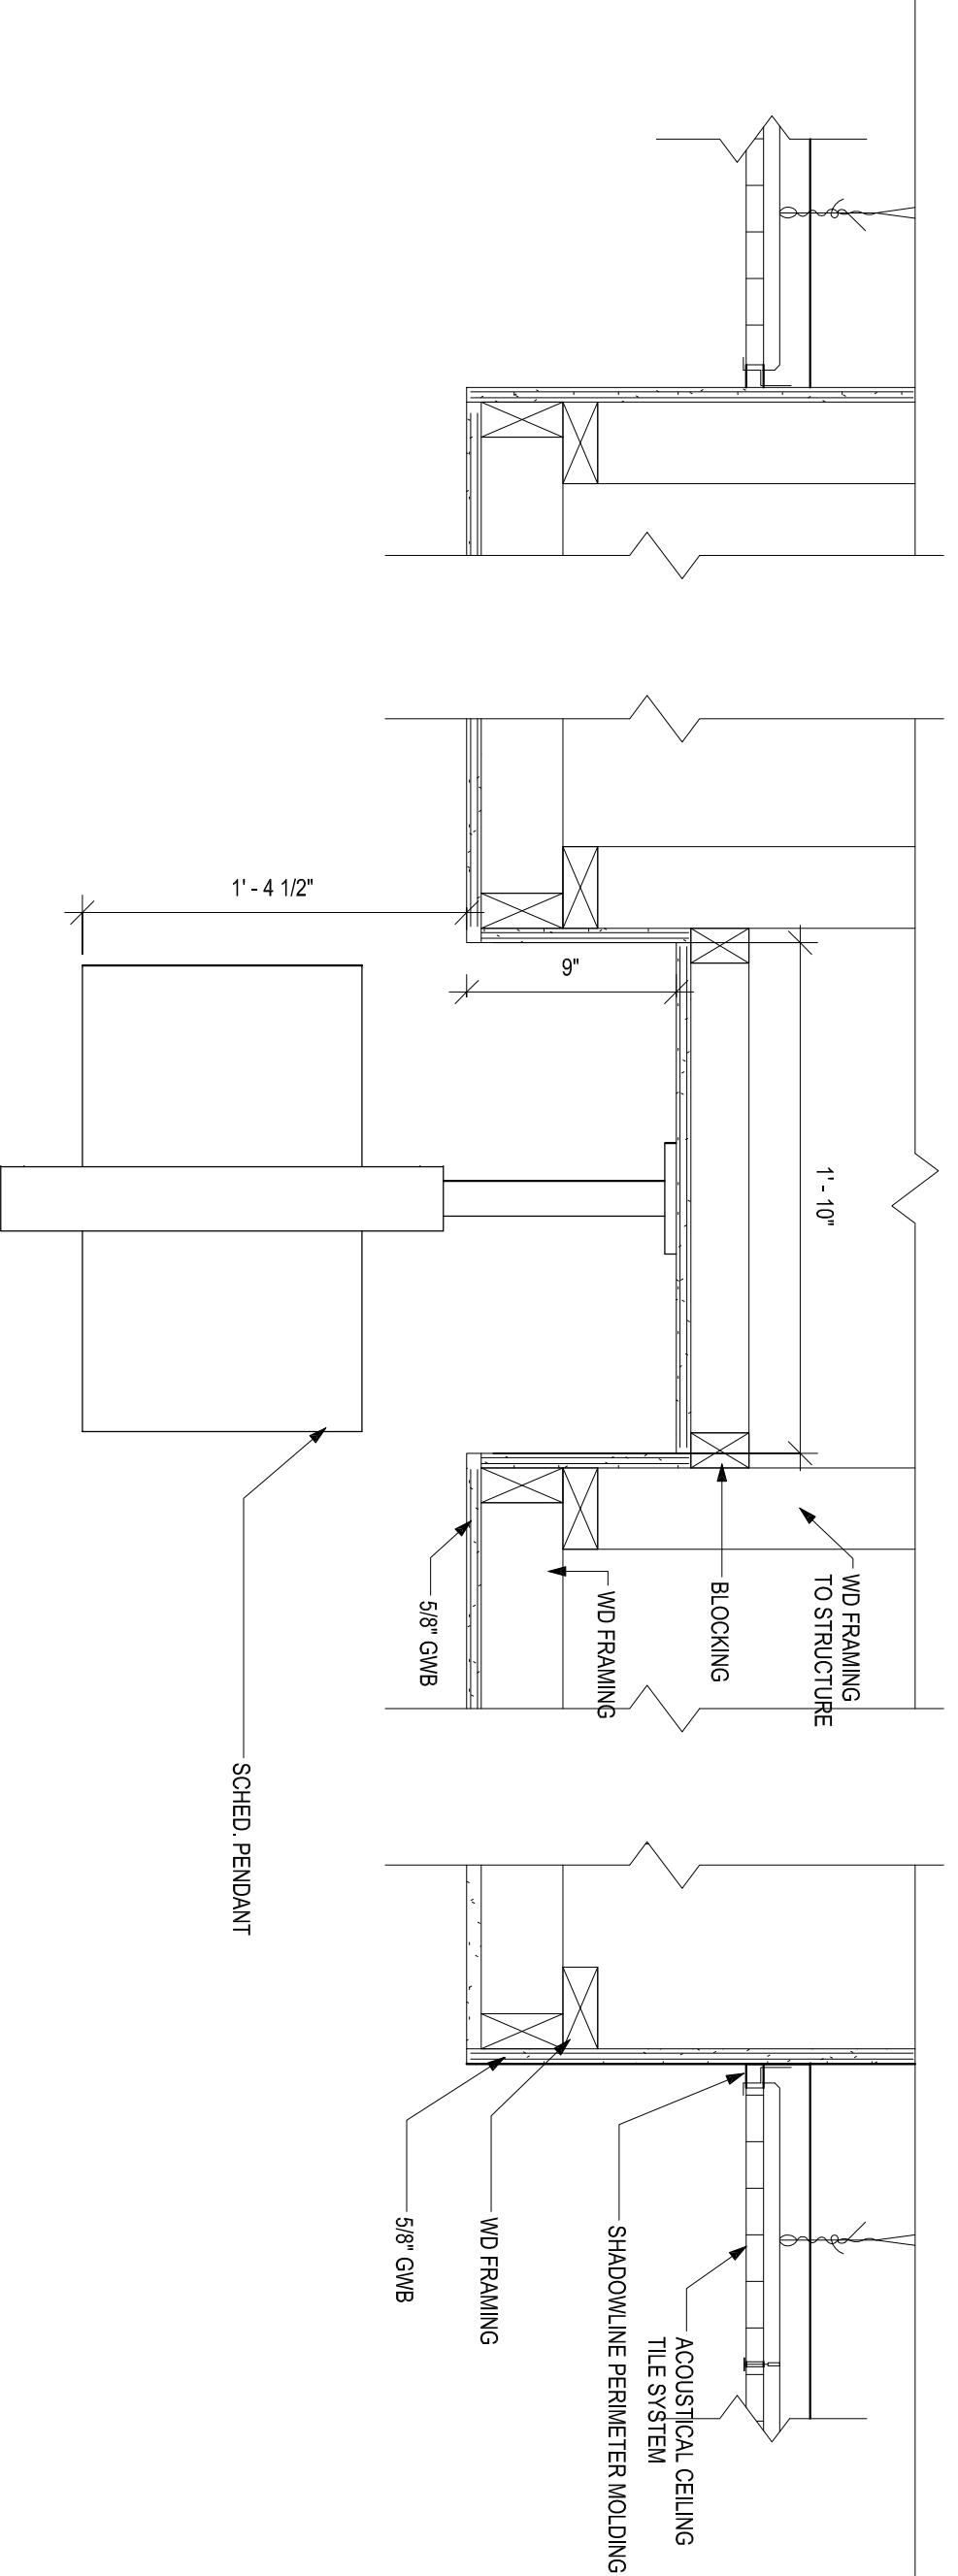

1A SOFFIT @ BREAKFAST TABLE  
SCALE 1 1/2"=1'-0"

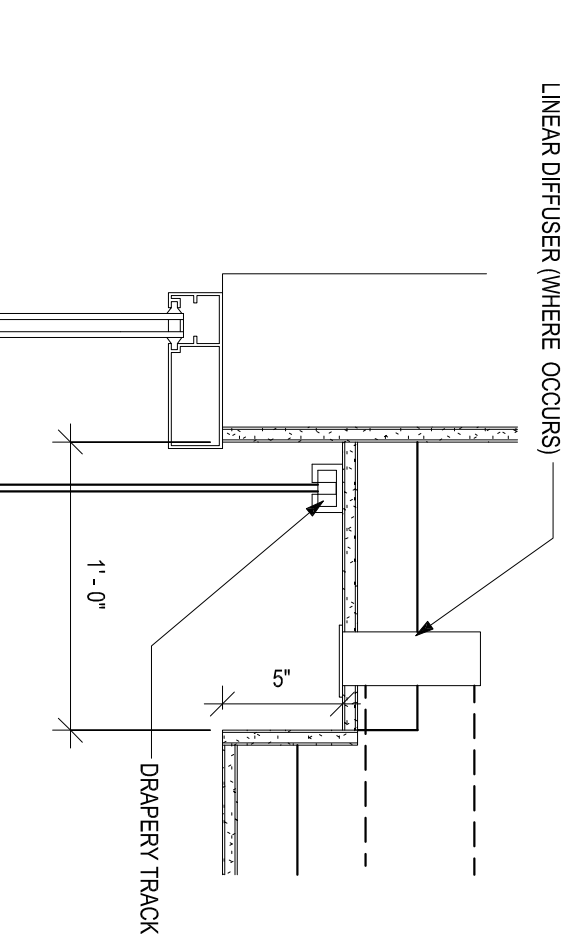

4A DRAPERY POCKET  
SCALE 1 1/2"=1'-0"

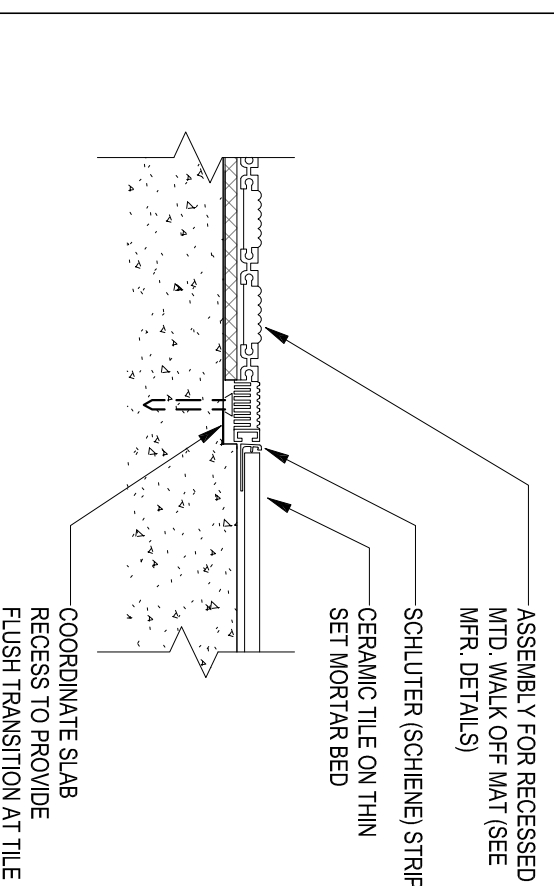

5A WALK-OFF MAT TO TILE  
SCALE 3/8"=1'-0"

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1	09/22/2015	30% REVIEW SET
2	11/22/2015	50% REVIEW SET
3	12/22/2015	100% REVIEW SET

PROJECT NAME:	
PROJECT NUMBER:	15180
DRAWING NAME:	
SHEET NAME:	INTERIOR DETAILS
DRAWN BY:	BBC
CHECKED BY:	BBC
DATE:	12-22-15
SCALE:	AS NOTED
DRAWING NUMBER:	A608

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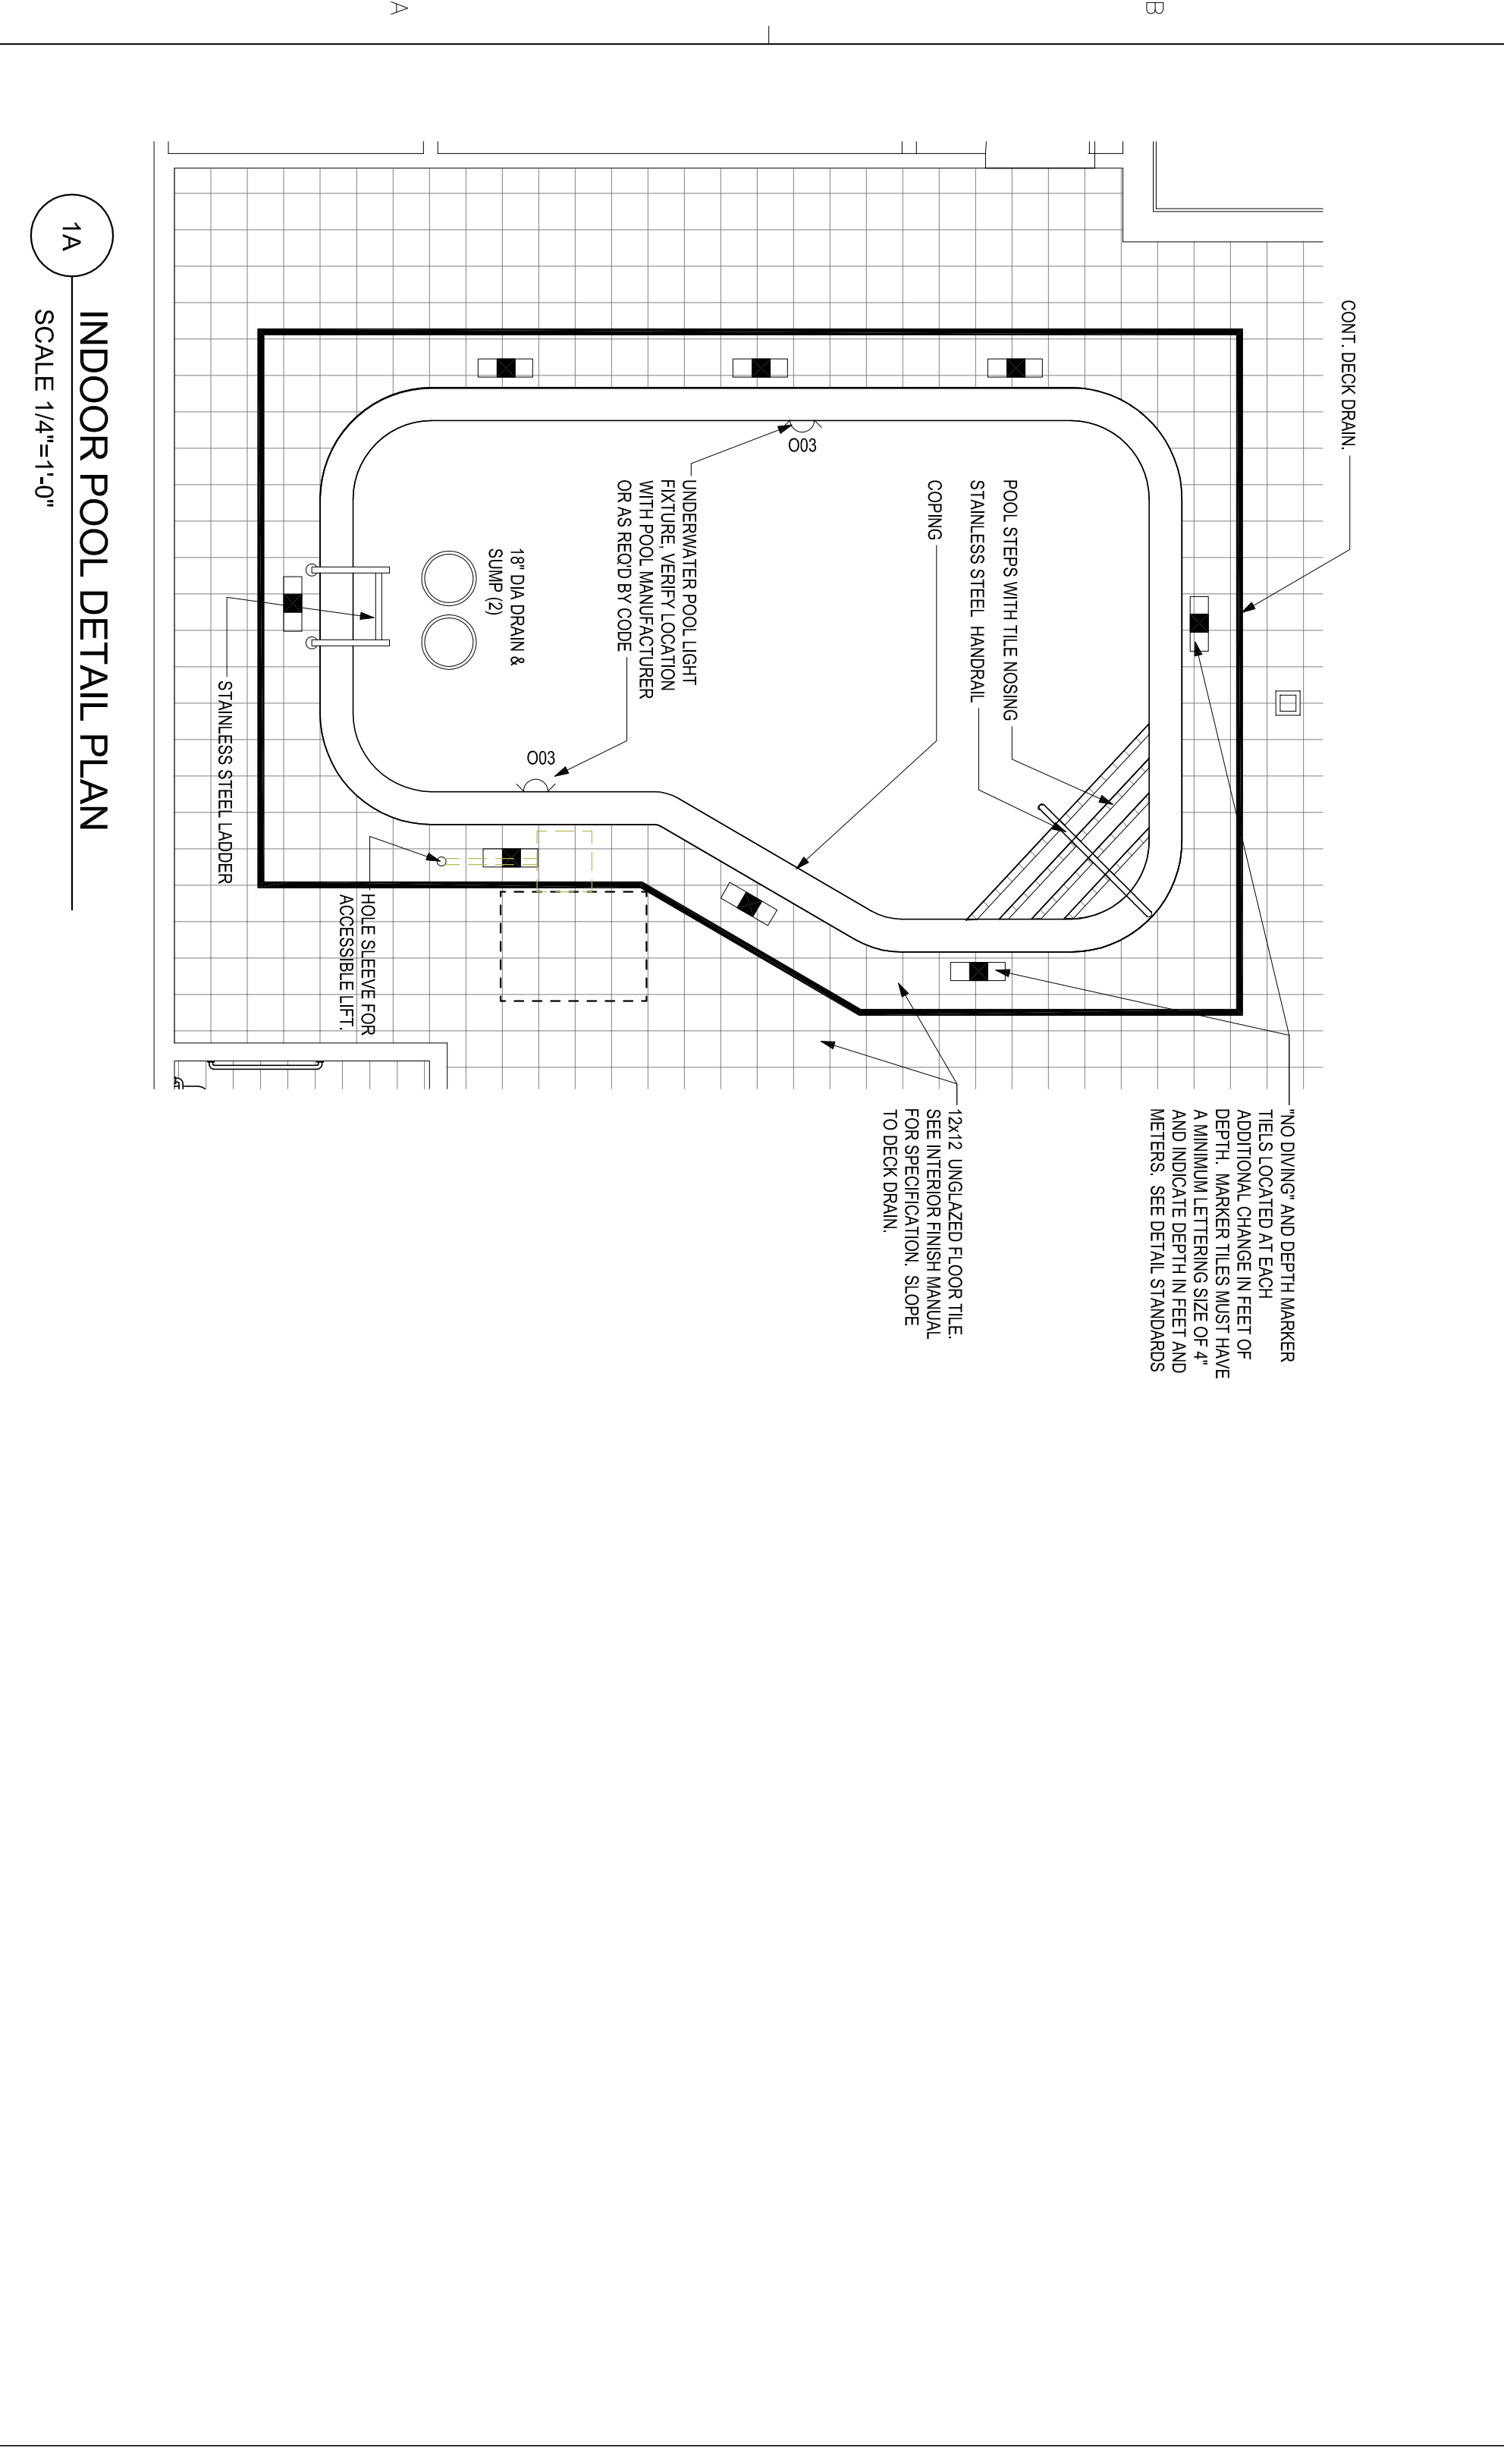
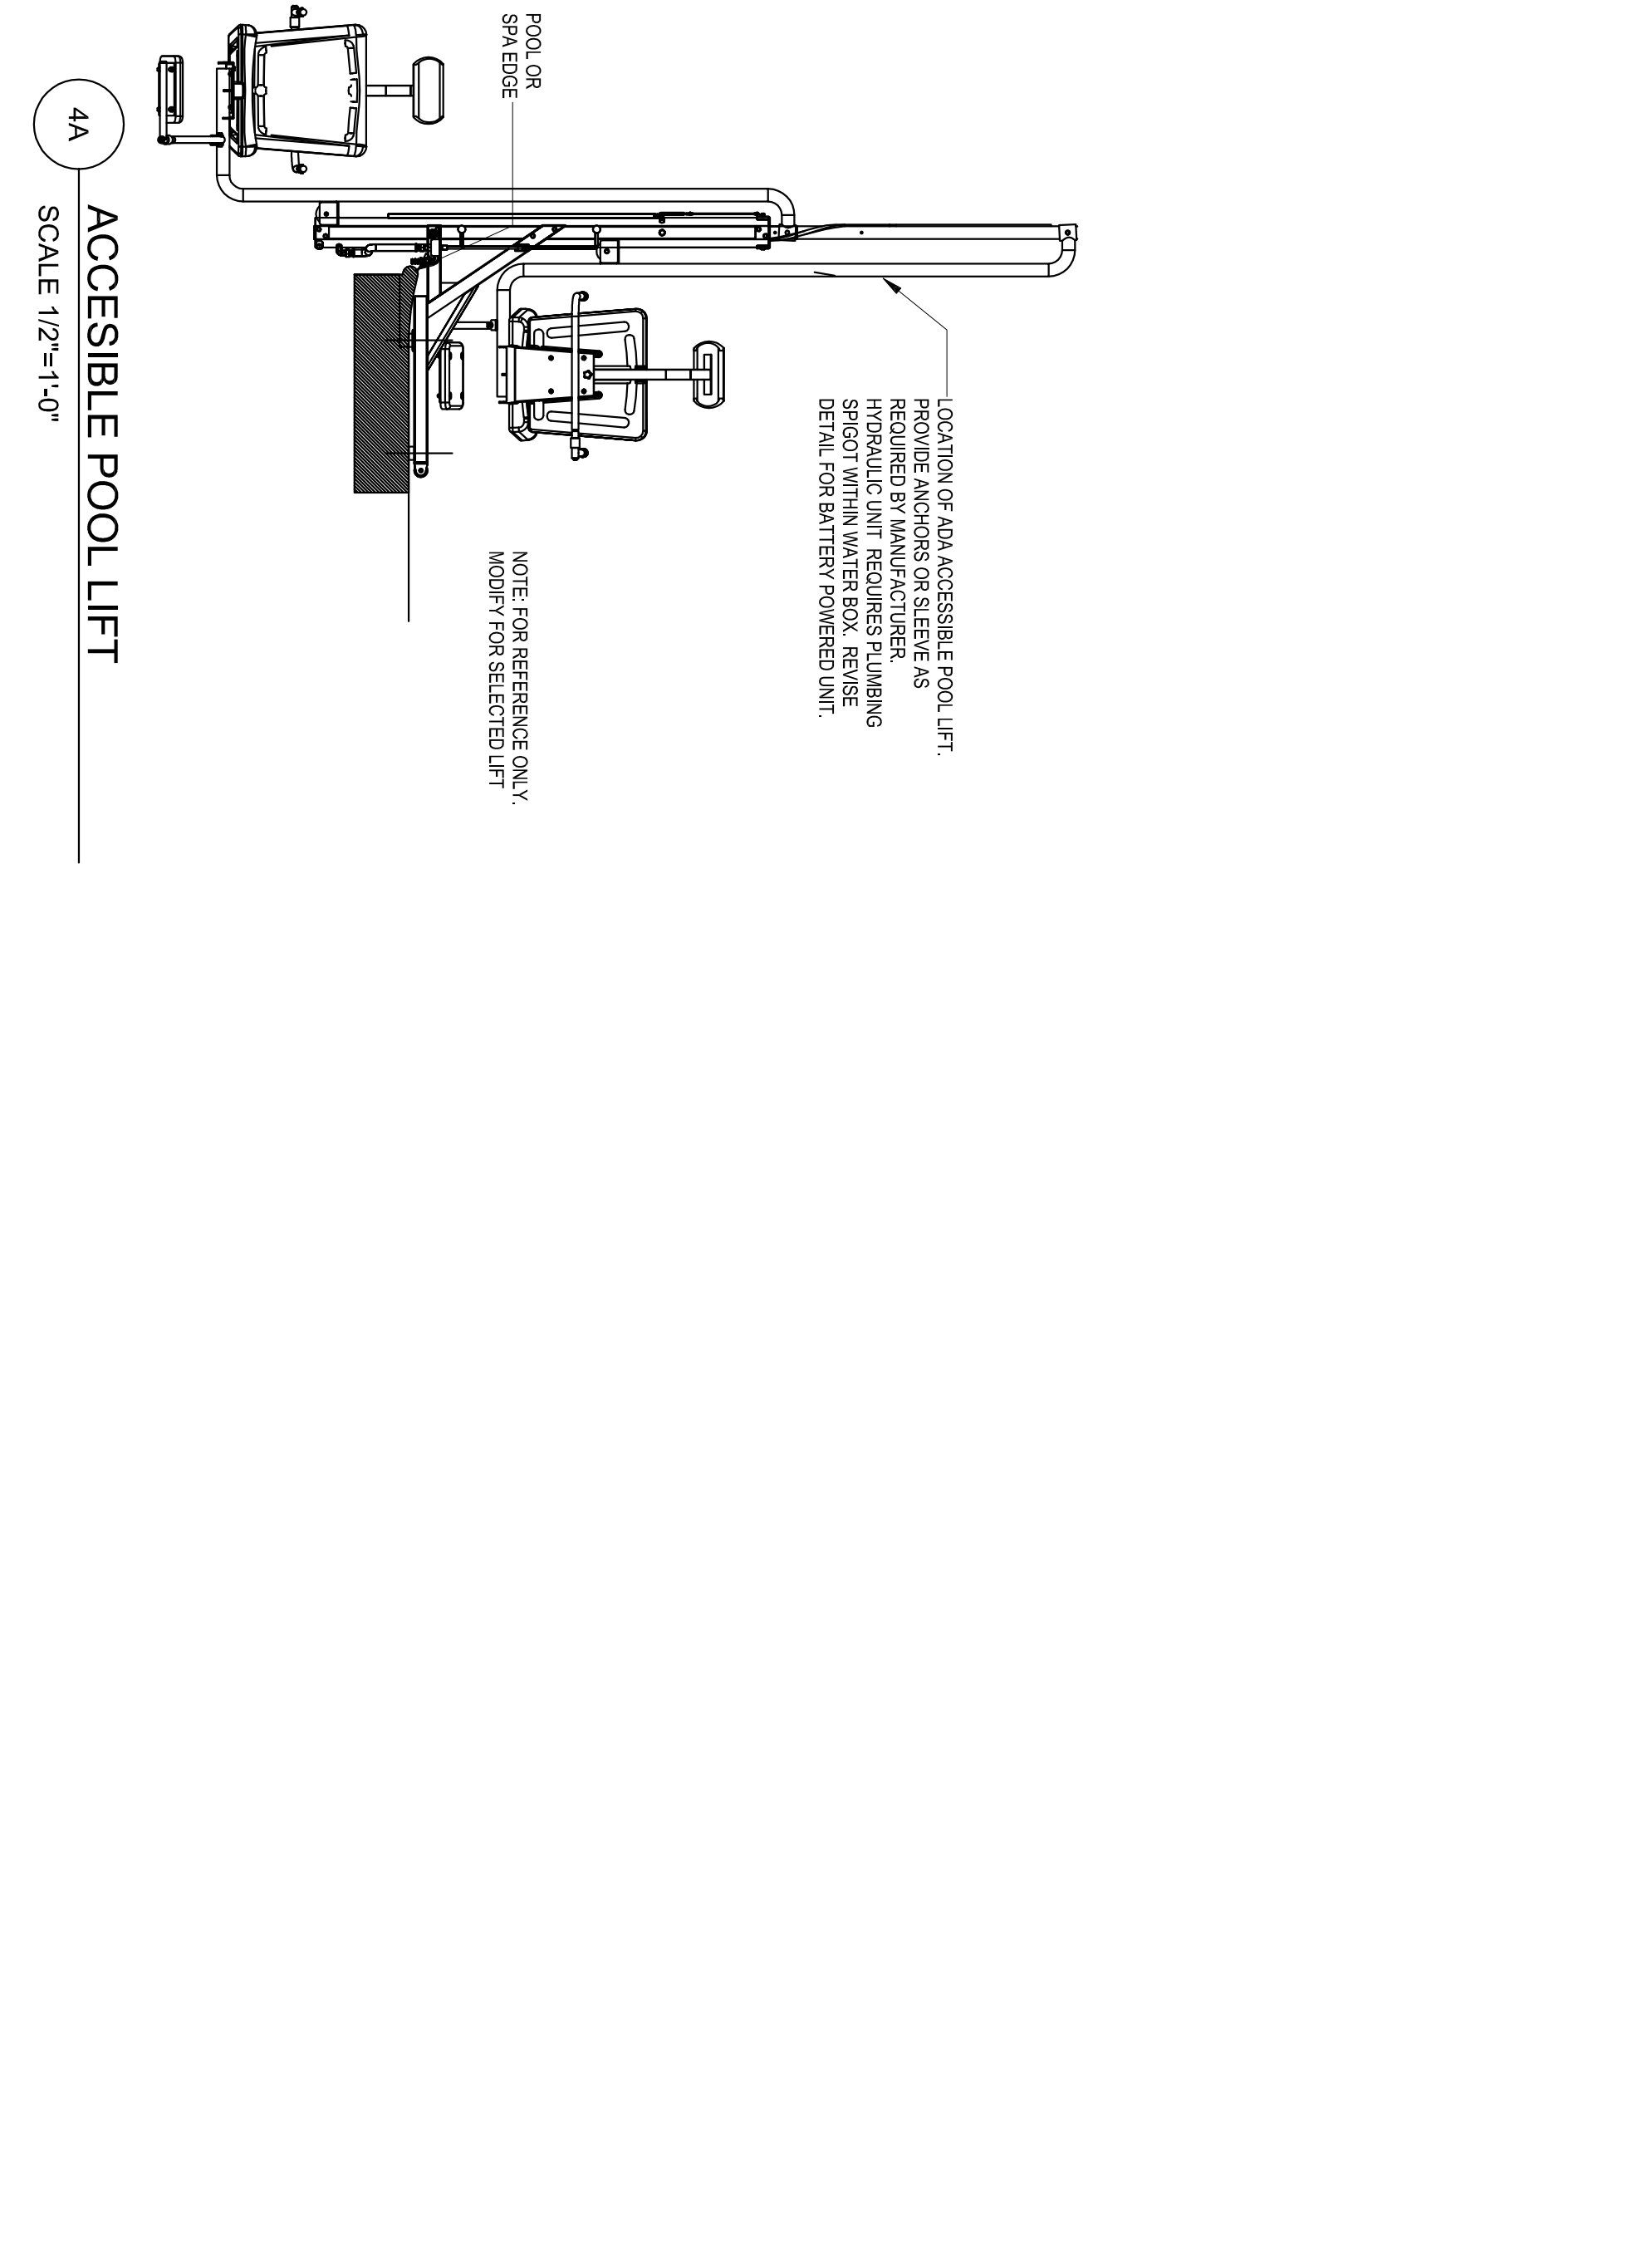
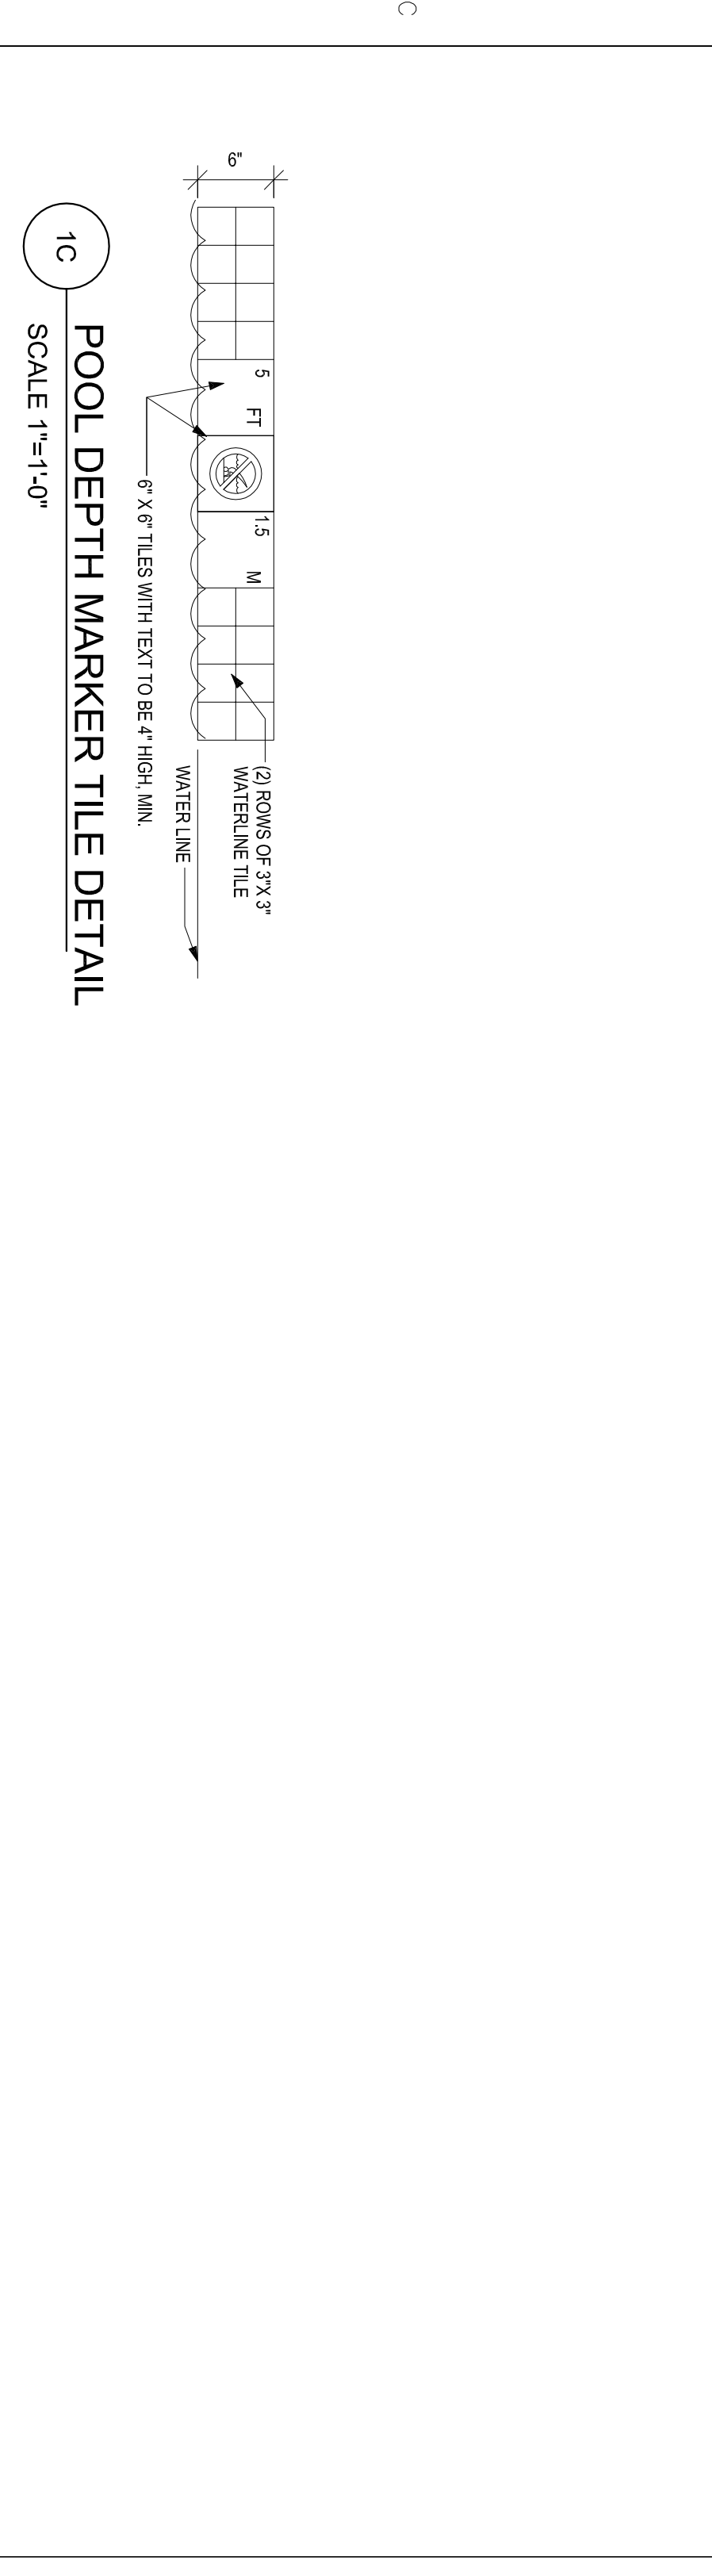
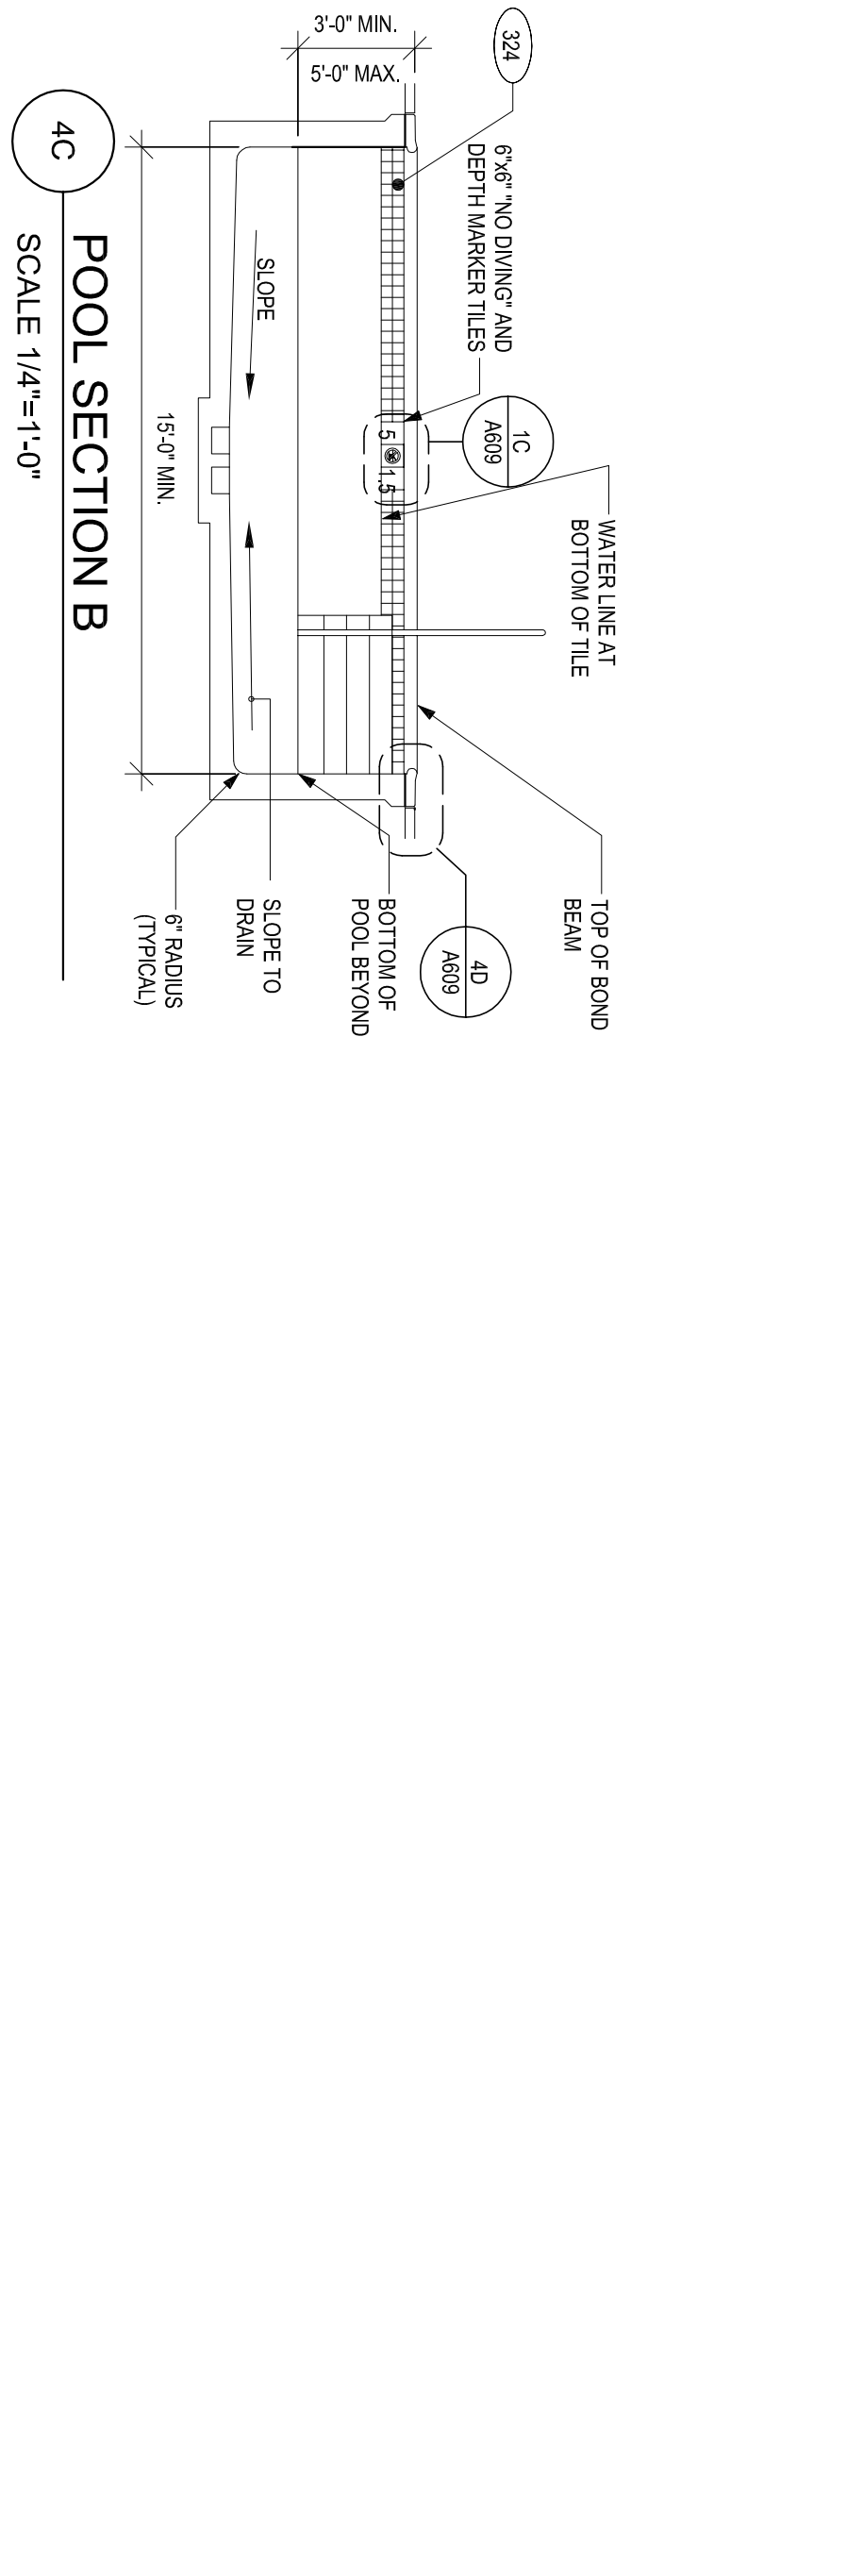
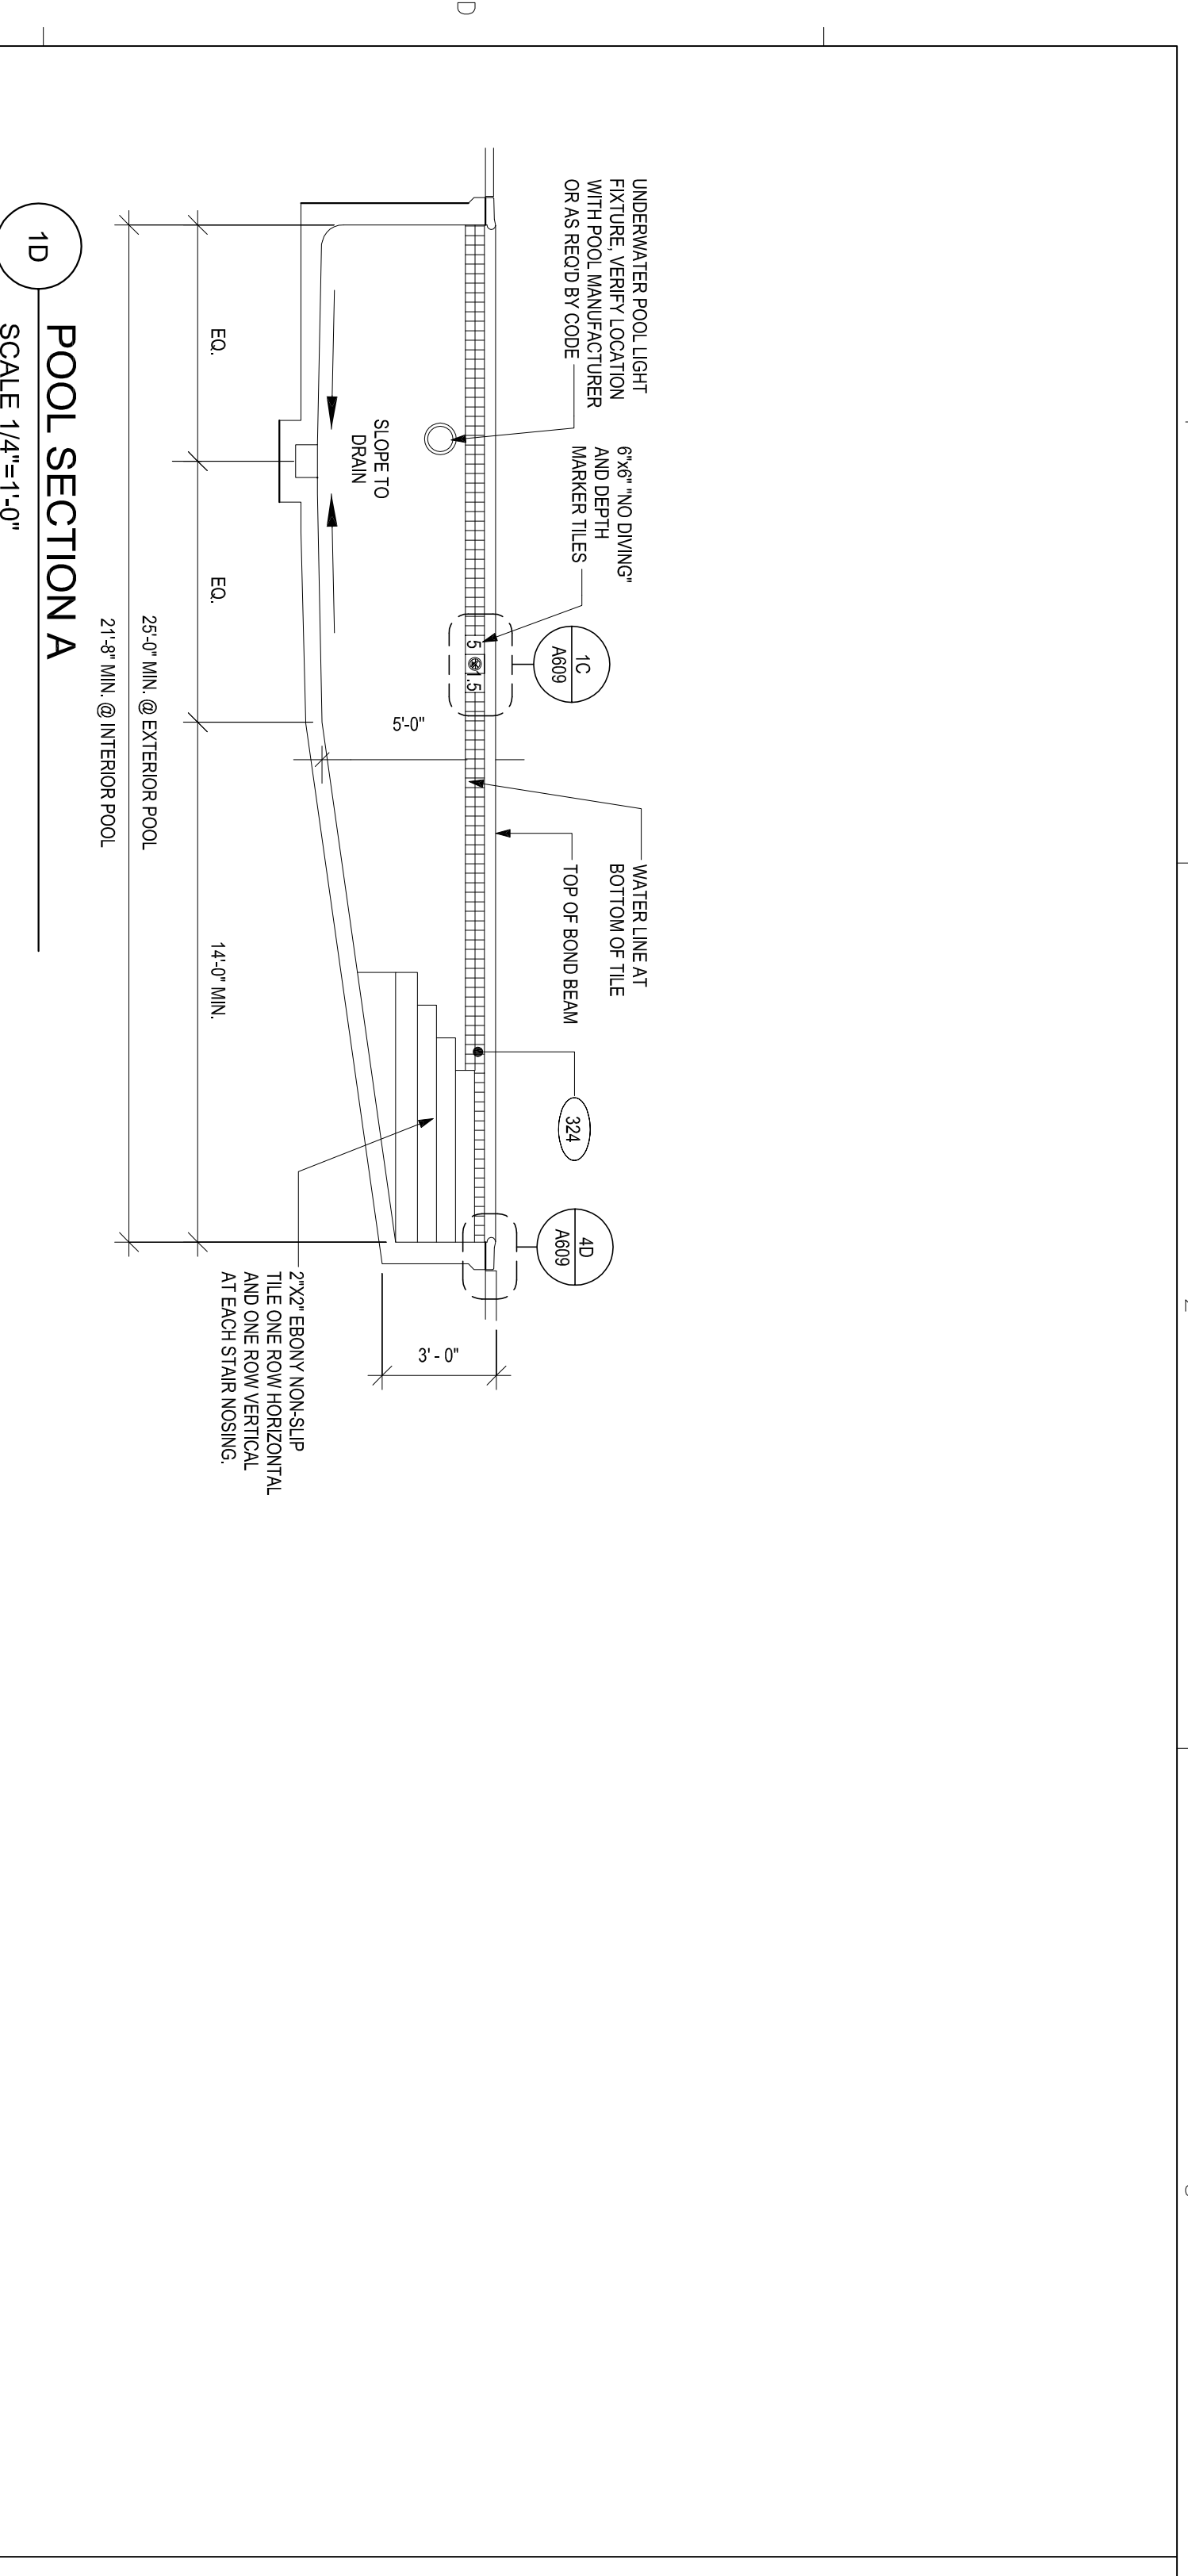
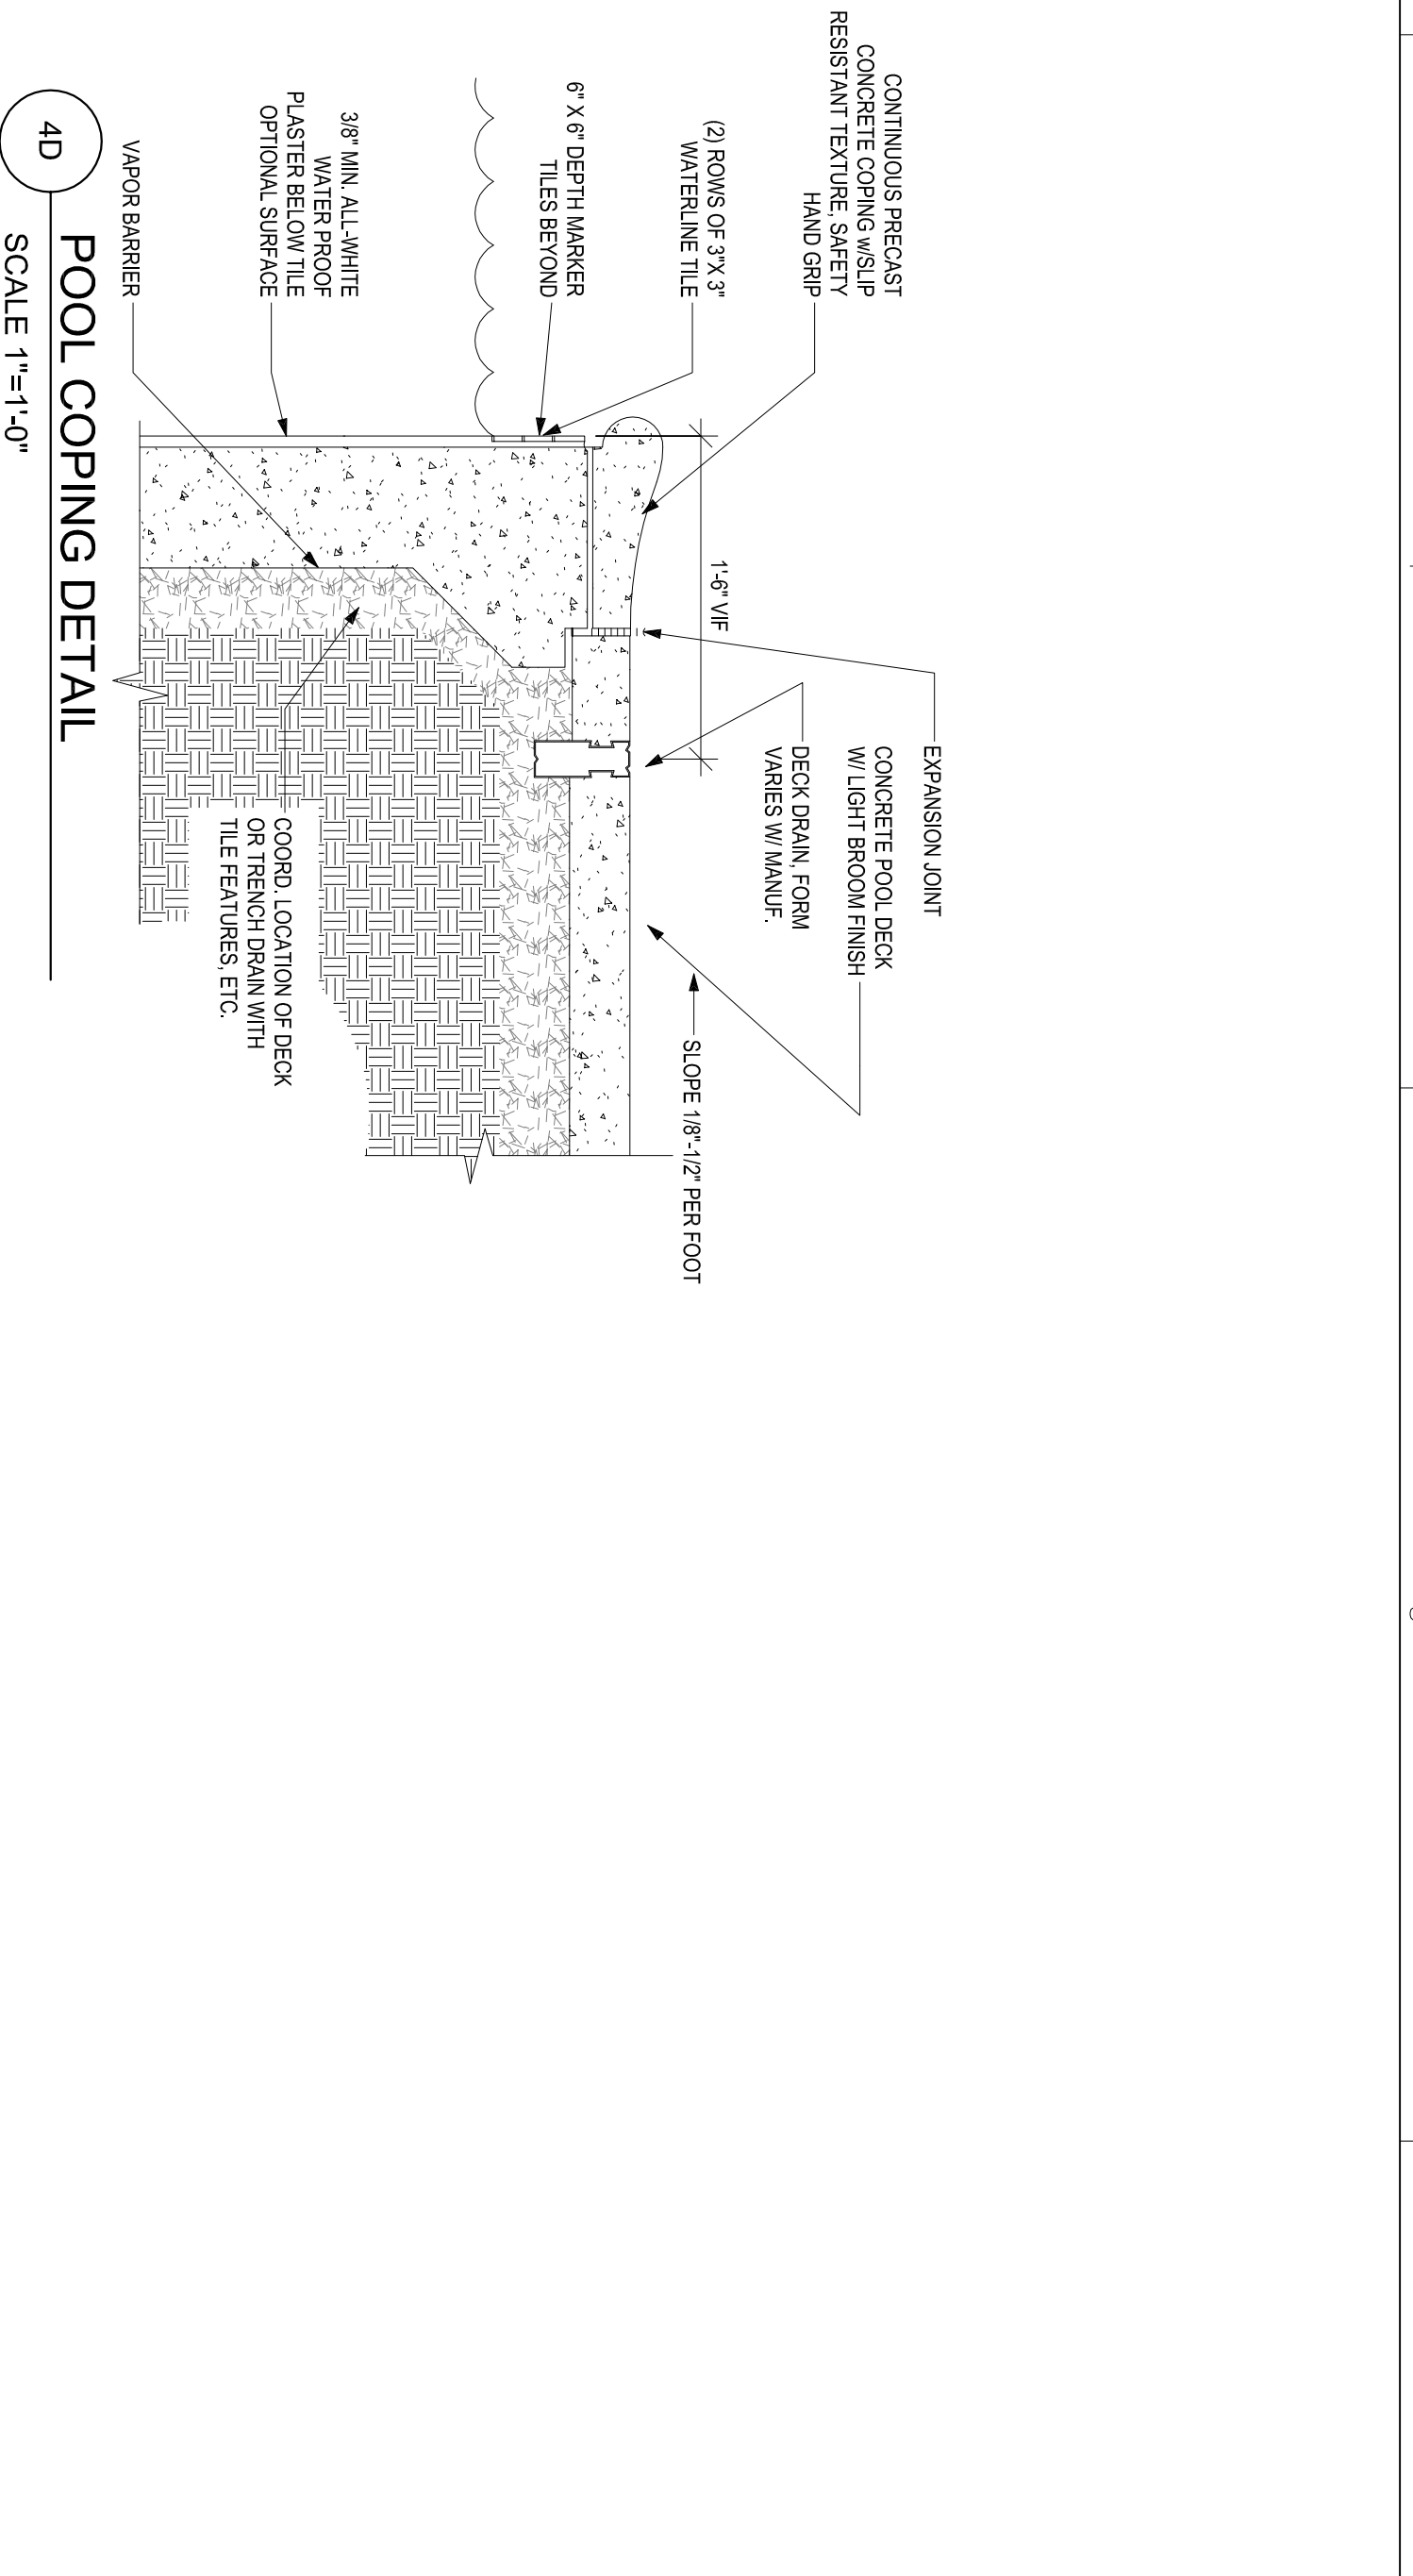
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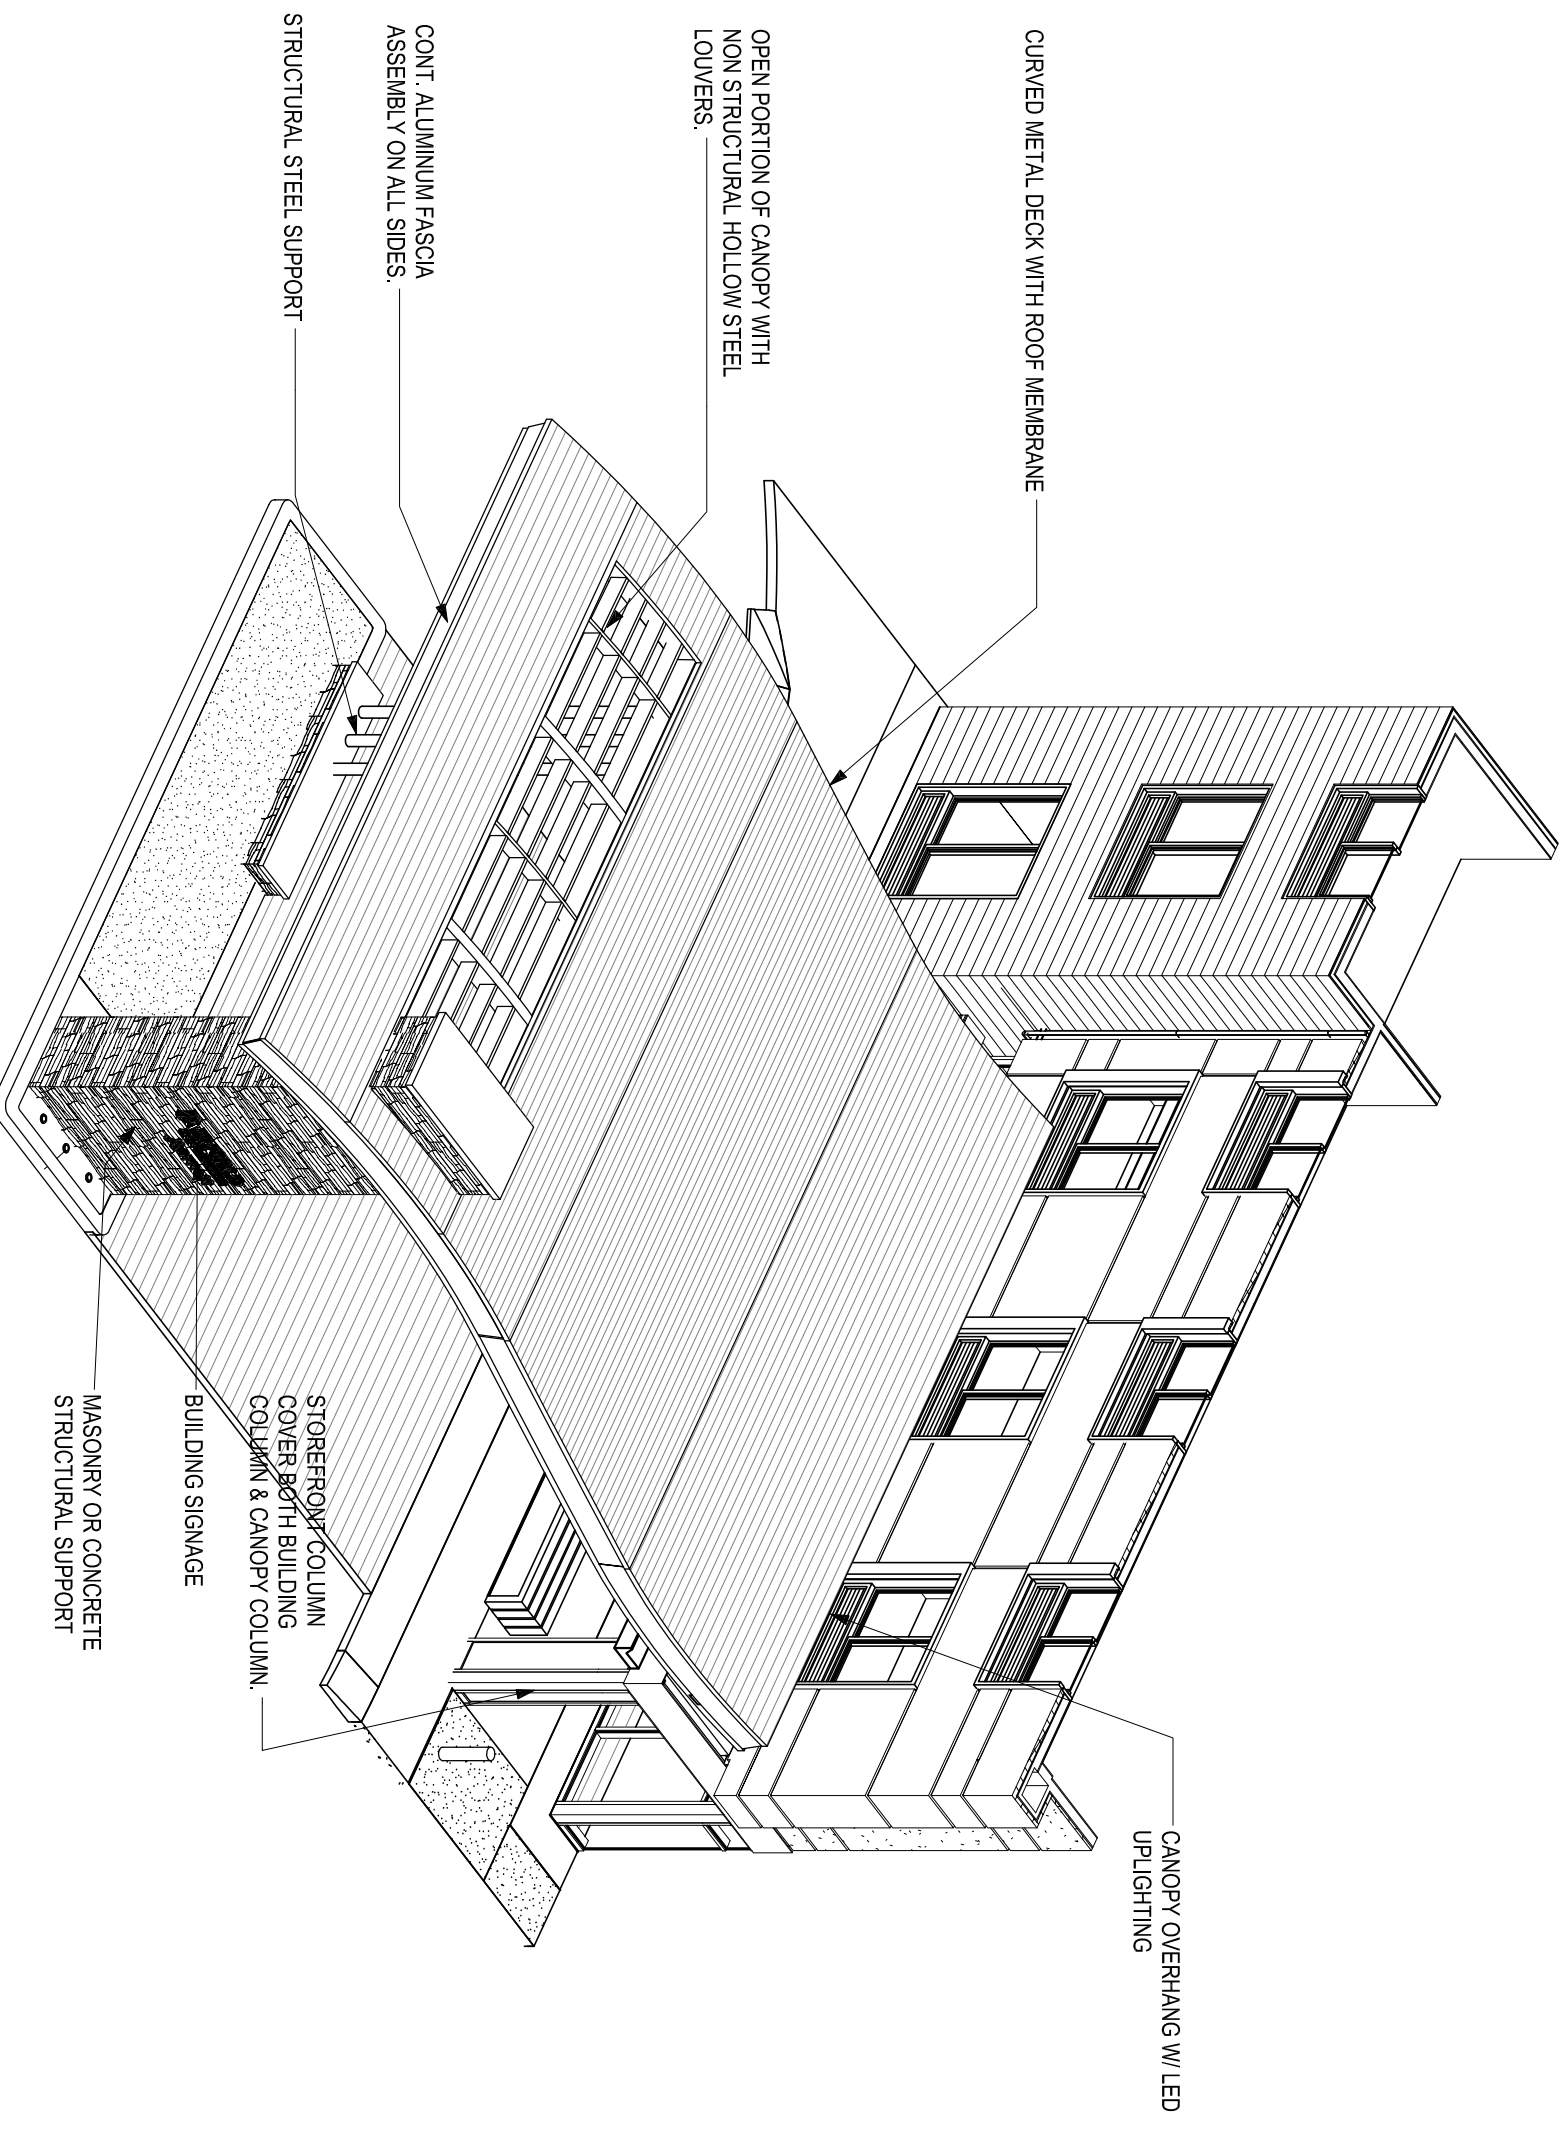
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NO.	DATE	DESCRIPTION
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2	11/22/2015	50% REVIEW SET
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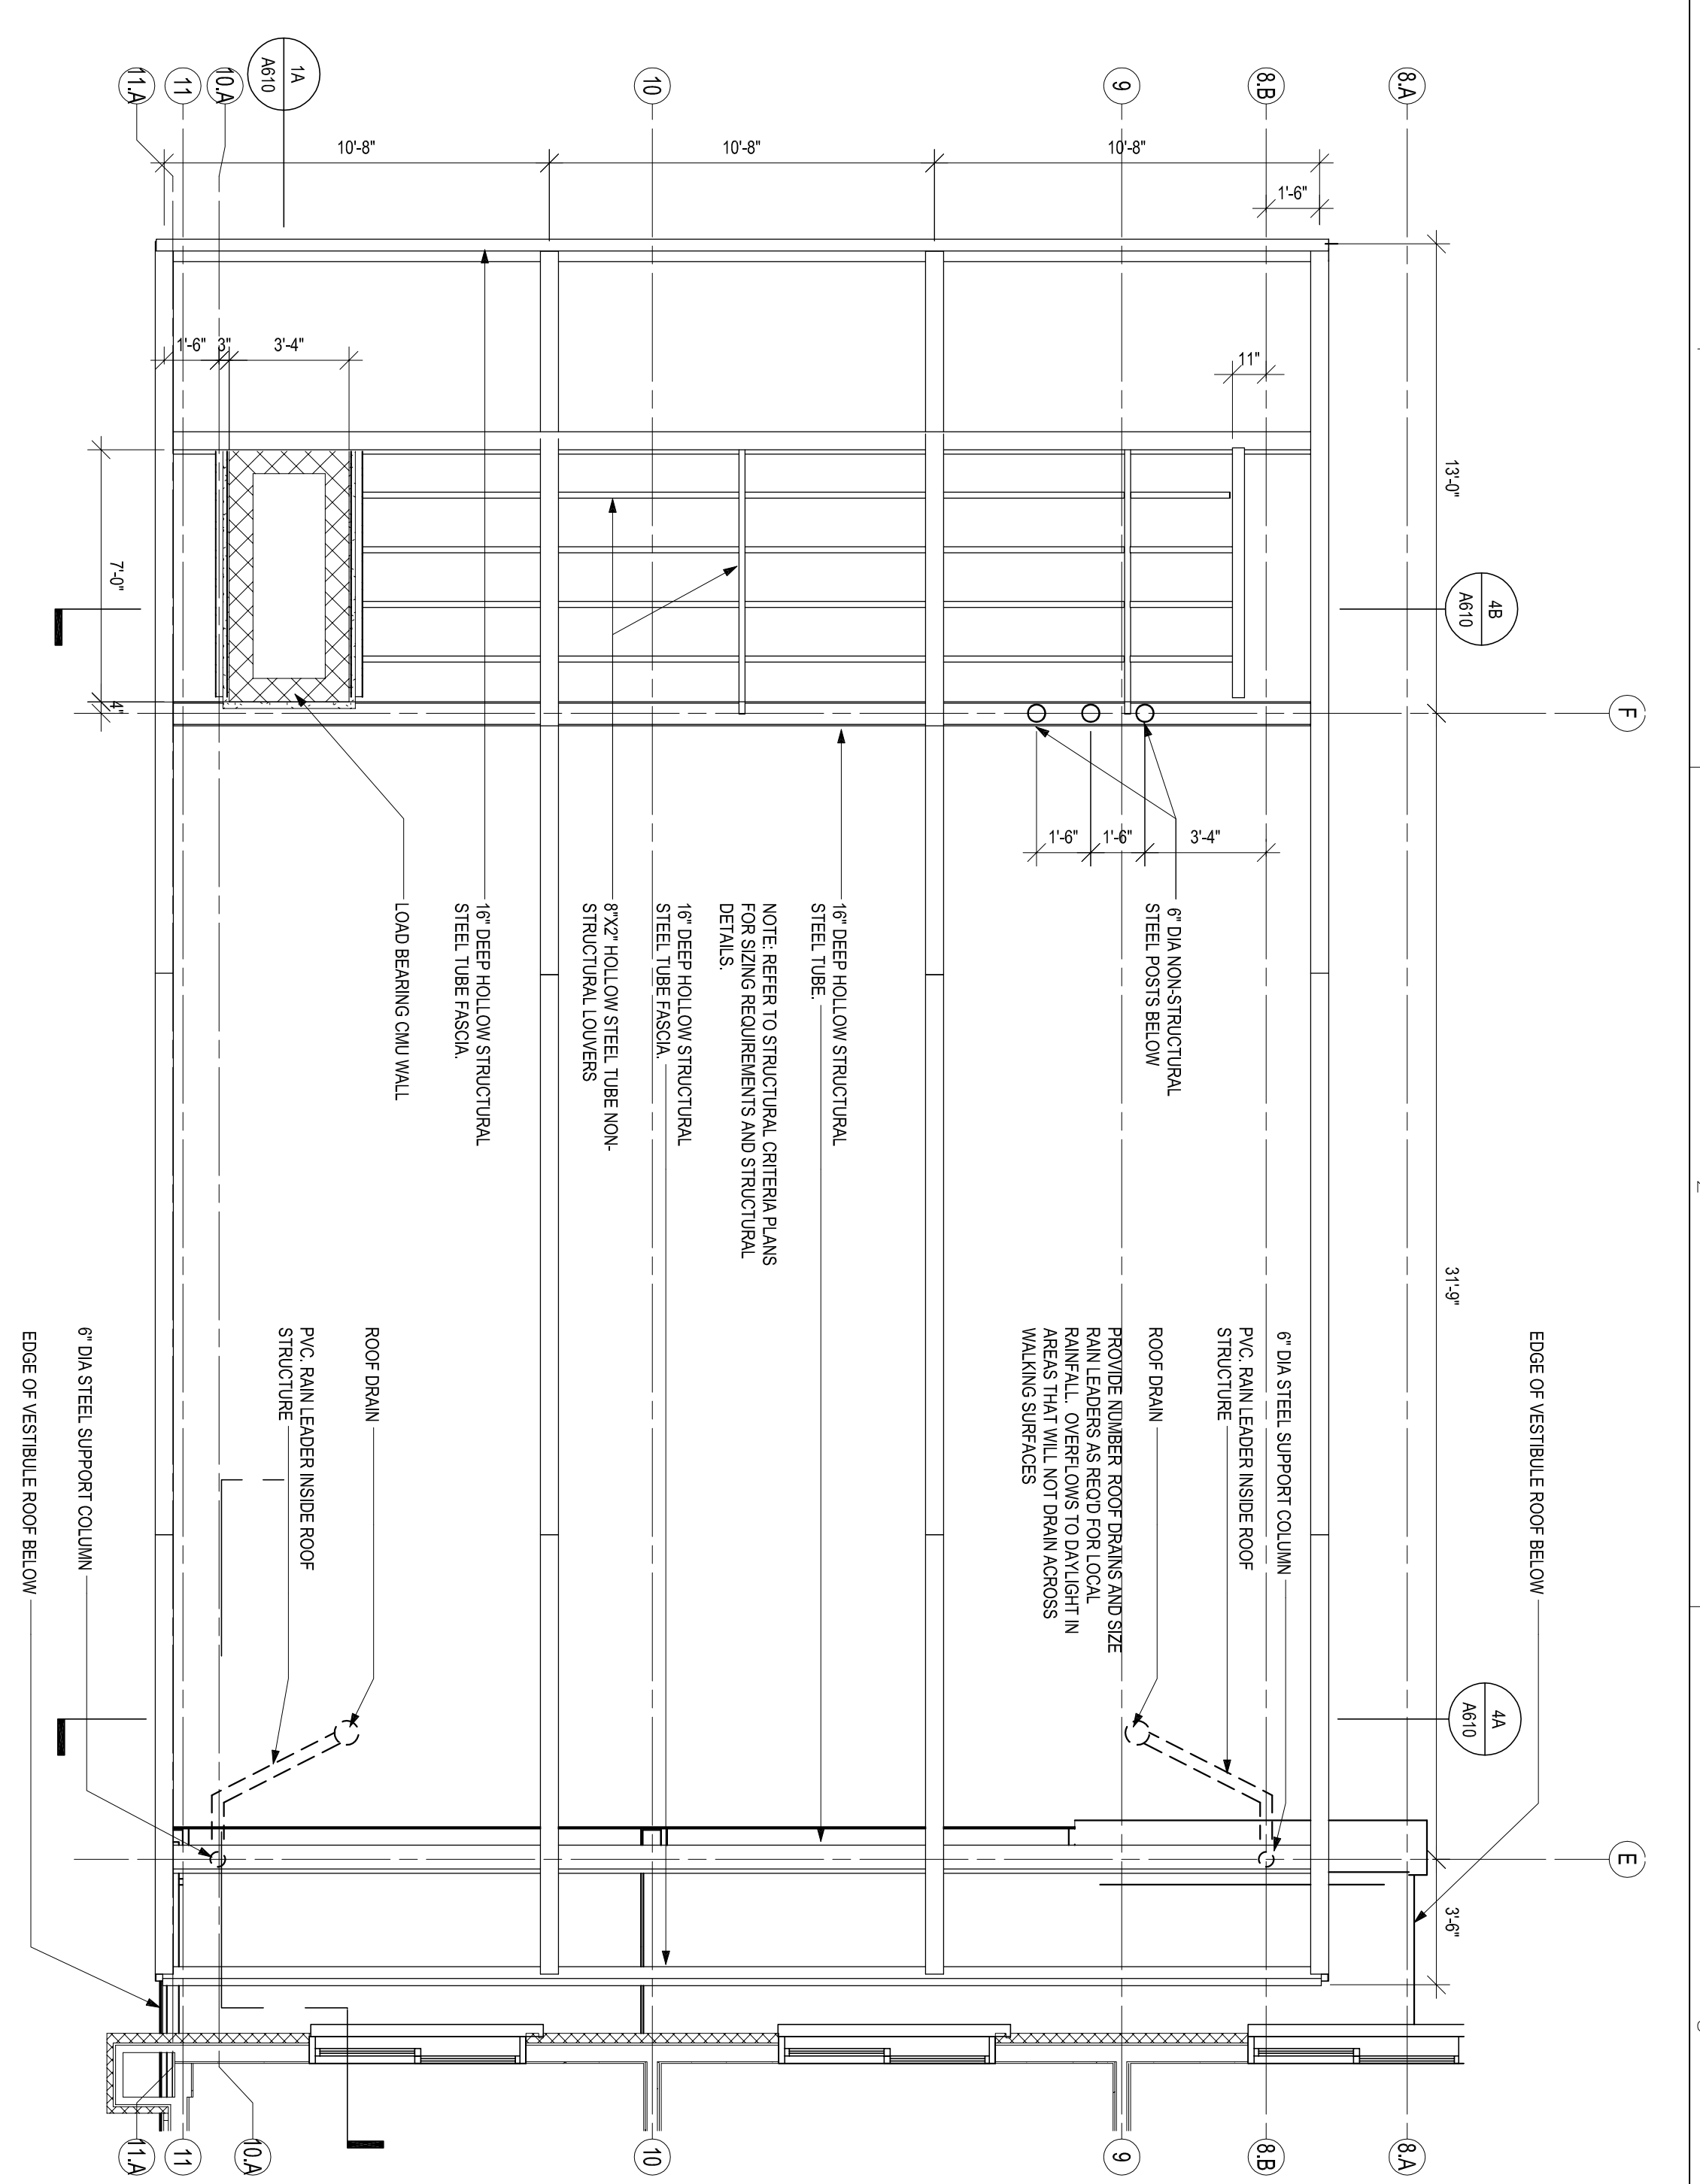
PROJECT NAME:  
 DRAWING NUMBER:  
 SHEET NAME:  
**POOL PLANS AND DETAILS**

DRAWN BY: BKC  
 CHECKED BY: BKC  
 DATE: 12-22-15  
 SCALE: AS NOTED  
 DRAWING NUMBER  
**A609**






4D PORTE COCHERE



1C PORTE COCHERE PLAN

LAYOUT NOTES:  
HORIZONTAL DIMENSIONS FOR ARCH SEGMENTS ARE TAKEN TO BOTTOM OF BEAM.  
ORIENT PRC SEGMENTS ON TANGENT WITH 15'-9\"/>

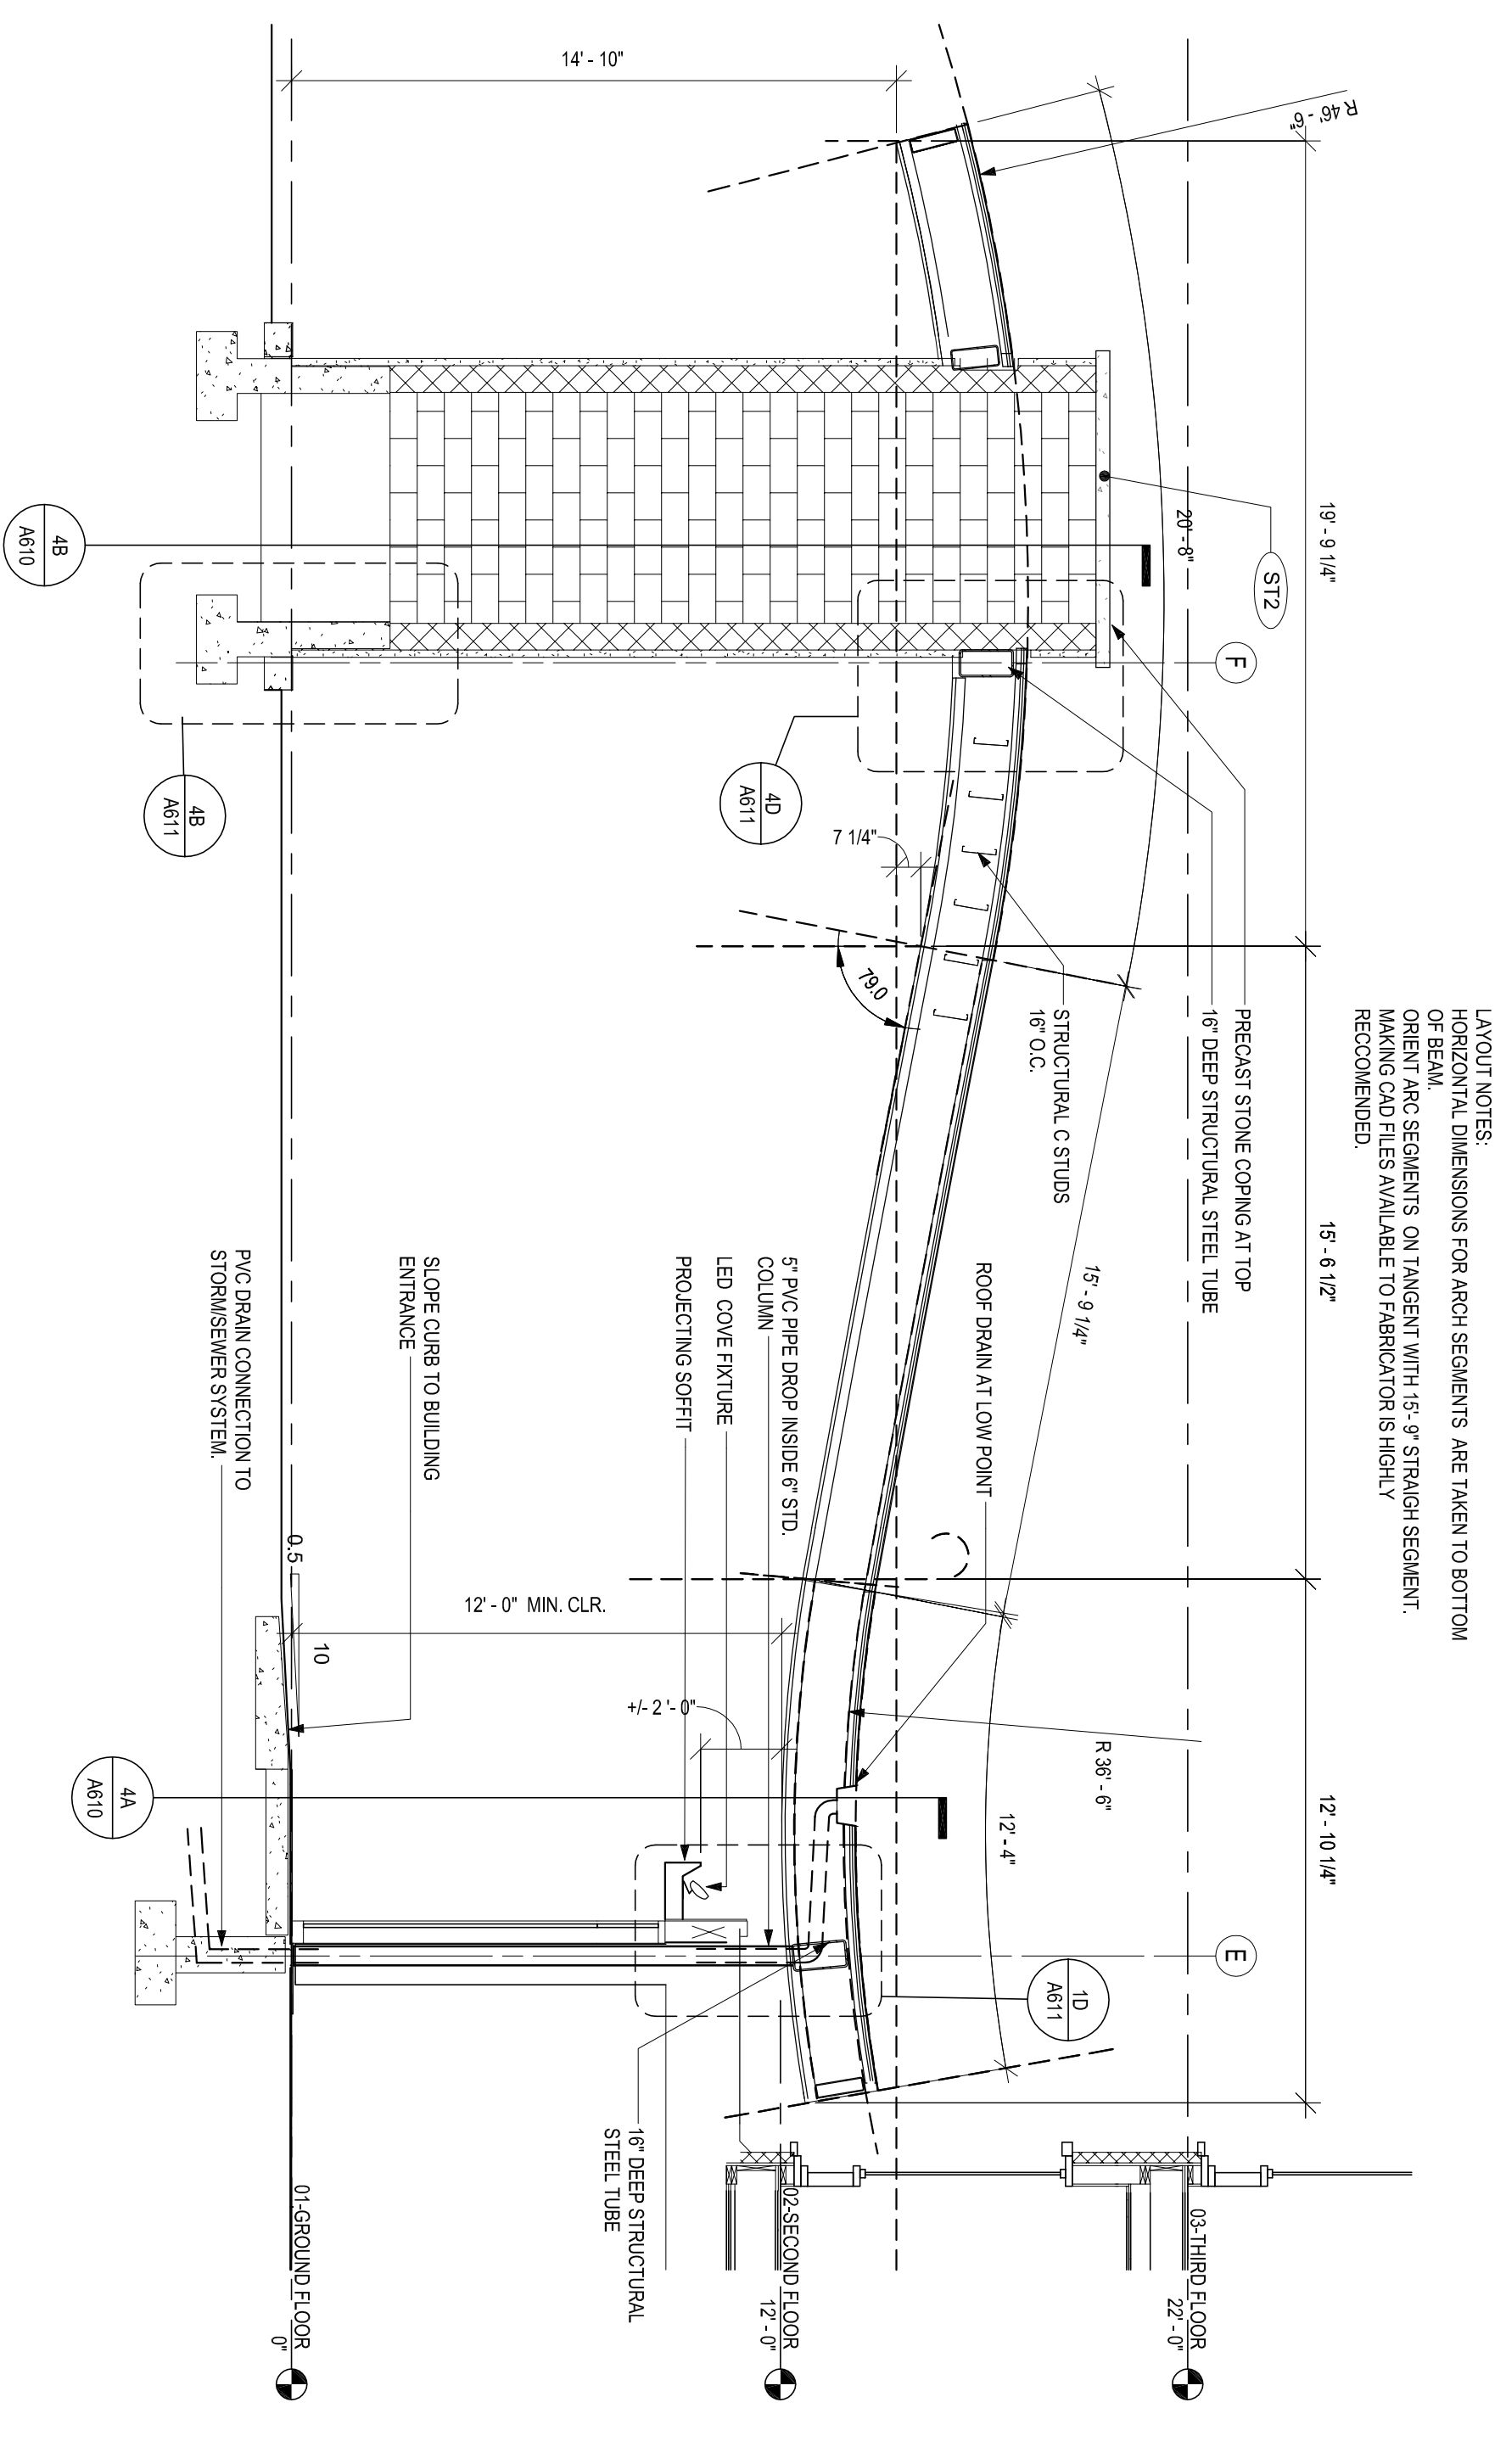


1A PORTE COCHERE-SECTION

LAYOUT NOTES:  
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ORIENT PRC SEGMENTS ON TANGENT WITH 15'-9\"/>


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4B PORTE COCHERE-CROSS SECTION



4A PORTE COCHERE-CROSS SECTION
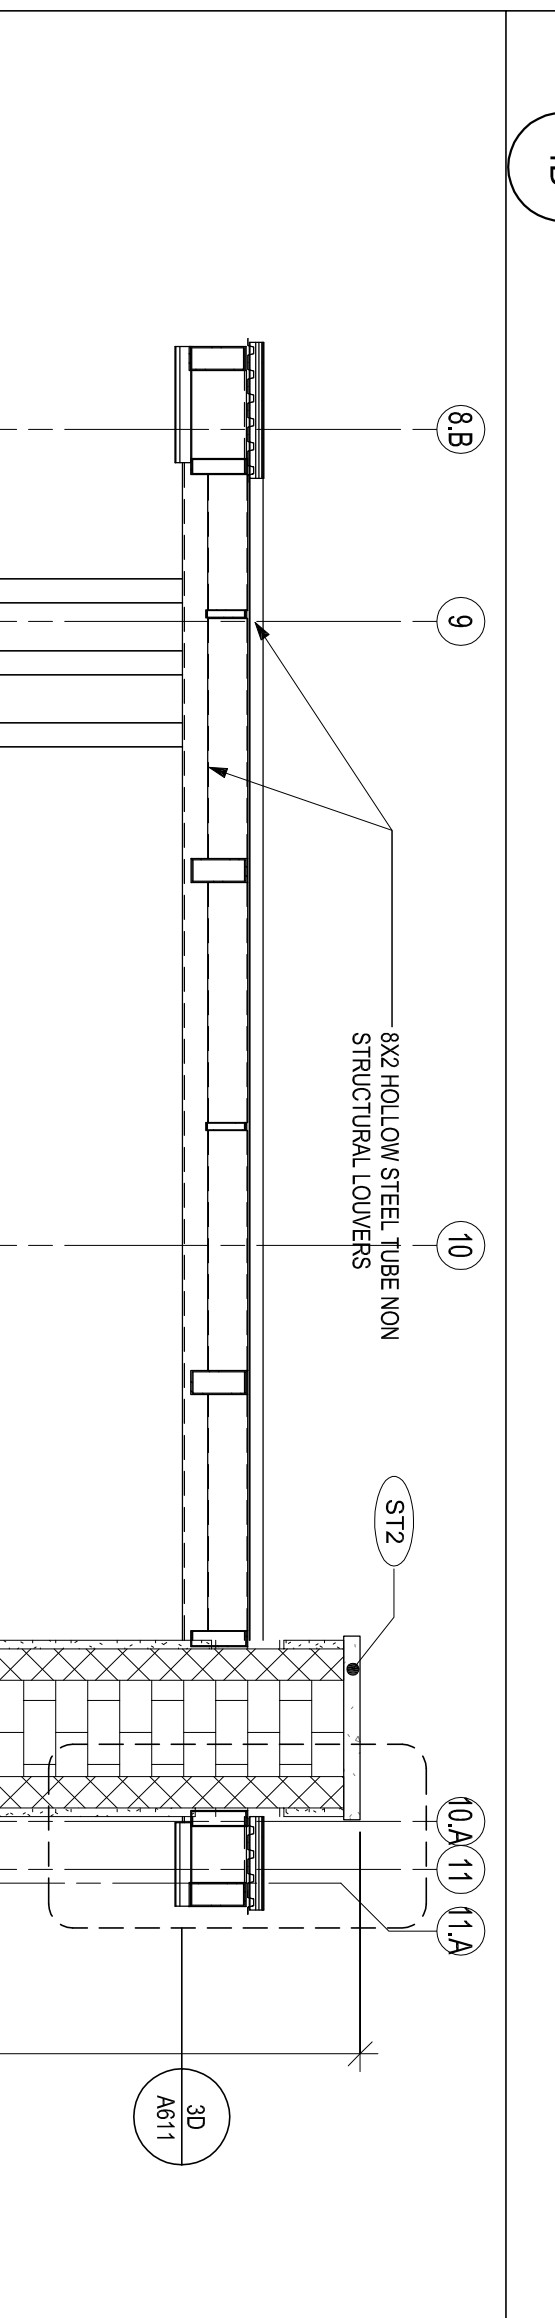
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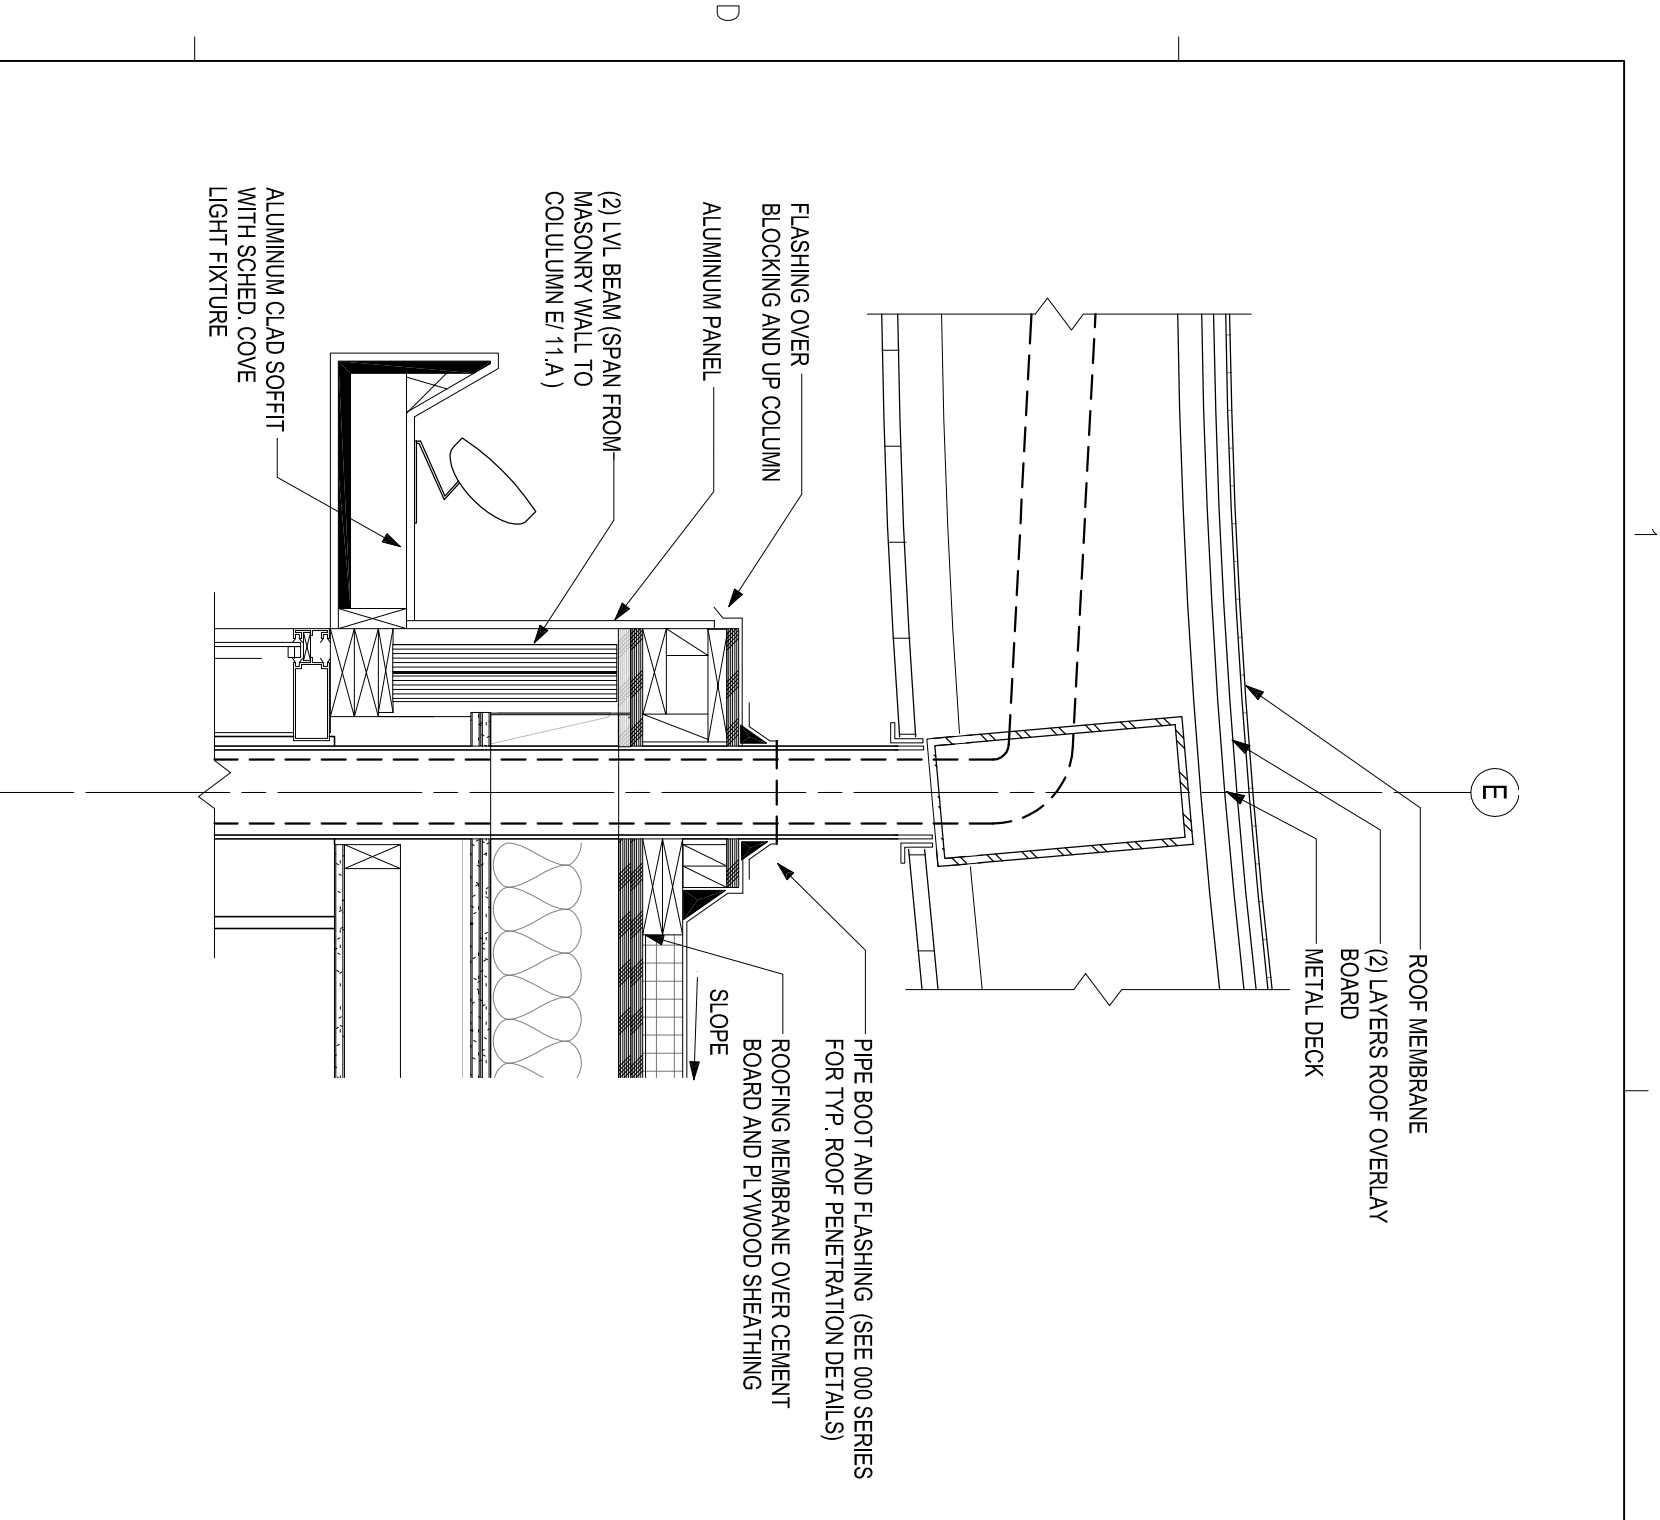
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CONSTRUCTION

ISSUES & REVISIONS	NO.	DATE	DESCRIPTION
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	2	11/22/2015	50% REVIEW SET
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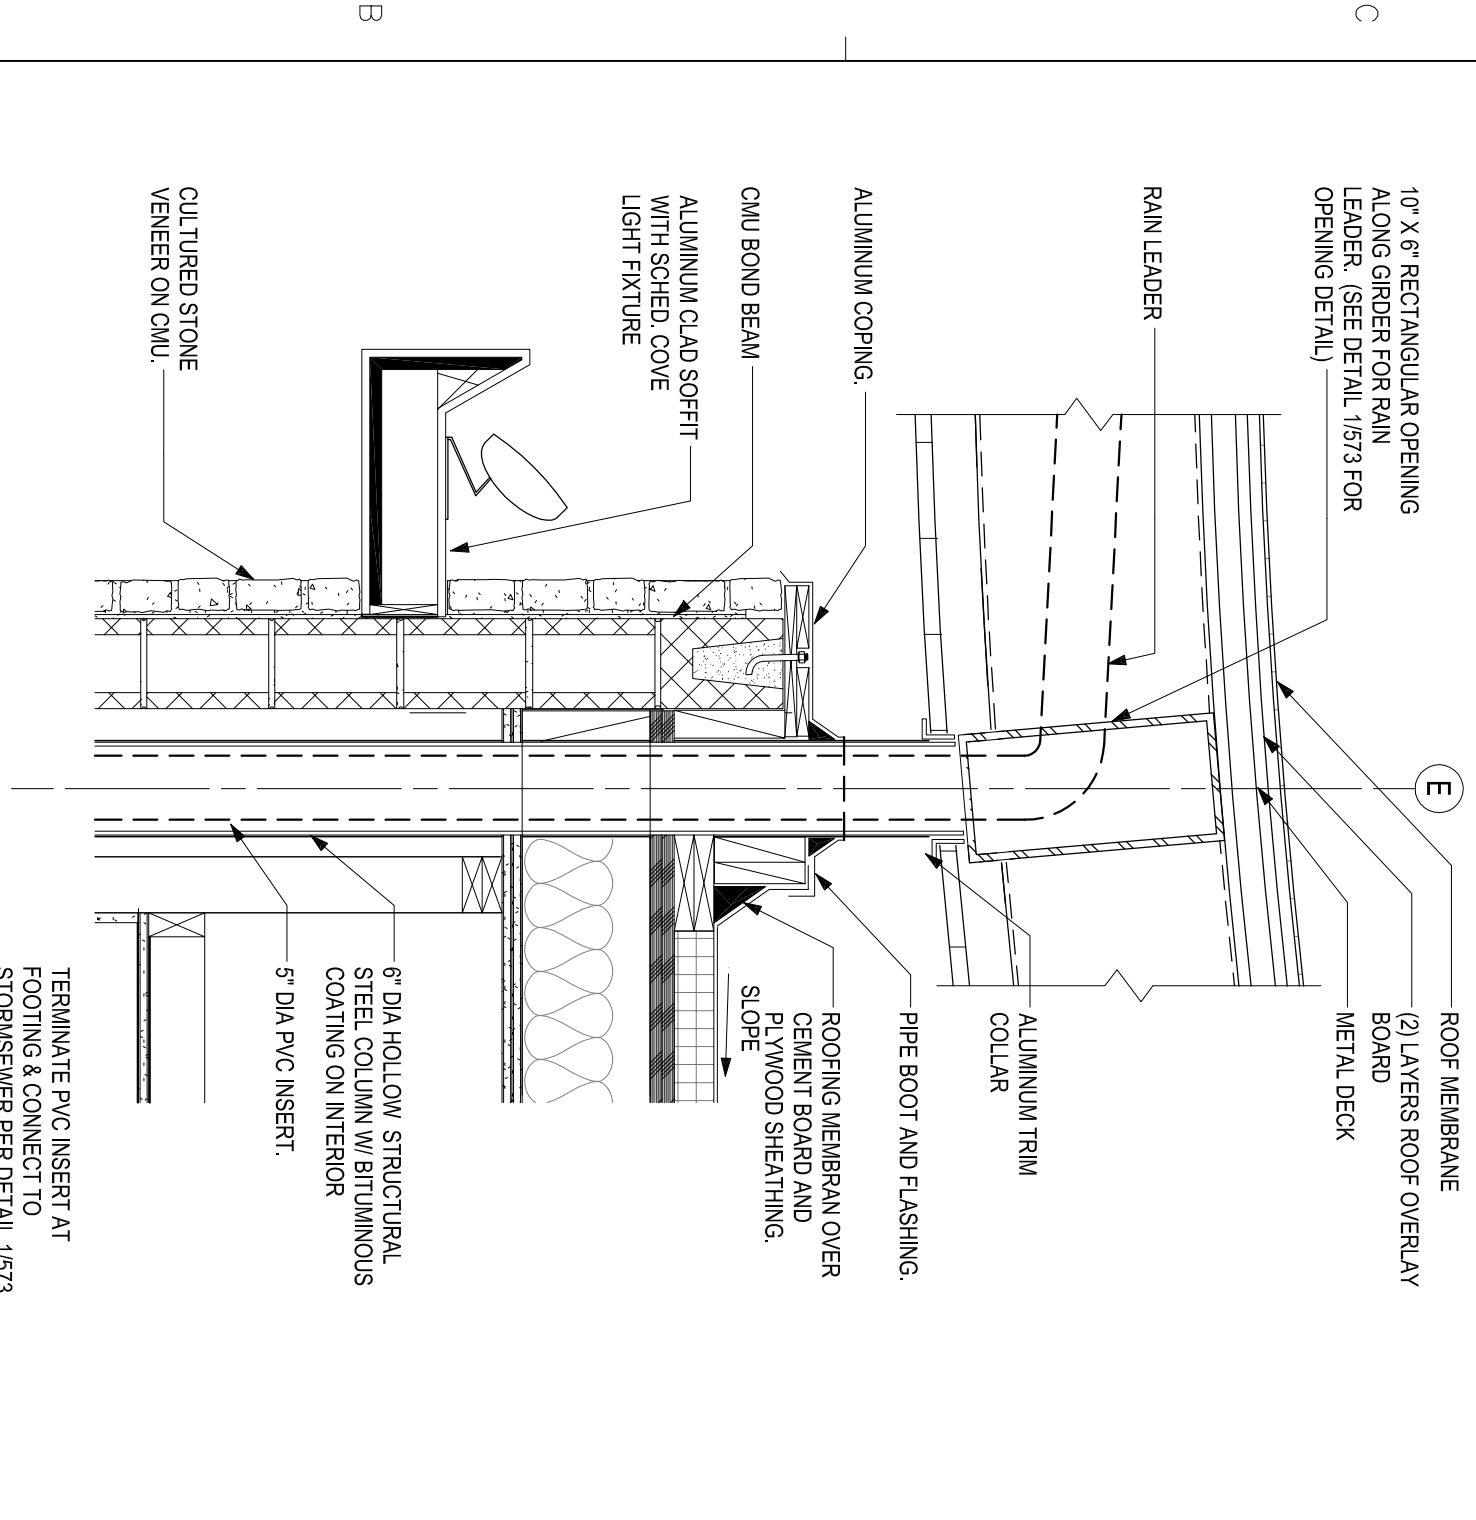
PROJECT NAME:  
PORTE - COCHERE DETAILS

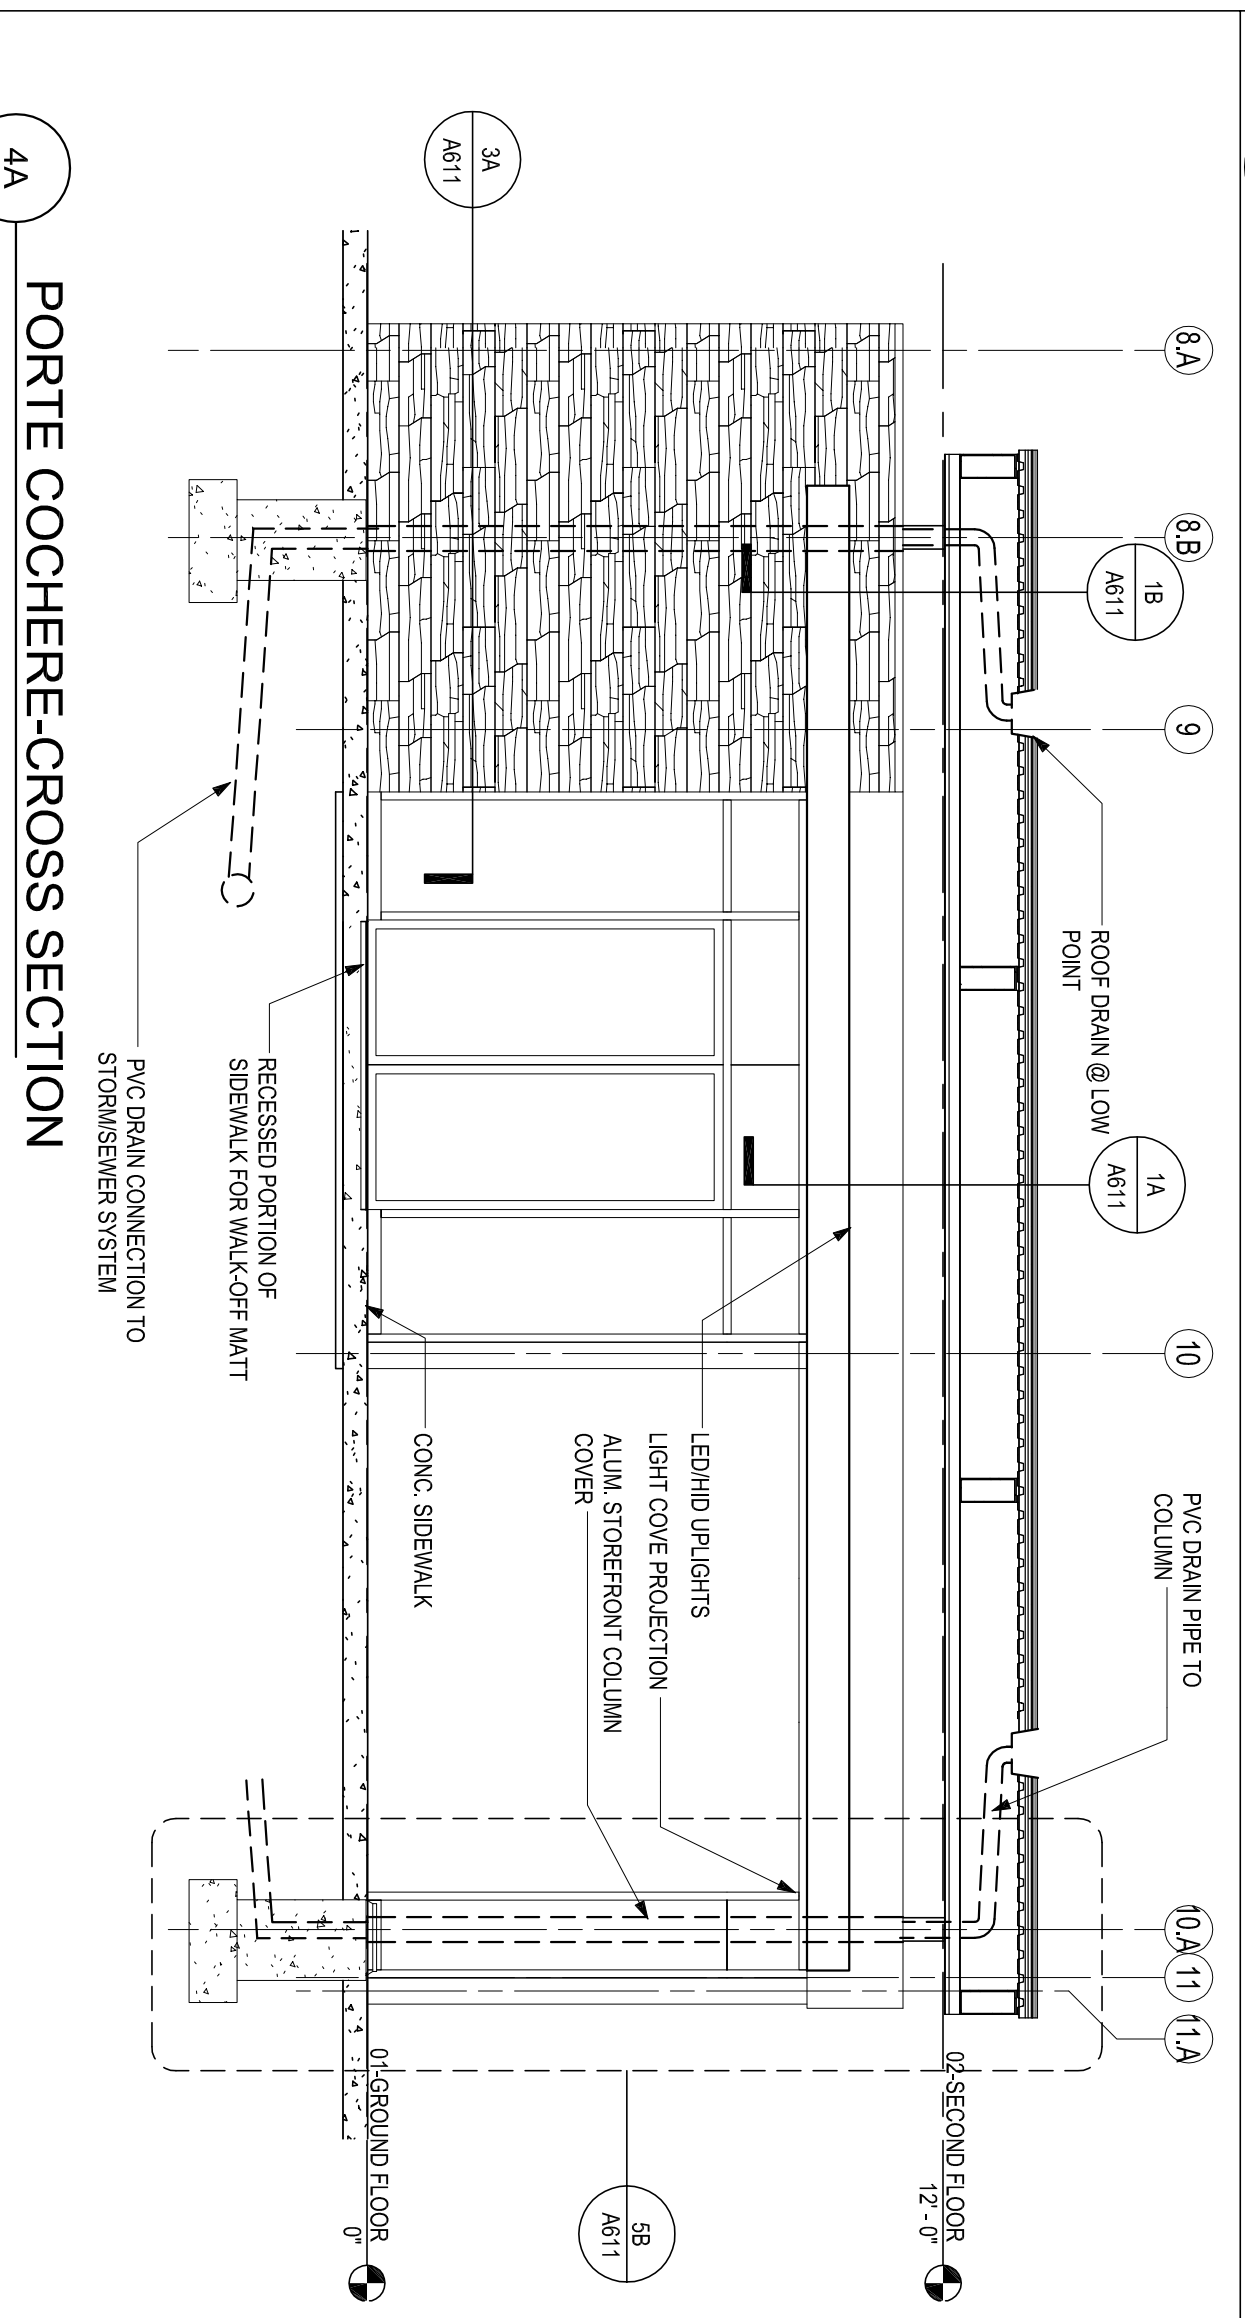DRAWN BY: BBC  
CHECKED BY: BBC  
DATE: 12-22-15  
SCALE: AS NOTED


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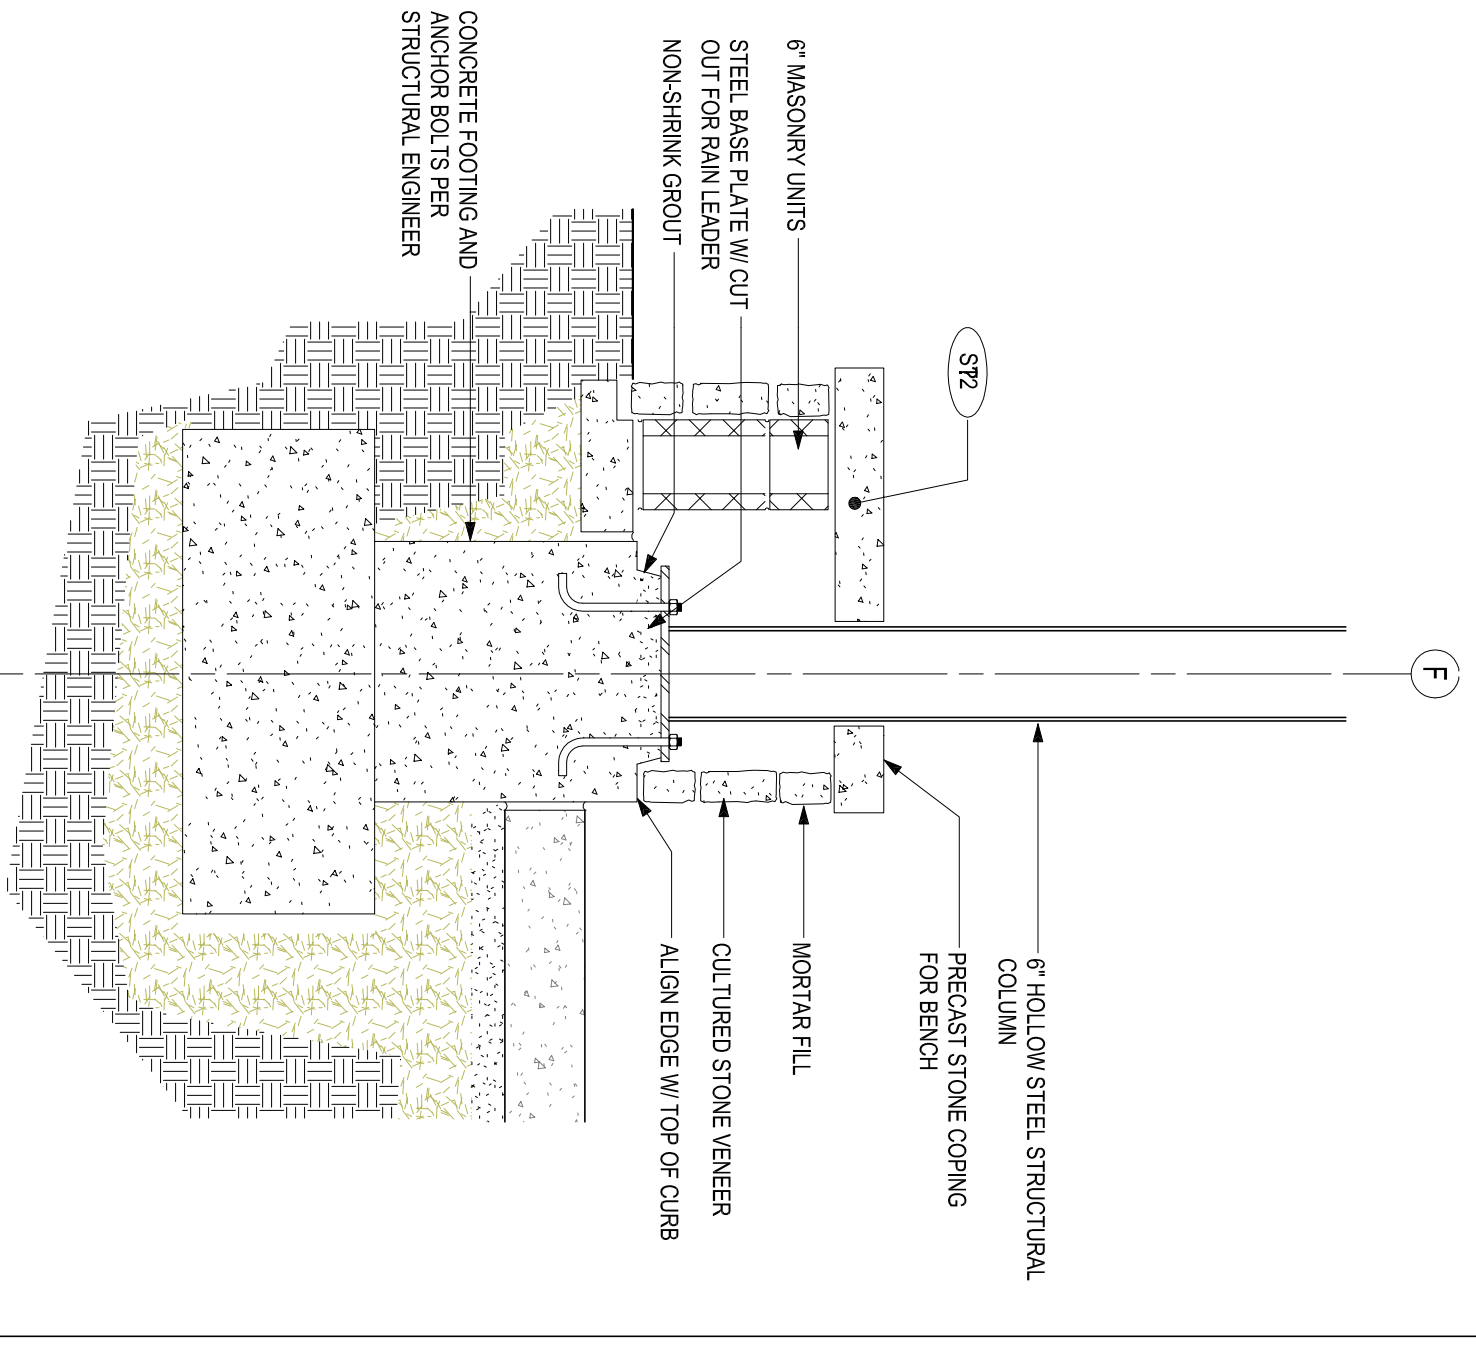
**1D**  
BEAM CONNECTION & LIGHT COVE  
SCALE 1"=1'-0"




**1B**  
BEAM CONNECTION @ STONE ENTRY WALL  
SCALE 1"=1'-0"




**3D**  
CONNECTION @ BEARING WALL & FASCIA  
SCALE 1"=1'-0"

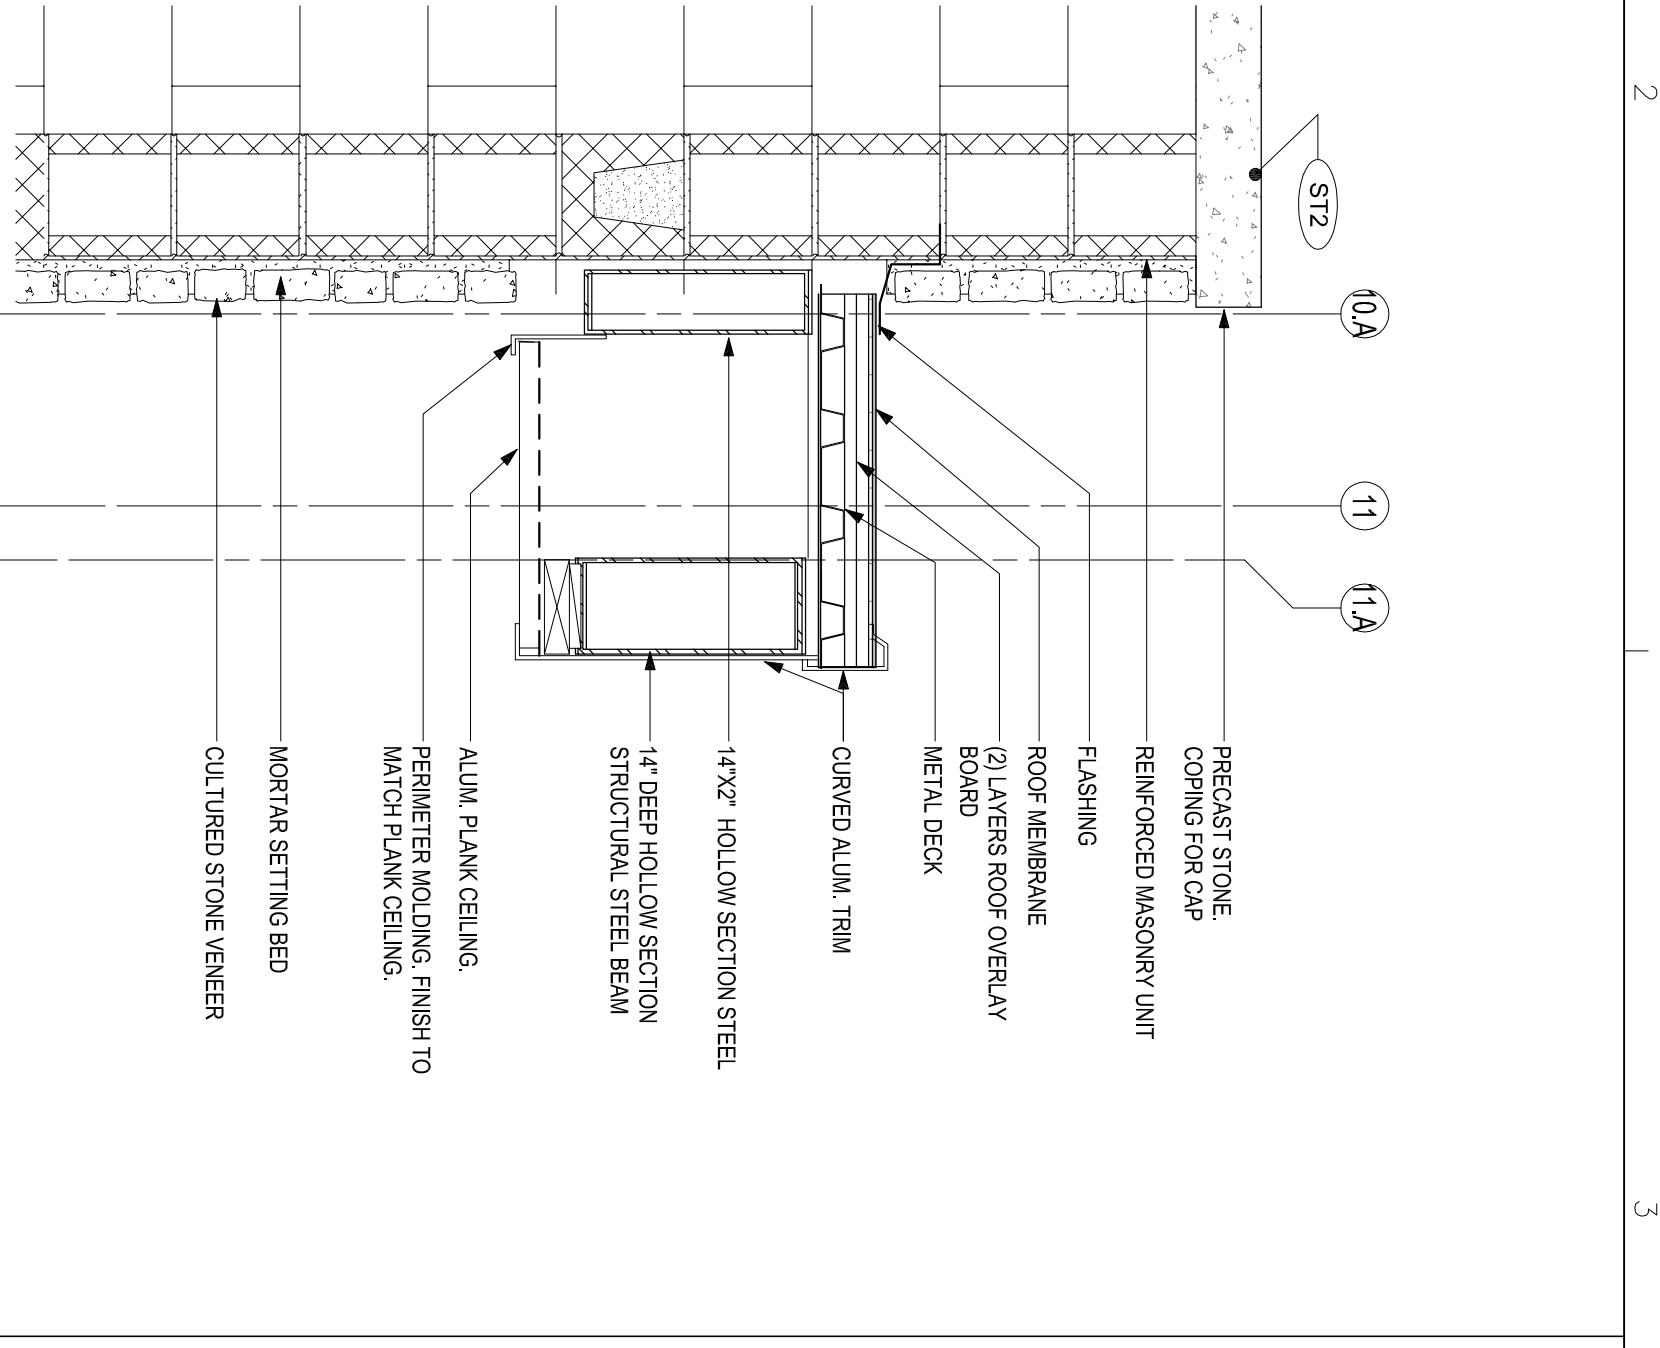



**3B**  
PORTE COCHERE PRECAST BENCH DETAIL  
SCALE 1"=1'-0"

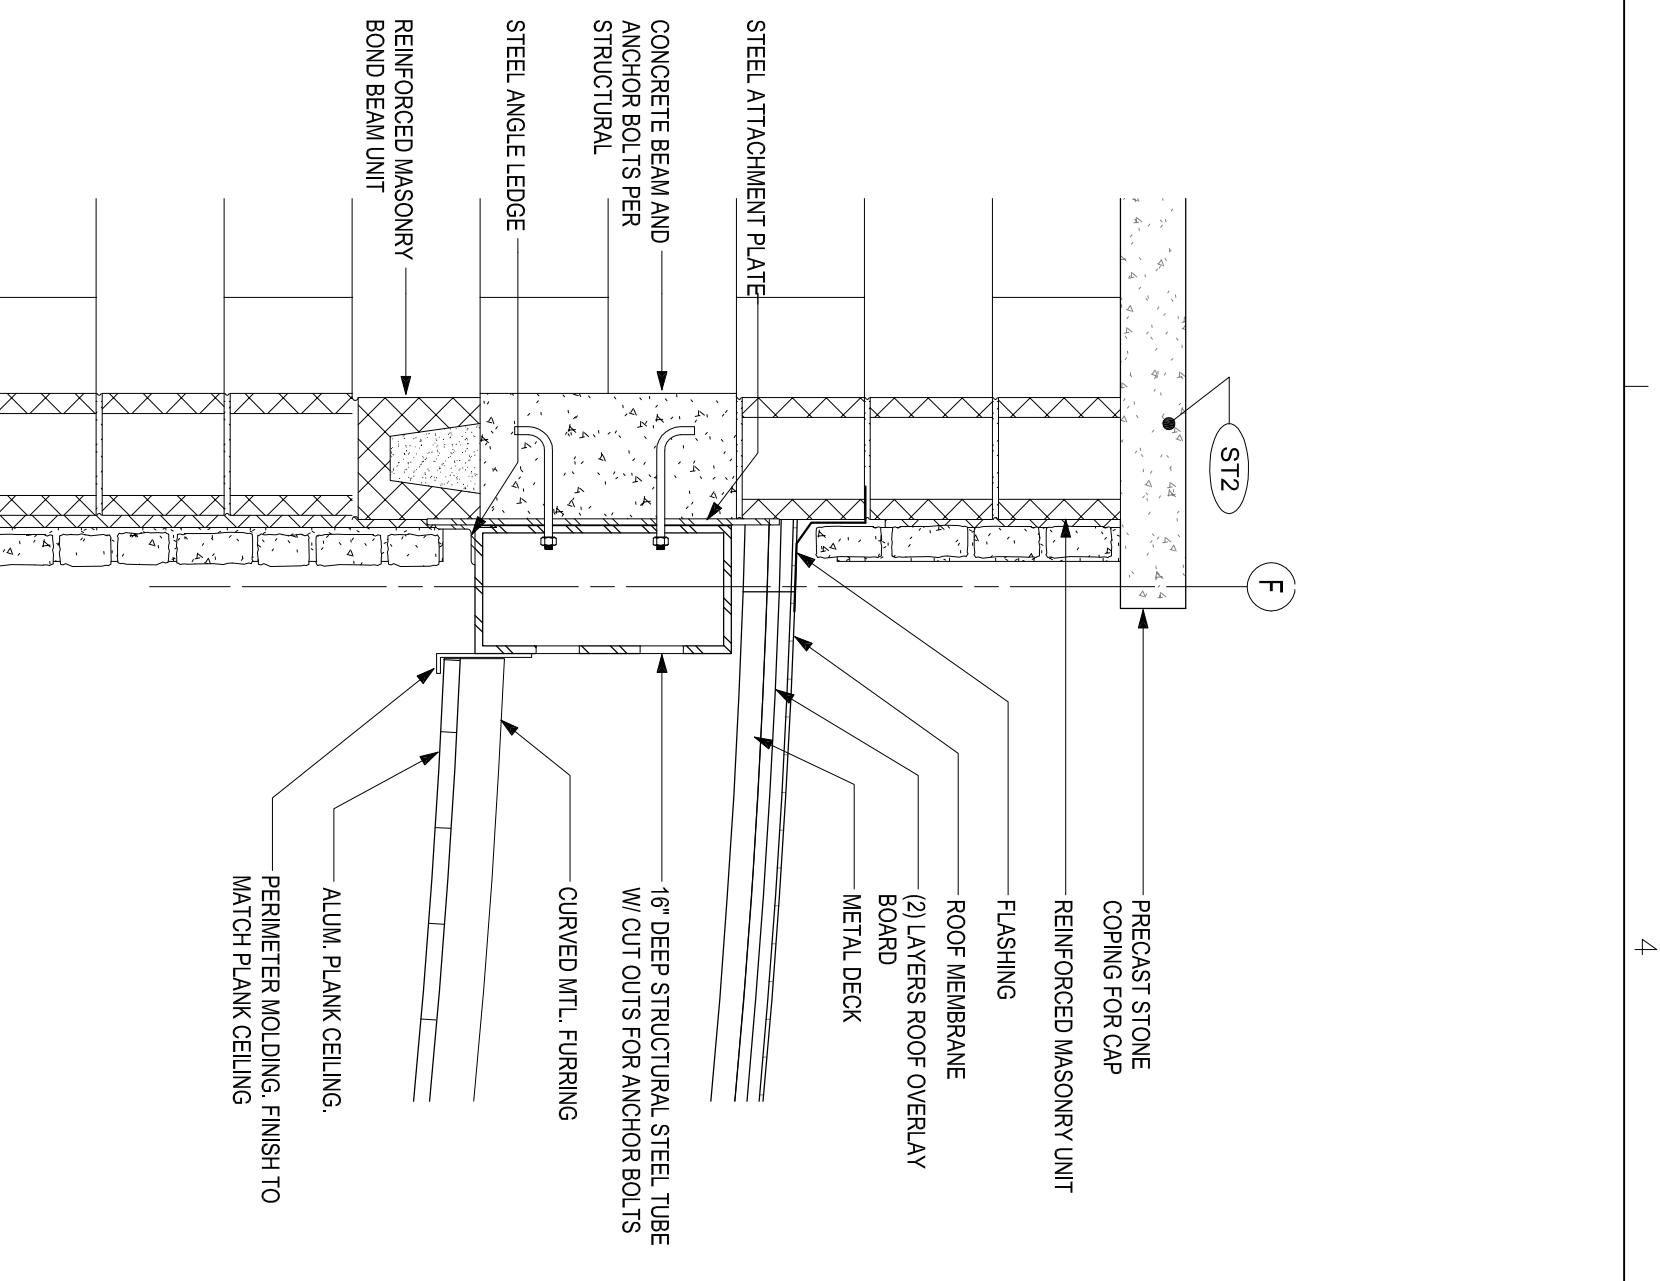


**4D**  
BEAM CONNECTION AT BEARING WALL  
SCALE 1"=1'-0"

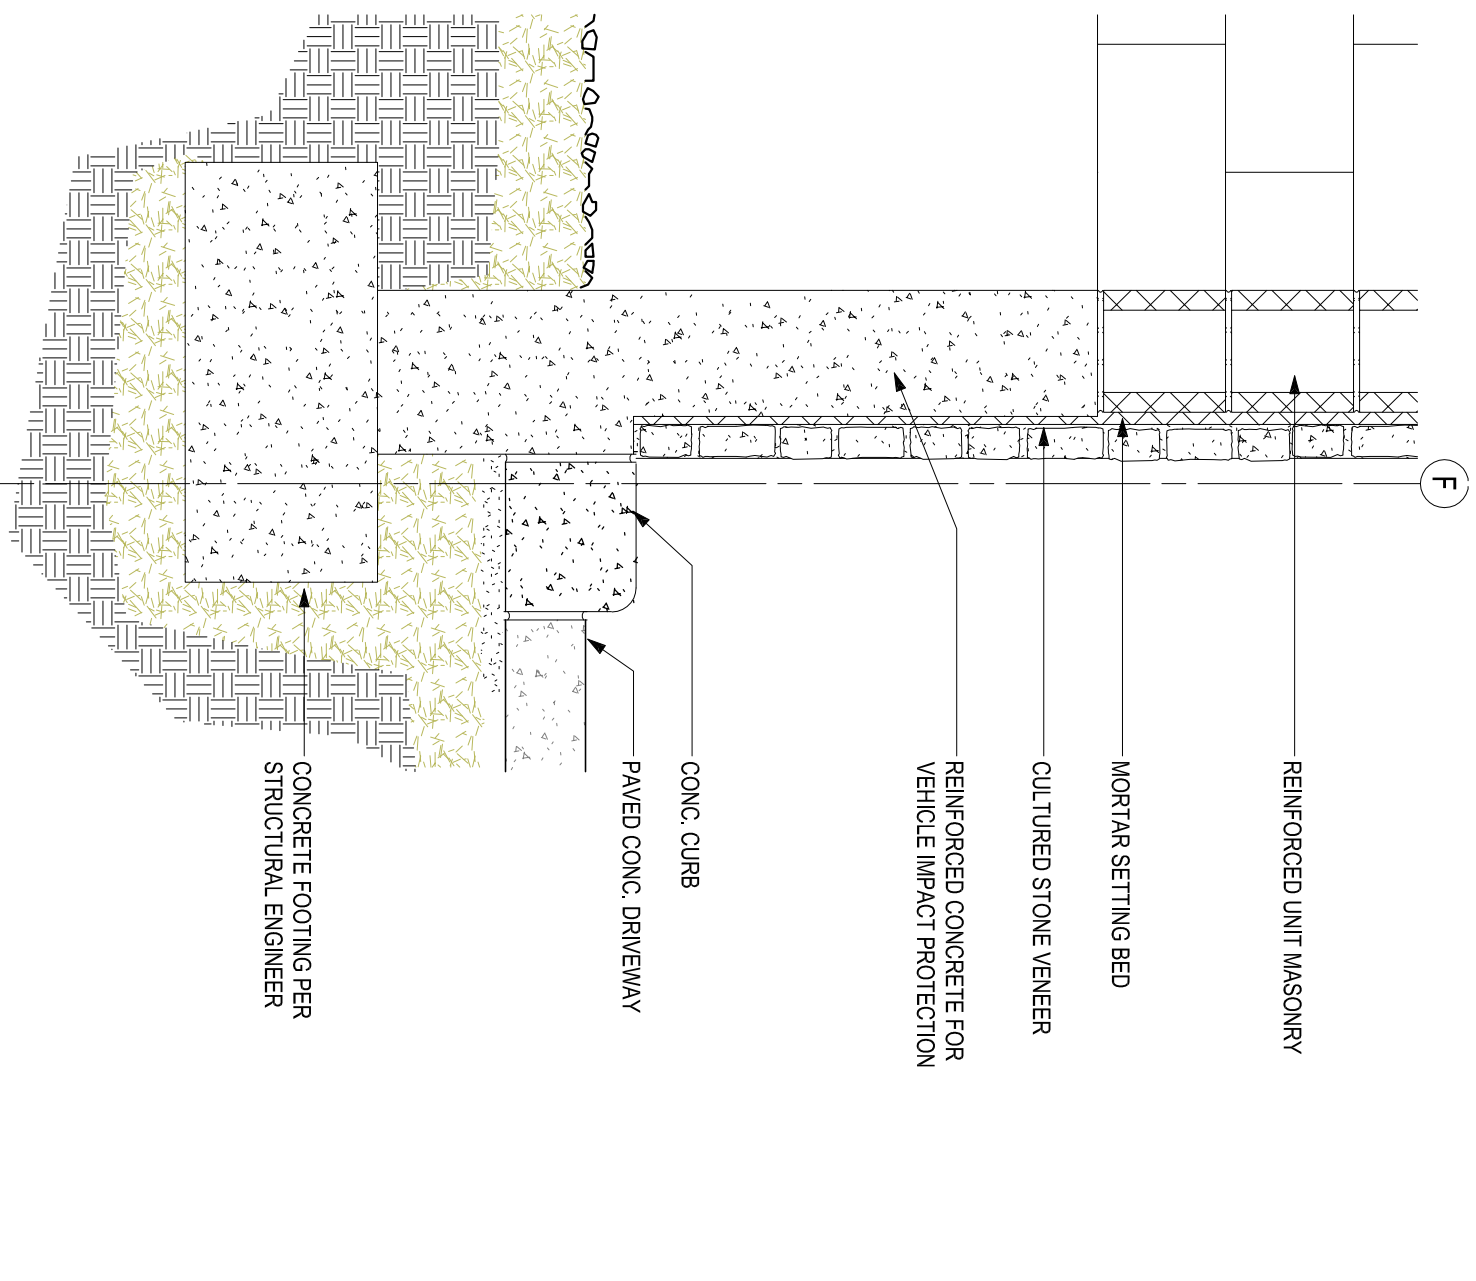


**4B**  
REINFORCED BEARING WALL FOOTING  
SCALE 1"=1'-0"

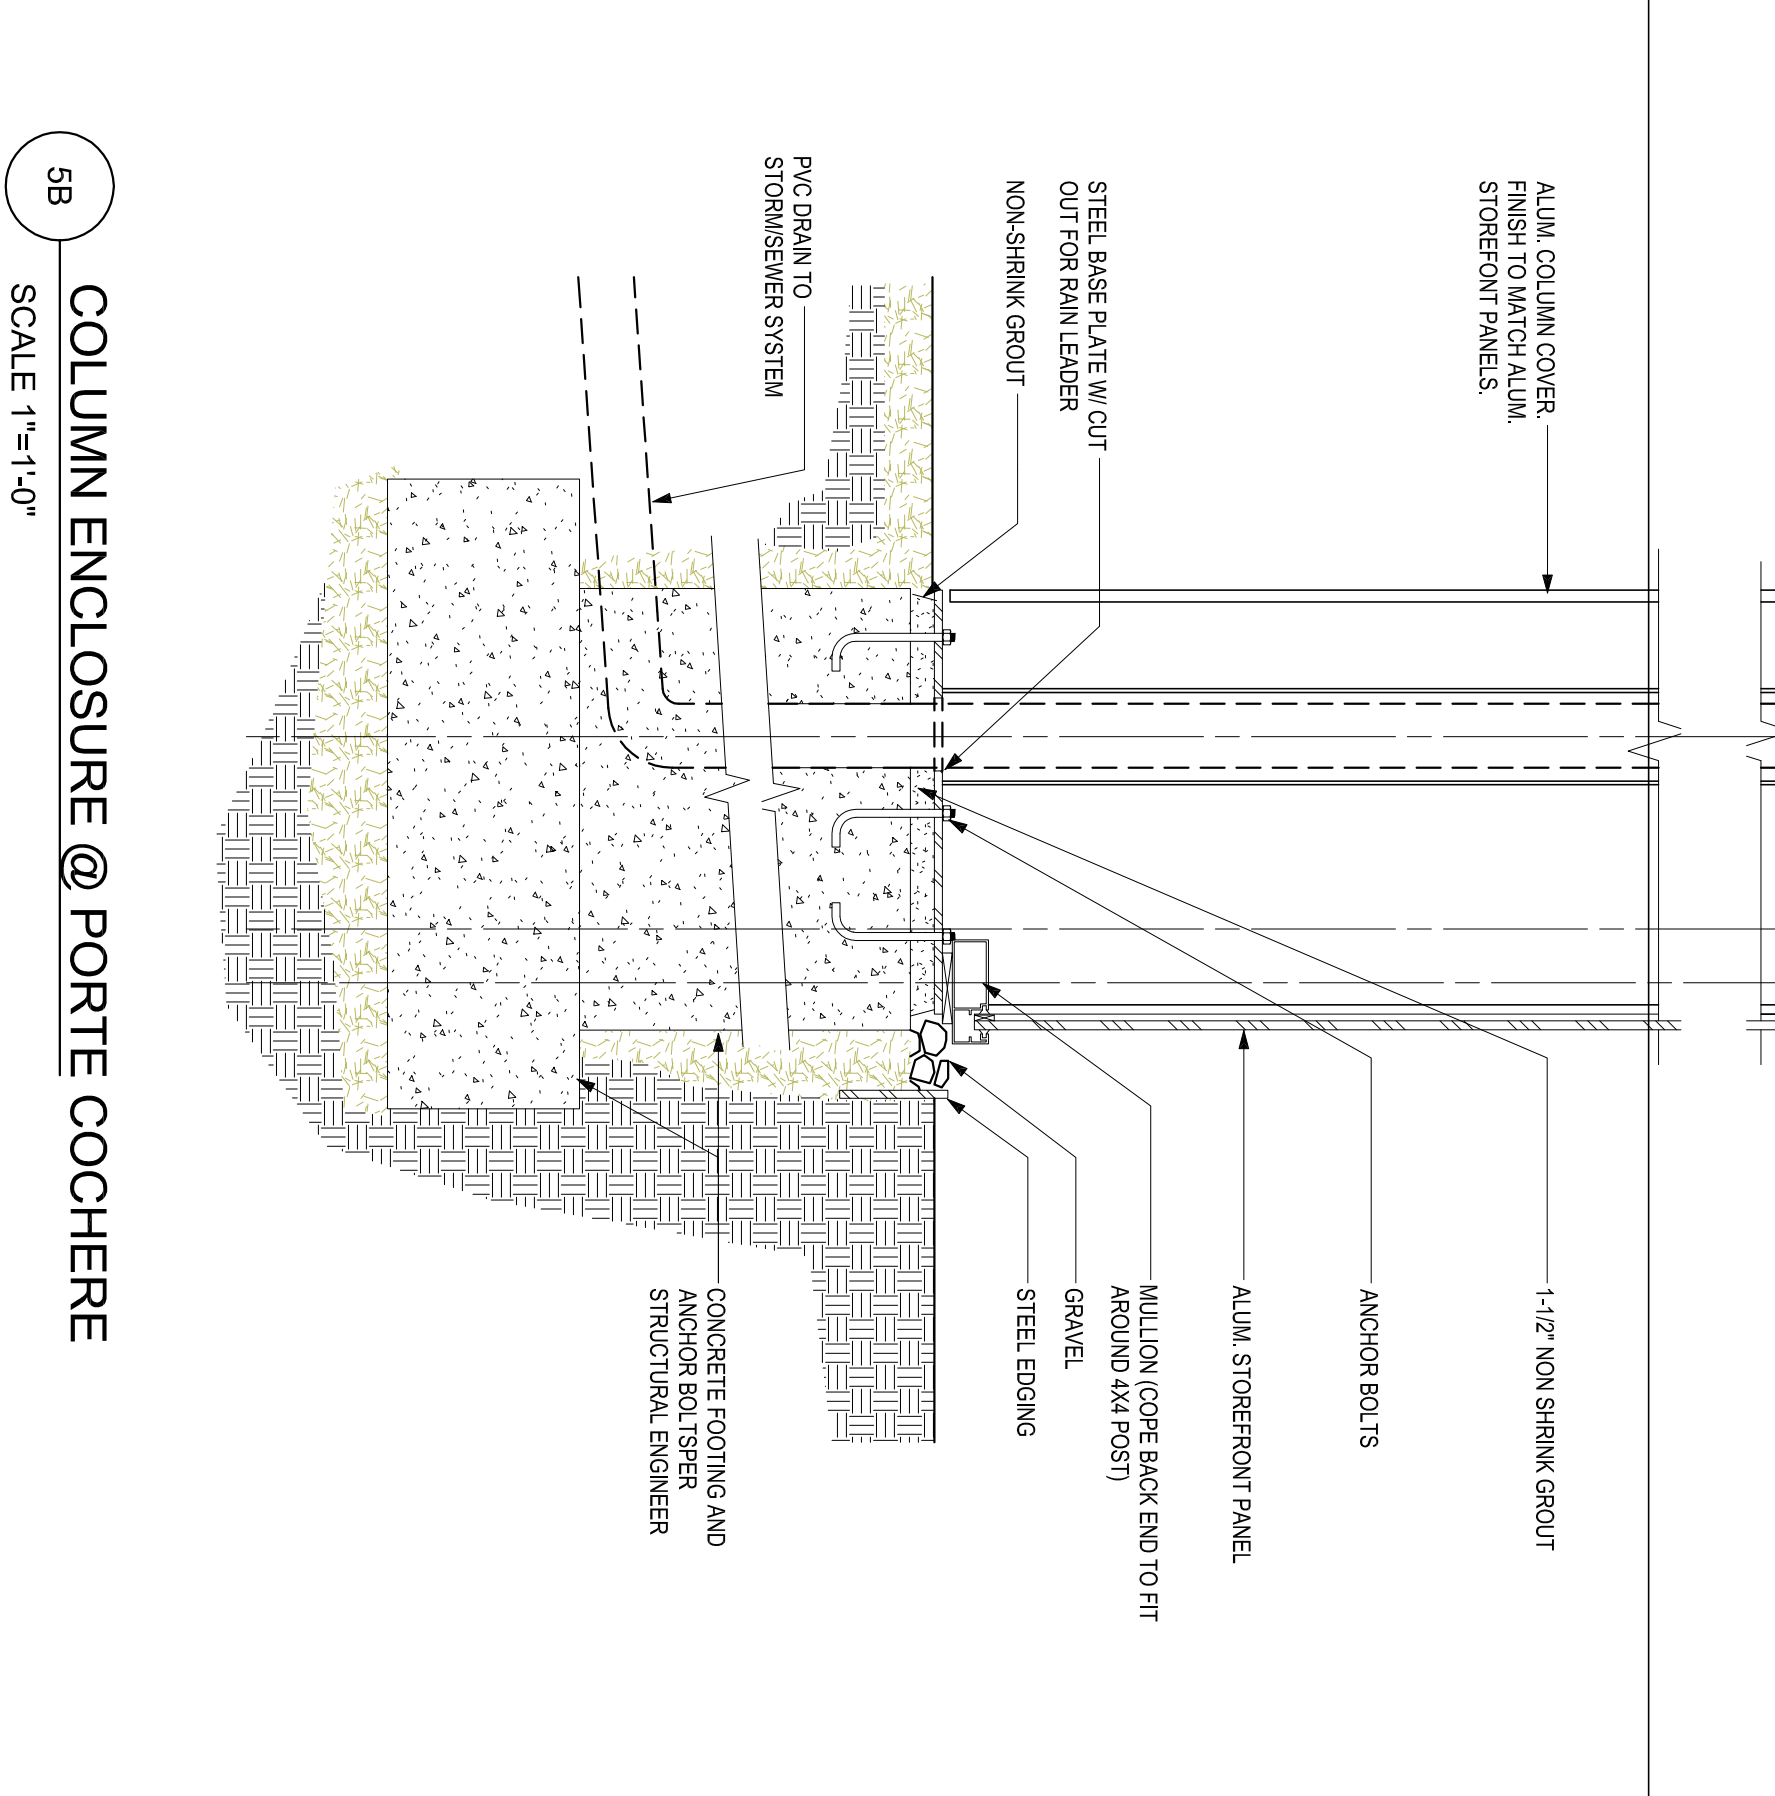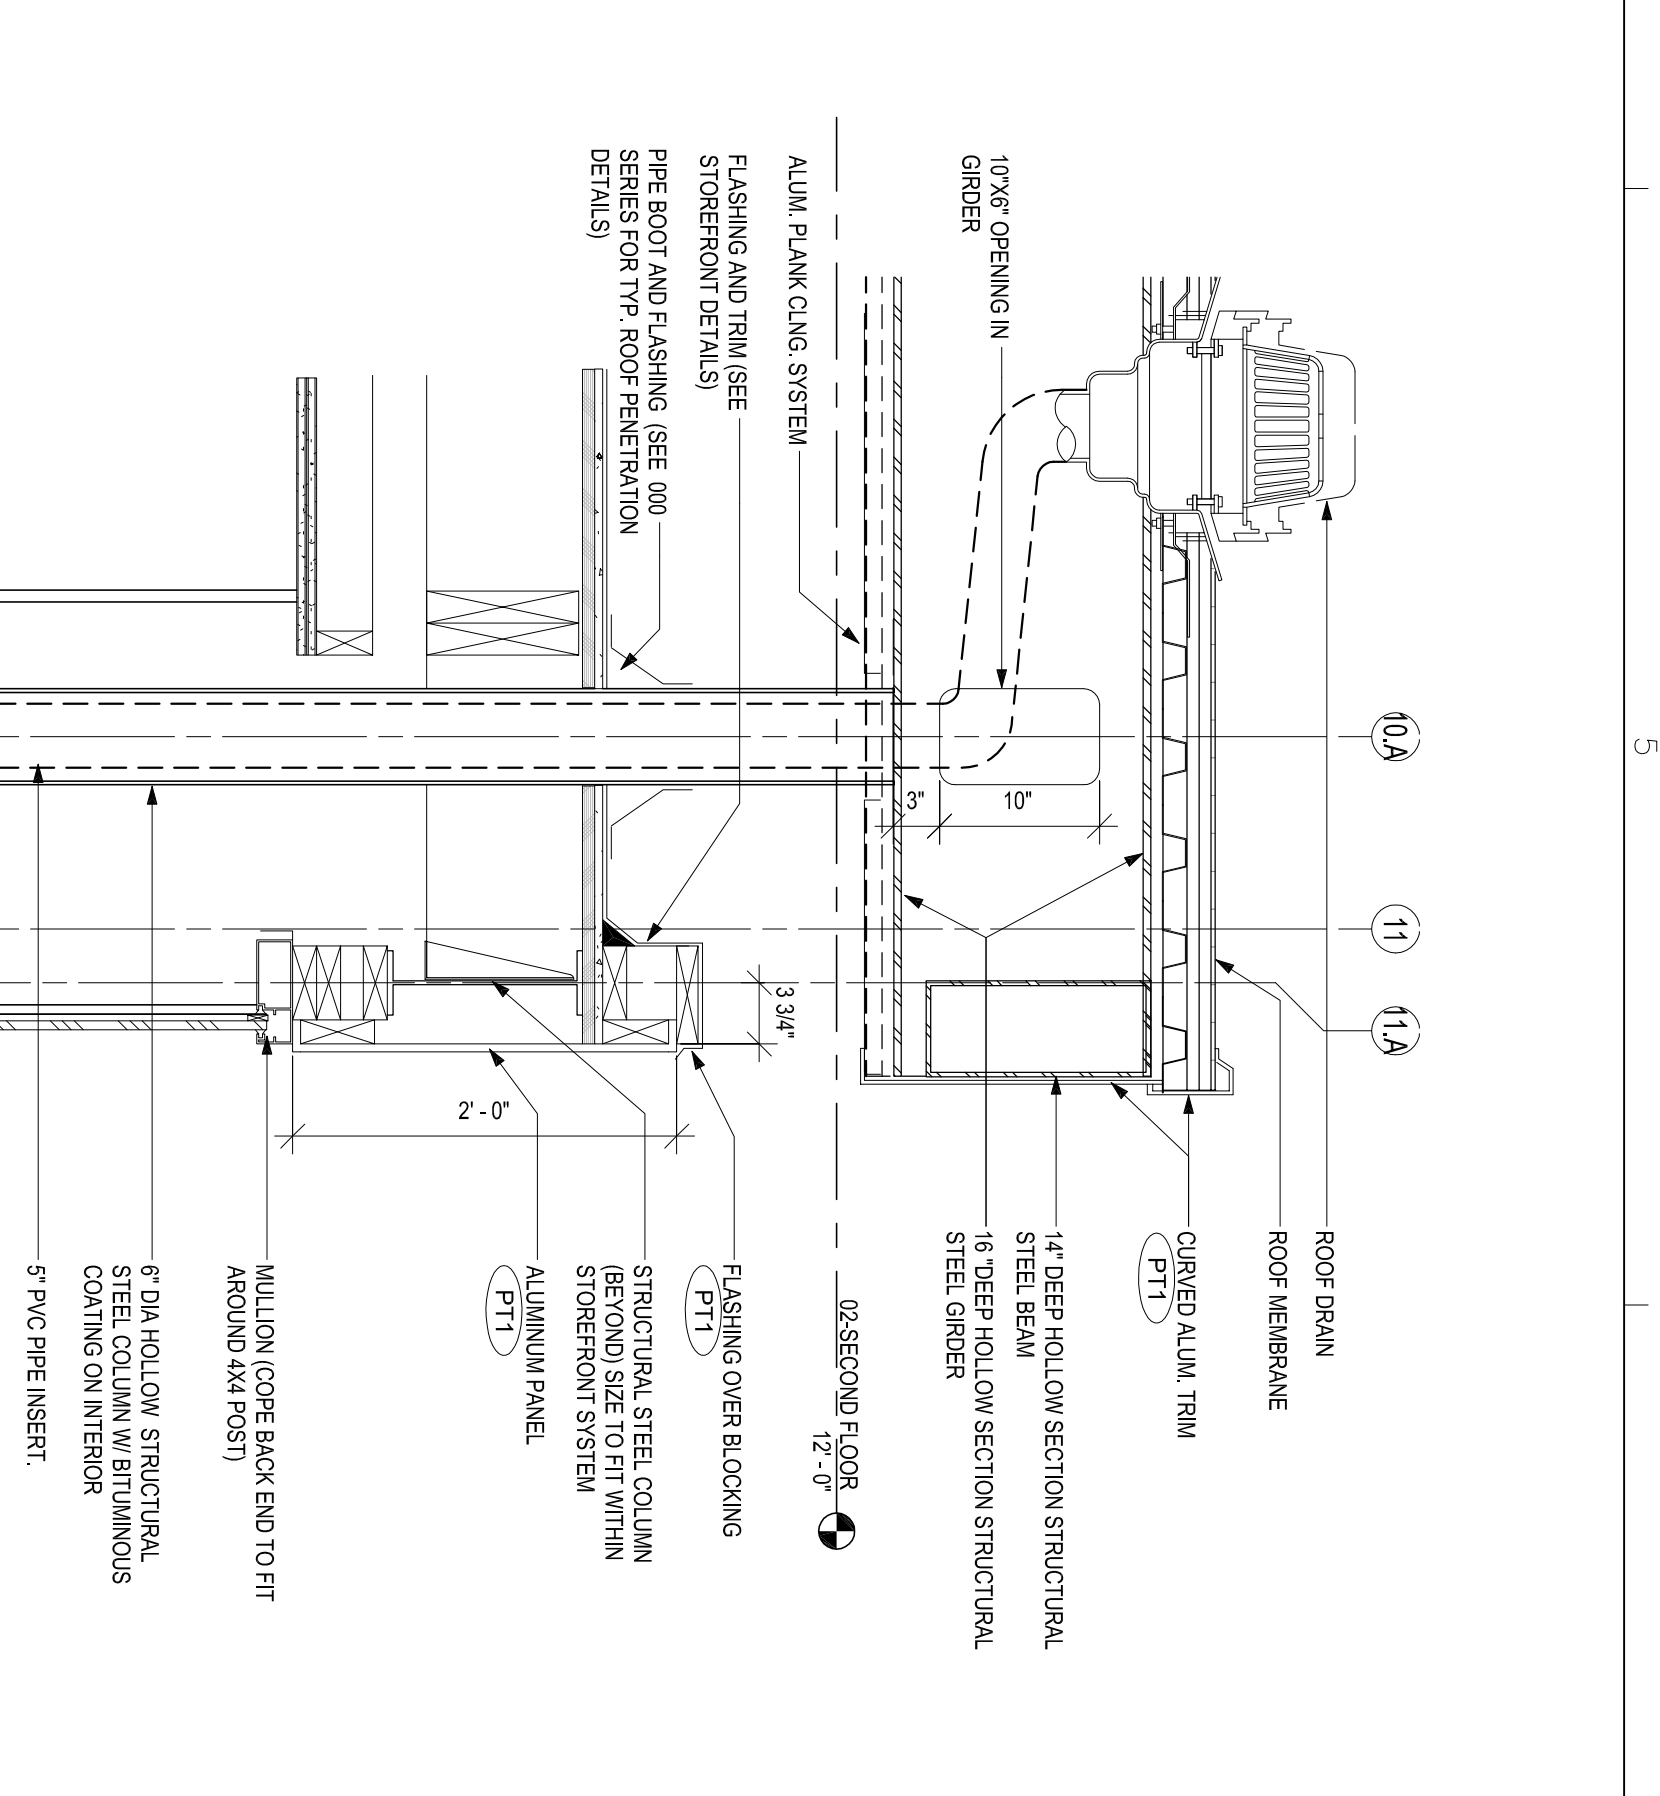


**5B**  
COLUMN ENCLOSURE @ PORTE COCHERE  
SCALE 1"=1'-0"

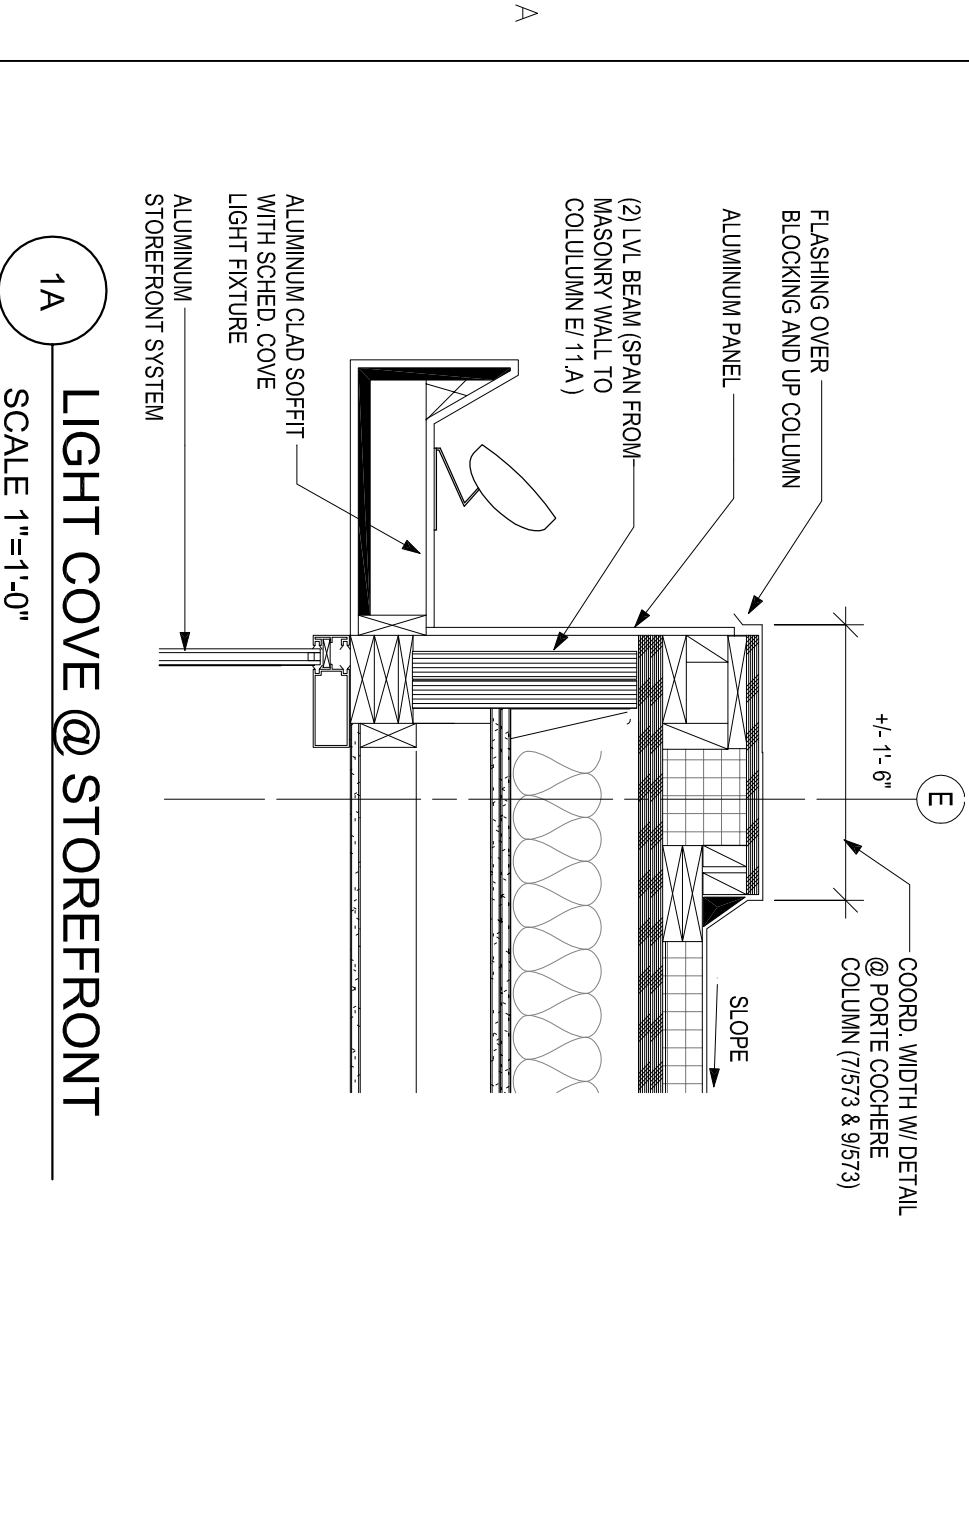

**1A**  
LIGHT COVE @ STOREFRONT  
SCALE 1"=1'-0"

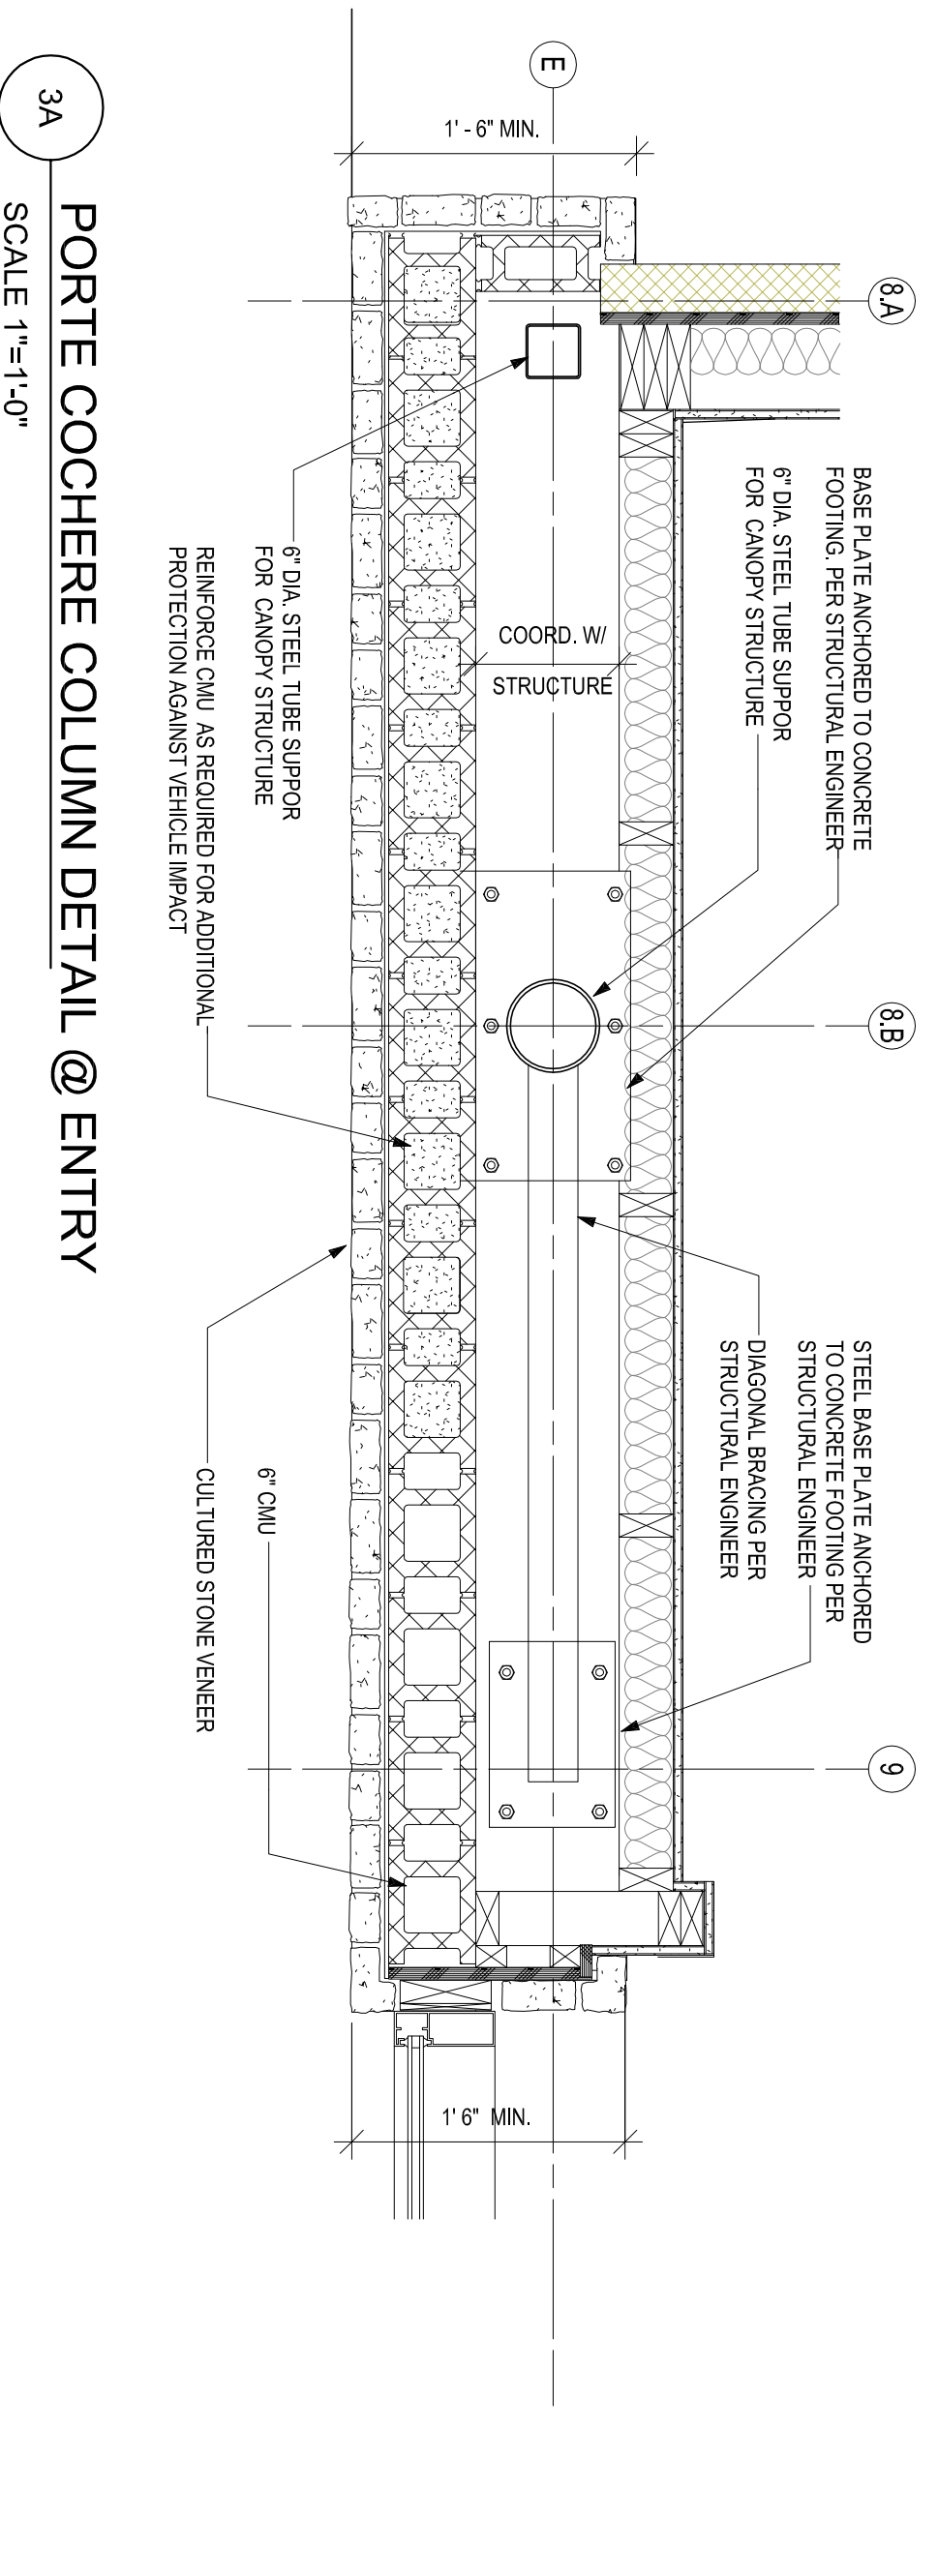

**3A**  
PORTE COCHERE COLUMN DETAIL @ ENTRY  
SCALE 1"=1'-0"

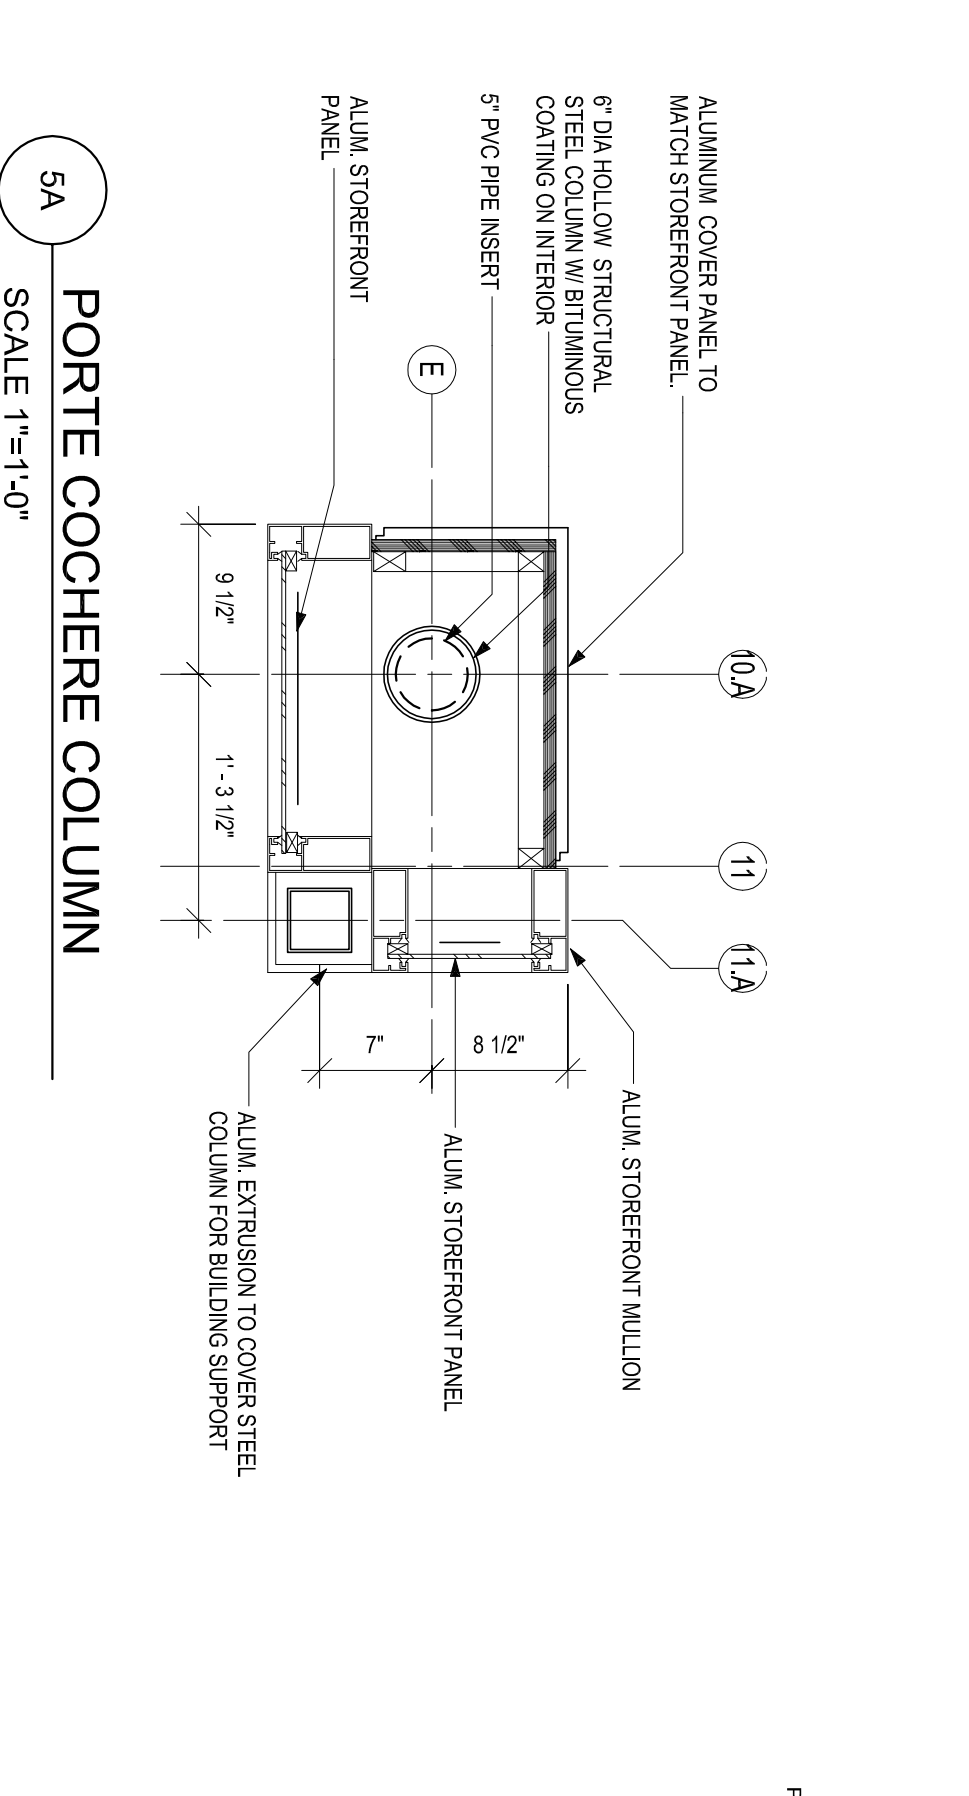

**5A**  
PORTE COCHERE COLUMN  
SCALE 1"=1'-0"

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CONSULTANTS

ISSUES & REVISIONS


NO.	DATE	DESCRIPTION
1	09/22/15	30% REVIEW SET
2	11/02/2015	90% REVIEW SET
3	12/22/2015	100% REVIEW SET

PROJECT NAME:  
DRAWING NUMBER: 15180

DRAWING NAME:  
PORTE-COCHERE & ROOF SHADE  
CANOPY DETAILS


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CHECKED BY: BBC  
DATE: 12-22-15  
SCALE: AS NOTED

DRAWING NUMBER:  
**AG11**

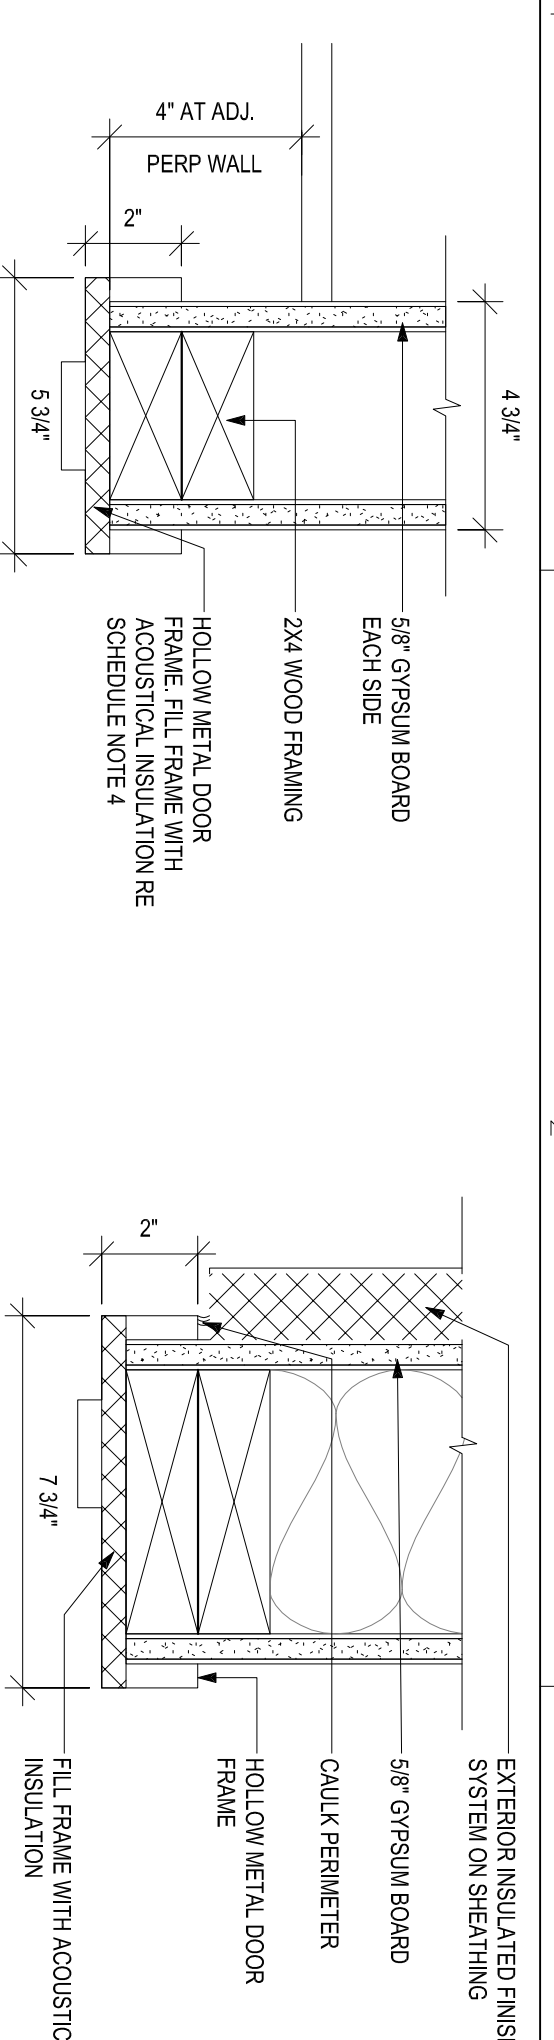


**2 INTERIOR DOOR JAMB**  
3" = 1'-0"


**3 EXTERIOR DOOR HEAD**  
3" = 1'-0"

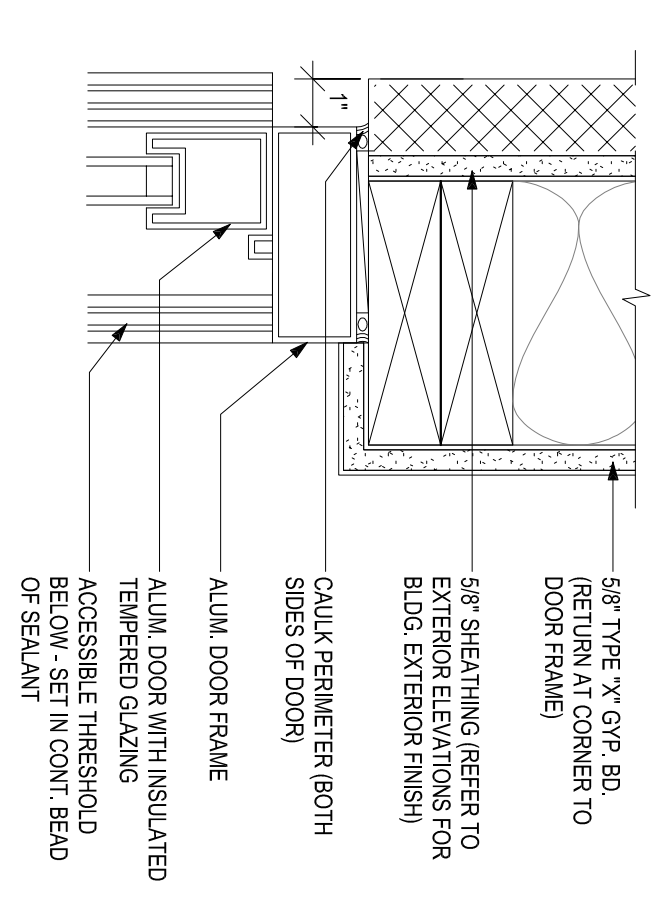


**4 EXTERIOR DOOR JAMB**  
3" = 1'-0"

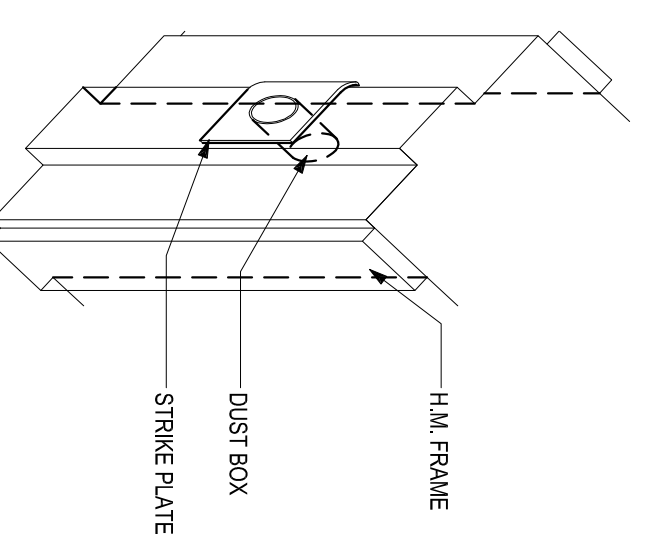

**5 INTERIOR DOOR HATCH**  
3" = 1'-0"

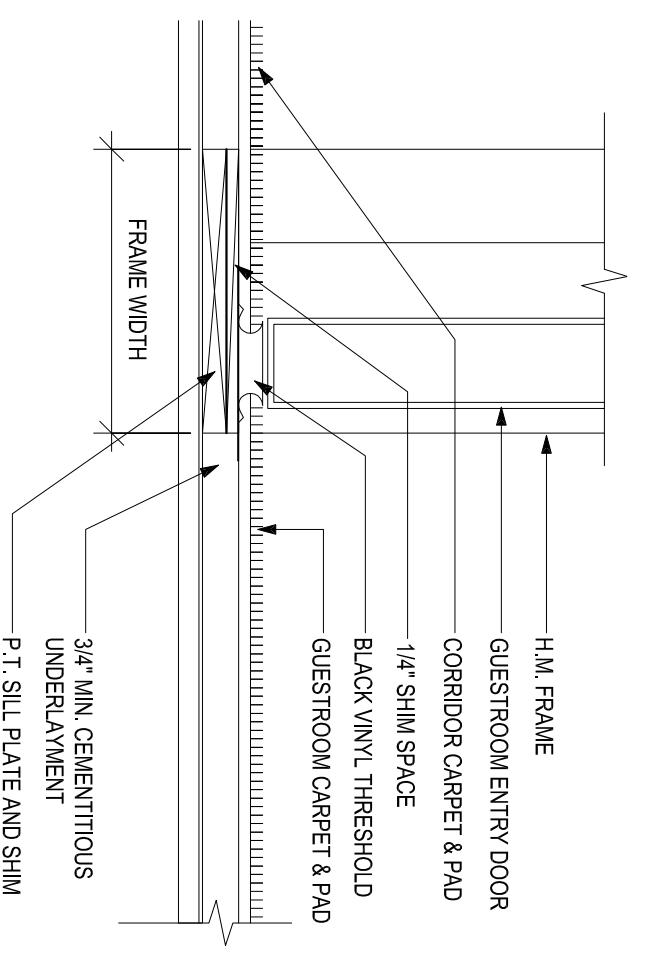

**6 RESILIENT THRESHOLD & DOOR**  
3" = 1'-0"

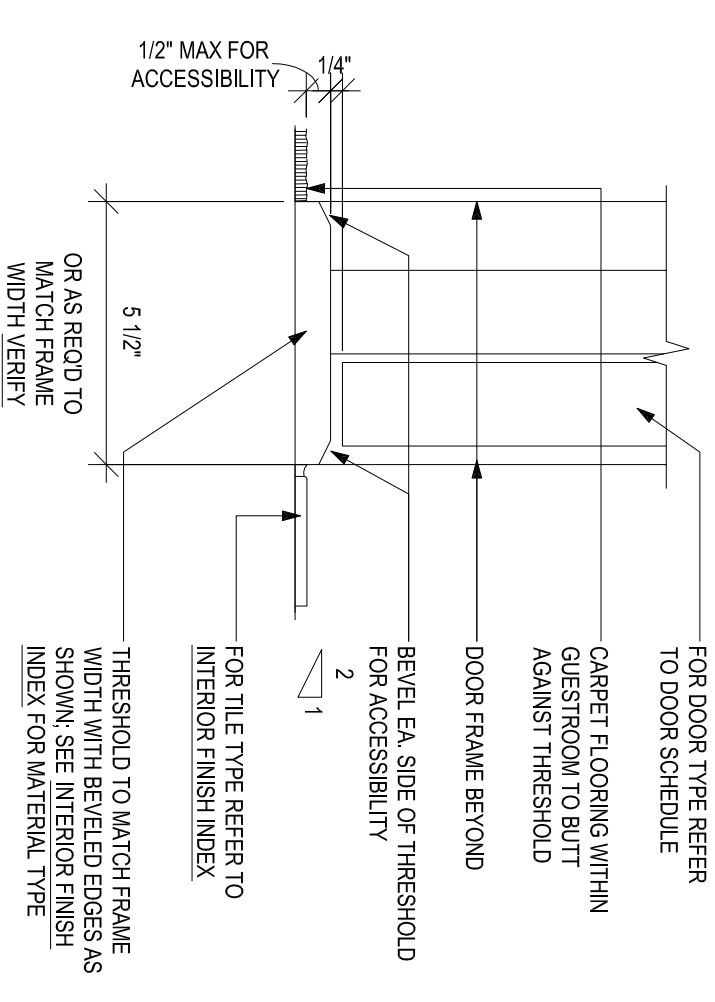


**10 DOOR THRESHOLD**  
3" = 1'-0"

#	LOCATION	W	H	THK	ELEV	DOOR MAT.	DOOR FINISH	THRESHOLD	HGW	FRAME MAT.	RATING	NOTES
01	GUESTROOMS	3'-0"	6'-6"	1 3/4"	C	SCWD	FLAM			HM	20 MIN	
01A	GUEST ENTRY	3'-0"	6'-6"	1 3/4"	C	SCWD	FLAM			HM	20 MIN	
02	GUEST ENTRY ACCESSIBLE	3'-0"	6'-6"	1 3/4"	C	SCWD	FLAM			HM	20 MIN	
02A	GUEST BATH	3'-0"	6'-6"	1 3/4"	B	FLAM	FI			HM	20 MIN	
03	ACCESSIBLE GUEST BATH	3'-0"	6'-6"	1 3/4"	B	FLAM	FI			HM	20 MIN	
04	COMMUNICATING DOOR	3'-0"	6'-6"	1 3/4"	B	SCWD	FLAM			HM	45 MIN	
02	PUBLIC SPACE - FIRST FLOOR											
14	NEW WOMEN	3'-0"	6'-6"	1 3/4"	B	SCWD	FLAM	MARBLE		HM	20 MIN	
15	VESTIBULE (INTERIOR)	6'-0"	7'-6"	1 3/4"	J	ALUM	CLR. ANOD			ALUM	20 MIN	FINISH TO MATCH TYP STOREFRONT
16	FOOD PREP (BUFFET)	3'-0"	6'-6"	1 3/4"	G	SCWD	FLAM			HM	20 MIN	
17	JANITOR'S CLOSET	3'-0"	6'-6"	1 3/4"	B	SCWD	FLAM			HM	20 MIN	
18	THEATER	3'-0"	6'-6"	1 3/4"	E	SCWD	FLAM			HM	20 MIN	
19	LOCKER ROOM	3'-0"	6'-6"	1 3/4"	B	FLAM	FI			HM	20 MIN	
20	WORK ENTRY	3'-0"	6'-6"	1 3/4"	B	SCWD	FLAM			HM	20 MIN	
21	WORK ROOM	3'-0"	6'-6"	1 3/4"	B	FLAM	FI			HM	20 MIN	USE 2098 AND 2099 DOORS IF 6" WIDTH WILL NOT FIT
22	WORK STORAGE	3'-0"	6'-6"	1 3/4"	B	SCWD	FLAM			HM	20 MIN	
23	LAUNDRY (INTERNAL)	3'-0"	6'-6"	1 3/4"	B	SCWD	FLAM			HM	20 MIN	
24	BREAK ROOM	4'-0"	6'-6"	1 3/4"	E	SCWD	FLAM			HM	20 MIN	
25	MANAGER	3'-0"	6'-6"	1 3/4"	E	SCWD	FLAM			HM	20 MIN	
26	FITNESS RM	5'-0"	7'-6"	1 3/4"	A-1	ALUM	CLR. ANOD			HM	20 MIN	
27	LAUNDRY	3'-0"	6'-6"	1 3/4"	B	SCWD	FLAM			HM	45 MIN	
28	ELECTRICAL	3'-0"	6'-6"	1 3/4"	B	SCWD	FLAM			HM	45 MIN	
34	WATER HEATER	3'-0"	6'-6"	1 3/4"	B	HM	PTD			HM	20 MIN	
36	FOOD STORAGE - (CORRIDOR)	3'-0"	6'-6"	1 3/4"	B	SCWD	FLAM			HM	20 MIN	
03	GUESTROOM CORRIDOR	3'-0"	6'-6"	1 3/4"	B	HM	PTD			HM		SECOND FLOOR DOOR ELEVATION 'G'
40	LOBBY / GUEST LAUNDRY / MOP	3'-0"	6'-6"	1 3/4"	B	HM	PTD			HM		
04	STAR ELEVATORS											
50	STAR NO. 1 (INTERIOR)	3'-0"	6'-6"	1 3/4"	G	SCWD	FLAM			HM	60 MIN	WALL MANSIES TO BE TIED INTO FIRE ALARM SYSTEM
51	STAR NO. 1 (EXTERIOR)	3'-0"	6'-6"	1 3/4"	B	HM	PTD			HM	60 MIN	
51A	MAIN ELEC. (EXTERIOR)	3'-0"	6'-6"	1 3/4"	B	HM	PTD			HM	60 MIN	
29	STAR (INTERIOR)	3'-0"	6'-6"	1 3/4"	G	SCWD	PTD			HM	60 MIN	
05	EXTERIOR DOOR	5'-0"	7'-6"	1 3/4"	A-1	ALUM	CLR. ANOD			ALUM		FINISH TO MATCH TYP STOREFRONT
60	CORRIDOR TO EXTERIOR	6'-0"	7'-6"	1 3/4"	J	ALUM	CLR. ANOD			ALUM		FINISH TO MATCH TYP STOREFRONT
61	CELS BATH (EXTERIOR)	6'-0"	7'-6"	1 3/4"	B	FLAM	FI			HM		FINISH TO MATCH TYP STOREFRONT
62	CELS BATH (INTERIOR)	3'-0"	6'-6"	1 3/4"	B	SCWD	FLAM			HM		FINISH TO MATCH TYP STOREFRONT
63	PAUSE ROOM TO EXTERIOR	3'-0"	6'-6"	1 3/4"	BB	HM	PTD			HM		GALVANIZED FRAME
64	PAUSE ROOM TO EXTERIOR	3'-0"	6'-6"	1 3/4"	B	HM	PTD			HM		GALVANIZED FRAME
65	PASSAGE TO EXTERIOR	3'-0"	7'-6"	1 3/4"	A	ALUM	CLR. ANOD			ALUM		FINISH TO MATCH TYP STOREFRONT (S)
66	CHEMICAL	3'-0"	7'-6"	1 3/4"	B	HM	PTD			HM		LOUVERED DOOR
69	BUFFET TO EXTERIOR	3'-0"	7'-6"	1 3/4"	A-1	ALUM	CLR. ANOD			ALUM		FINISH TO MATCH TYP STOREFRONT (S)
68	POOL TO COURTYARD	3'-0"	6'-6"	1 3/4"	B	HM	PTD			HM		
06	MISCELLANEOUS											
70	ROOM TOP EQUIPMENT	3'-0"	5'-0"	1 3/4"	B	HM	PTD			HM		OUTDOOR HVAC EQUIP. COURT GATE. MATCH FENCE

**600 DOOR SCHED (DESIGN OPTIONS)**

ID	DESCRIPTION	W	H	THK	ELEV	DOOR MAT.	DOOR FINISH	THRESHOLD	HGW	FRAME MAT.	RATING	NOTES
02	PUBLIC SPACE											
11	INDOOR POOL VESTIBULE	5'-0"	7'-6"	1 3/4"	A-1	ALUM	CLR. ANOD			ALUM		INDOOR POOL (S)
12	INDOOR POOL	5'-0"	7'-6"	1 3/4"	A-1	ALUM	CLR. ANOD			ALUM		INDOOR POOL (S)
67	MECHANICAL	3'-0"	3'-0"	1 3/4"	B	HM	PTD			HM		LOUVERED DOOR

GENERAL NOTES:  
1. SEE SHEET AAMB4A OR 97Z FOR AUTOMATIC ENTRY DOOR ELEVATIONS  
2. T1 = TEMPERED GLAZING  
3. CLEAR TEMPERED GLAZING  
4. SEE PLAN

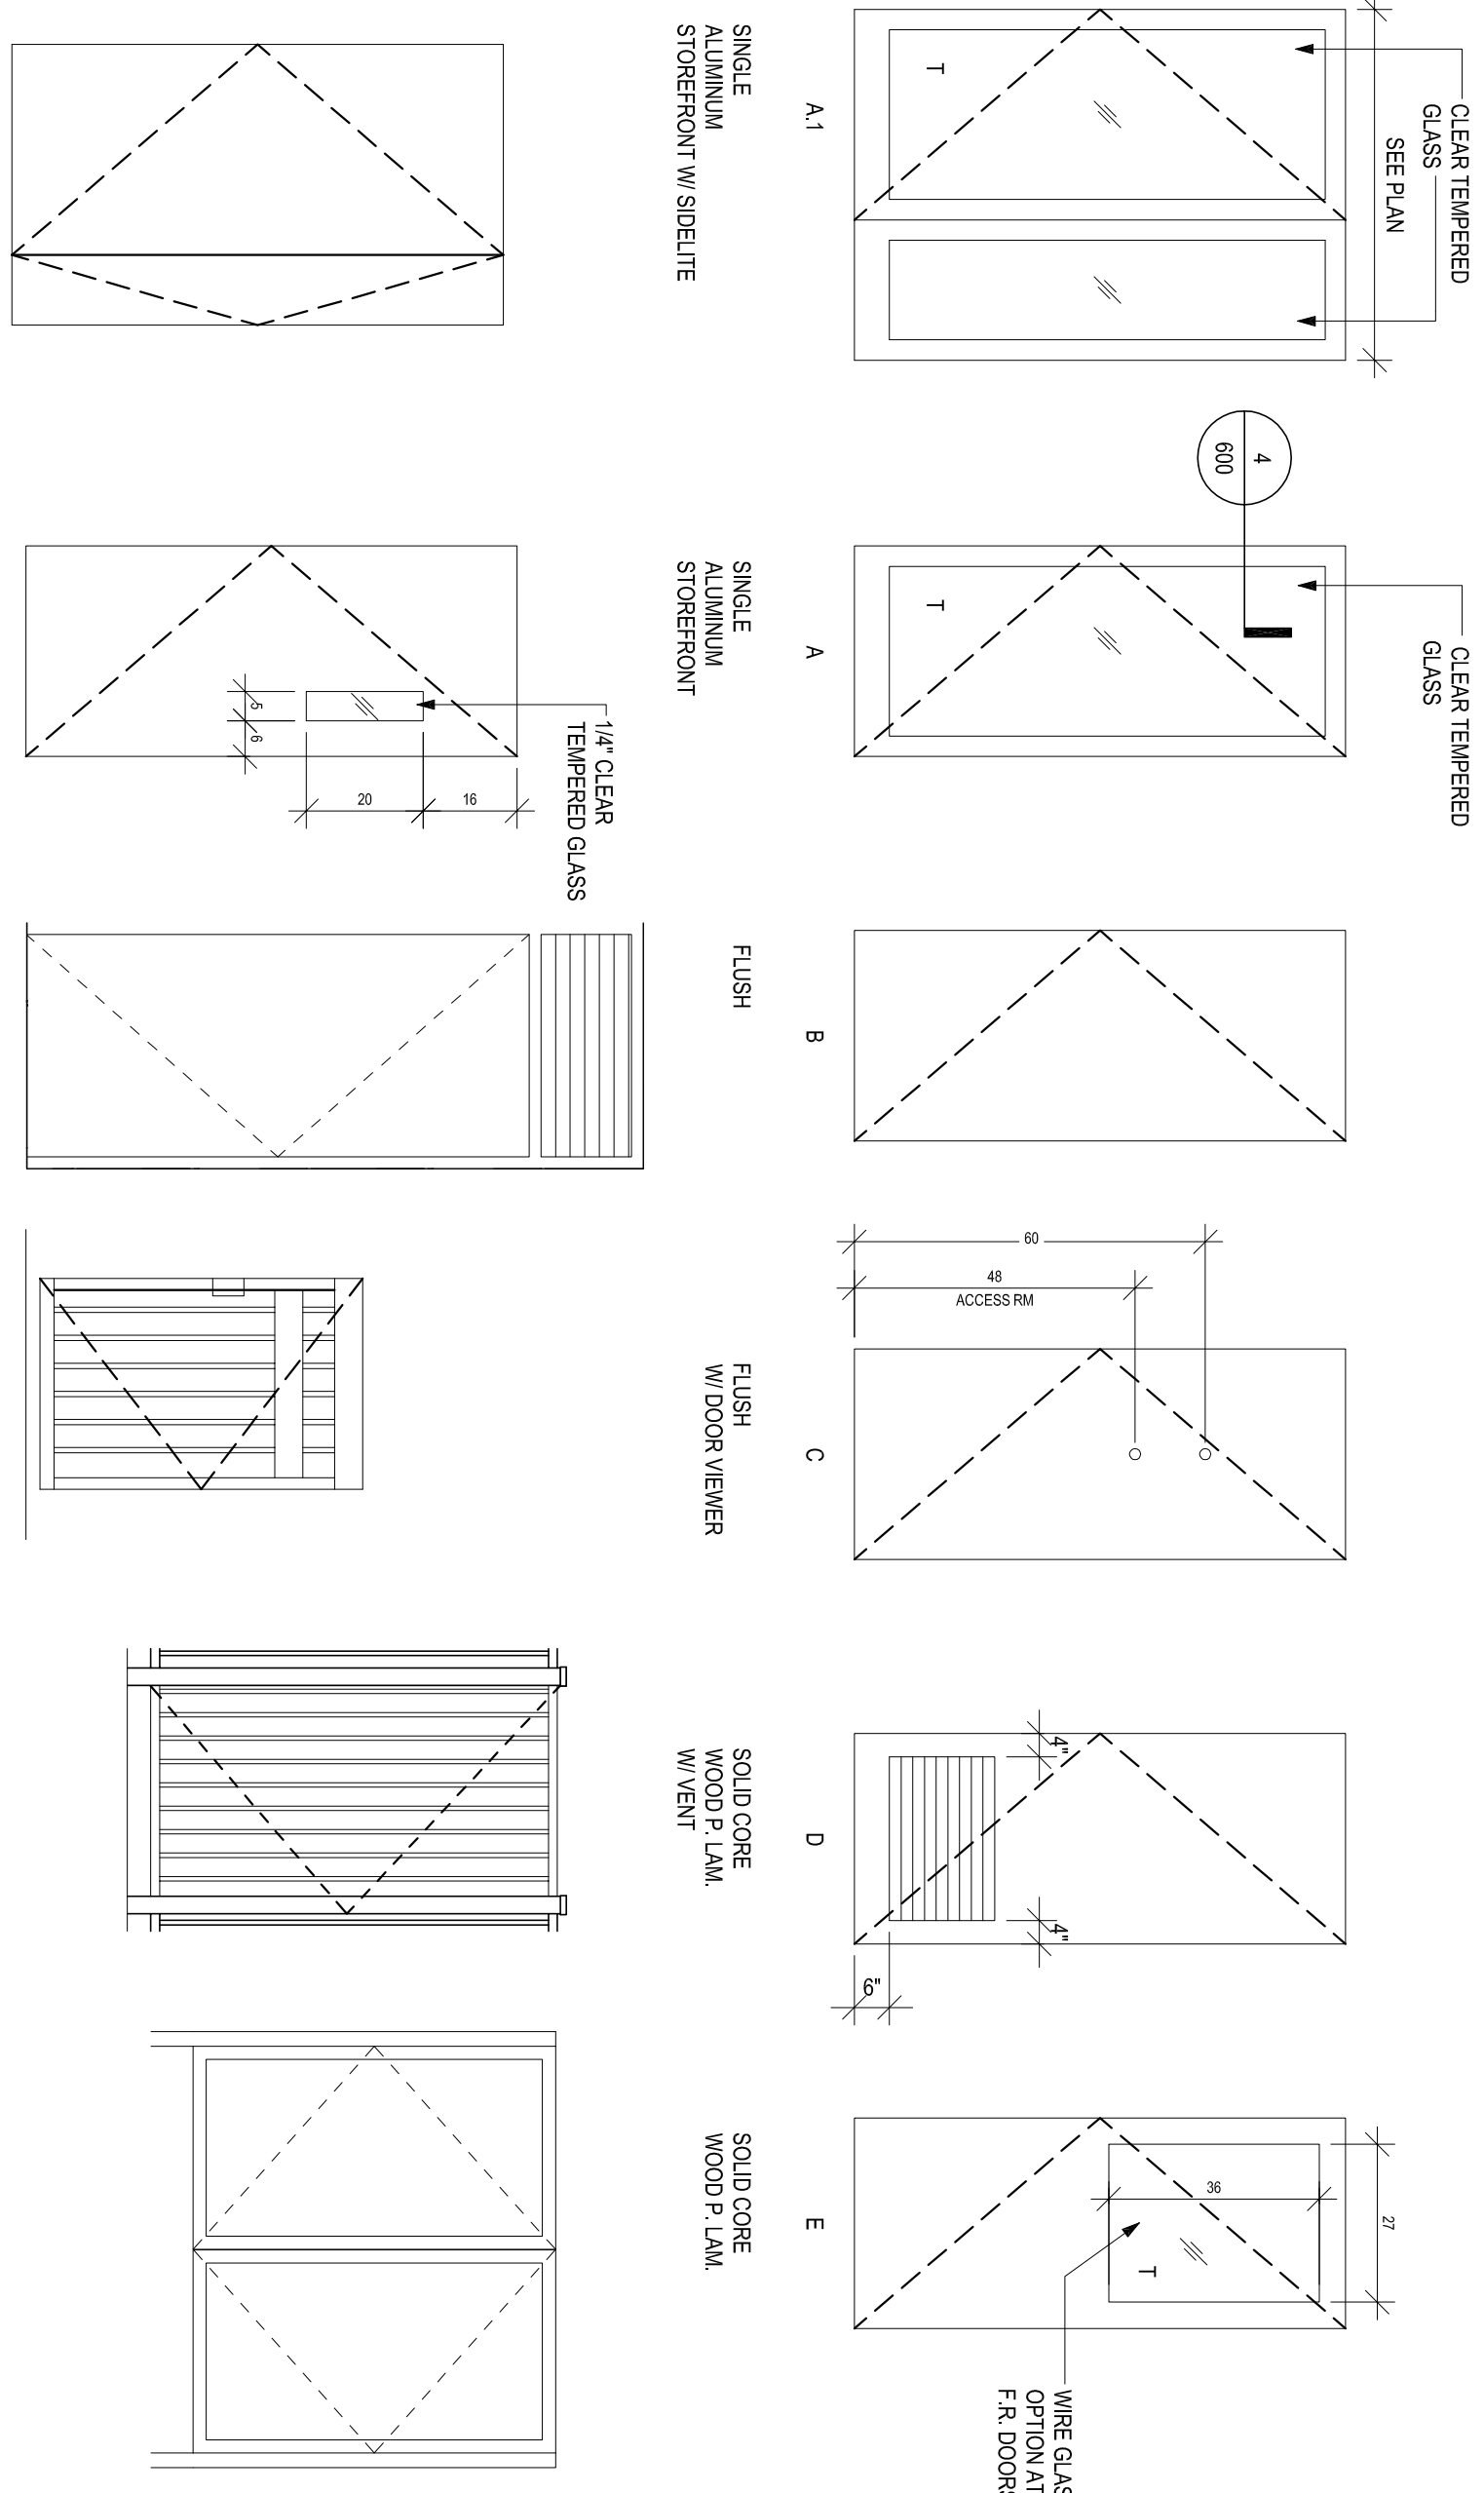

**9 DOOR TYPES**  
3/8" = 1'-0"

PLEASE NOTE: SEE SHEET 610 FOR DOOR TYPE 'J'

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BY  
**MARRIOTT**  
290 POWER DRIVE,  
BATESVILLE, MS 38606

100% REVIEW SET  
CONSTRUCTION

ISSUES & REVISIONS

NO.	DATE	DESCRIPTION
1	09/27/2015	30% REVIEW SET
2	11/22/2015	50% REVIEW SET
3	1/22/2016	100% REVIEW SET

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PROJECT NAME:  
PROJECT NUMBER: 151860  
DRAWING NAME:  
SHEET NAME:  
DOOR SCHEDULE

DRAWN BY: BNC  
CHECKED BY: BNC  
DATE: 12-22-15  
SCALE: AS NOTED  
DRAWING NUMBER:  
**A700**


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**CONSULTANTS**

NO.	DATE	DESCRIPTION
1	08/20/14	CODE SUBMITTAL

**ISSUES & REVISIONS**

NO.	DATE	DESCRIPTION

**PROJECT NAME:** \_\_\_\_\_

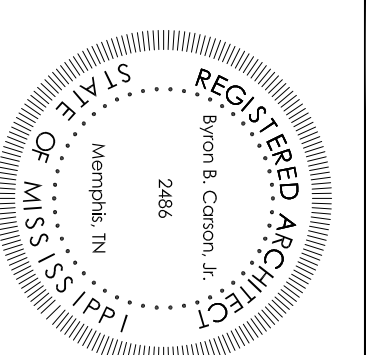**DRAWING NUMBER:** \_\_\_\_\_

**DRAWING NAME:** \_\_\_\_\_

**SHEET NAME:** \_\_\_\_\_

**WINDOW SCHEDULE & DETAILS**





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**CHECKED BY:** BCC/ANK  
**DATE:** 7-30-14  
**SCALE:** AS NOTED

**DRAWING NUMBER:** \_\_\_\_\_

A701

**611 WINDOW SCHEDULE**

TYPE	DESCRIPTION	LOCATION	W	H	ELEVATION	FRAME MATERIAL	WINDOW NOTES
A1	HORIZONTAL SLIDER	TYPICAL FLOOR GUESTROOM	6'-0"	6'-10"	1	ALUM./P/B	OPEN AWAY FROM PTAC - COORDINATE WITH DRAPERIES. PROVIDE BLANK PANEL FOR PTAC
A1	HORIZONTAL SLIDER	CENTER BAY ACCENT WINDOWS	6'-0"	6'-10"	2	ALUM./P/B	OPEN AWAY FROM PTAC - COORDINATE WITH DRAPERIES. PROVIDE BLANK PANEL FOR PTAC
B	HORIZONTAL SLIDER	TYPICAL FIRST FLOOR GUESTROOM	6'-0"	8'-0"	1	ALUM./P/B	OPEN AWAY FROM PTAC - COORDINATE WITH DRAPERIES. PROVIDE BLANK PANEL FOR PTAC
C	HORIZONTAL SLIDER	TYPICAL GUESTROOM (AT TRANSCREEN)	6'-0"	6'-10"	1	ALUM./P/B	OPEN AWAY FROM PTAC - COORDINATE WITH DRAPERIES. PROVIDE BLANK PANEL FOR PTAC
D	HORIZONTAL SLIDER	OFFICE (AT TRANSCREEN)	6'-0"	8'-0"	1	ALUM./P/B	OPEN AWAY FROM PTAC - COORDINATE WITH DRAPERIES. PROVIDE BLANK PANEL FOR PTAC
E1	FIXED LOUVER	LAUNDRY	6'-0"	2'-8"	3	ALUM./P/B	VENT WITH ALUM. FRAME TO MATCH OTHER WINDOWS
F	FIXED	CORRIDOR ENDS	3'-4"	6'-7"	4	ALUM./P/B	VENT WITH ALUM. FRAME TO MATCH OTHER WINDOWS
H	FIXED	BREAKFAST AREA	14'-6"	4'-8"	6	ALUM./P/B	

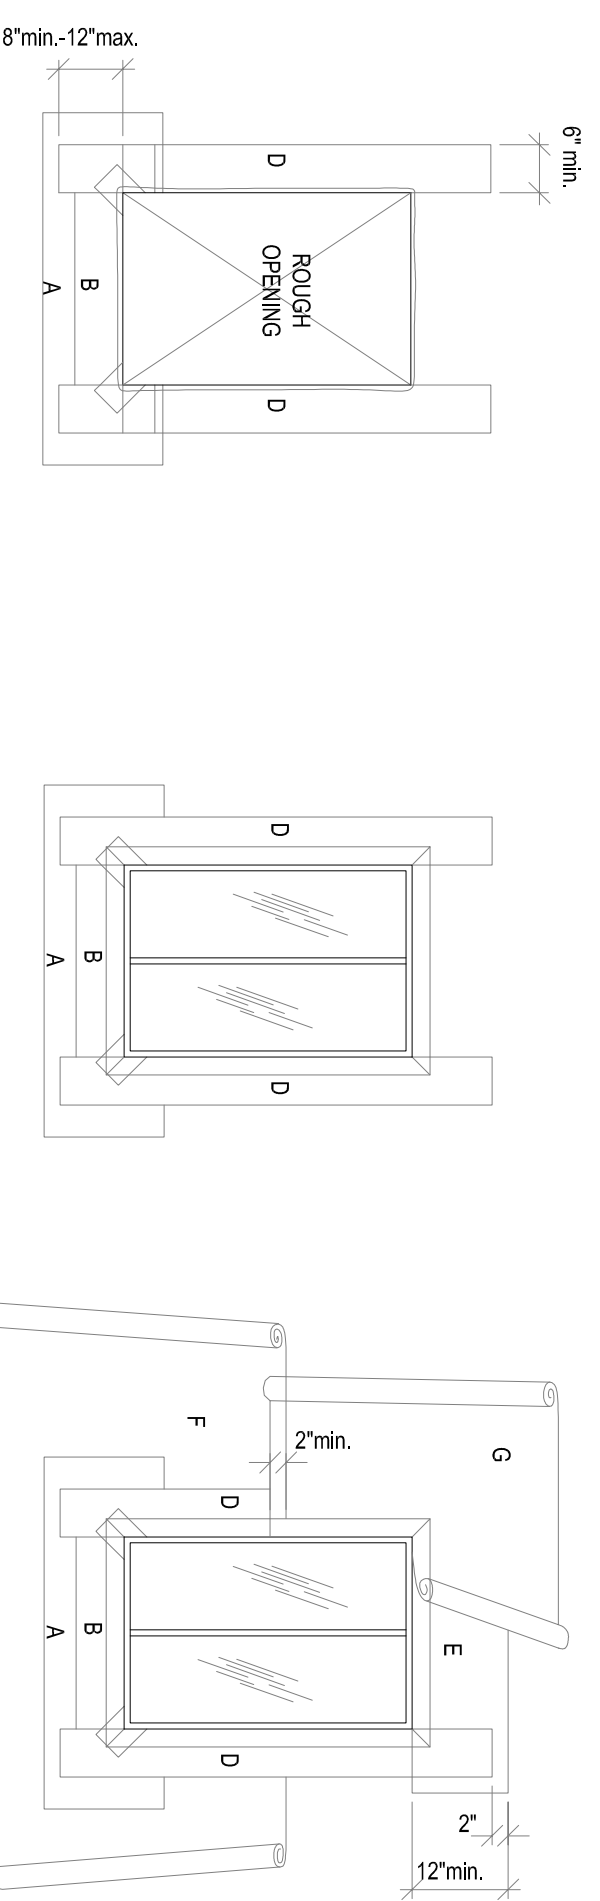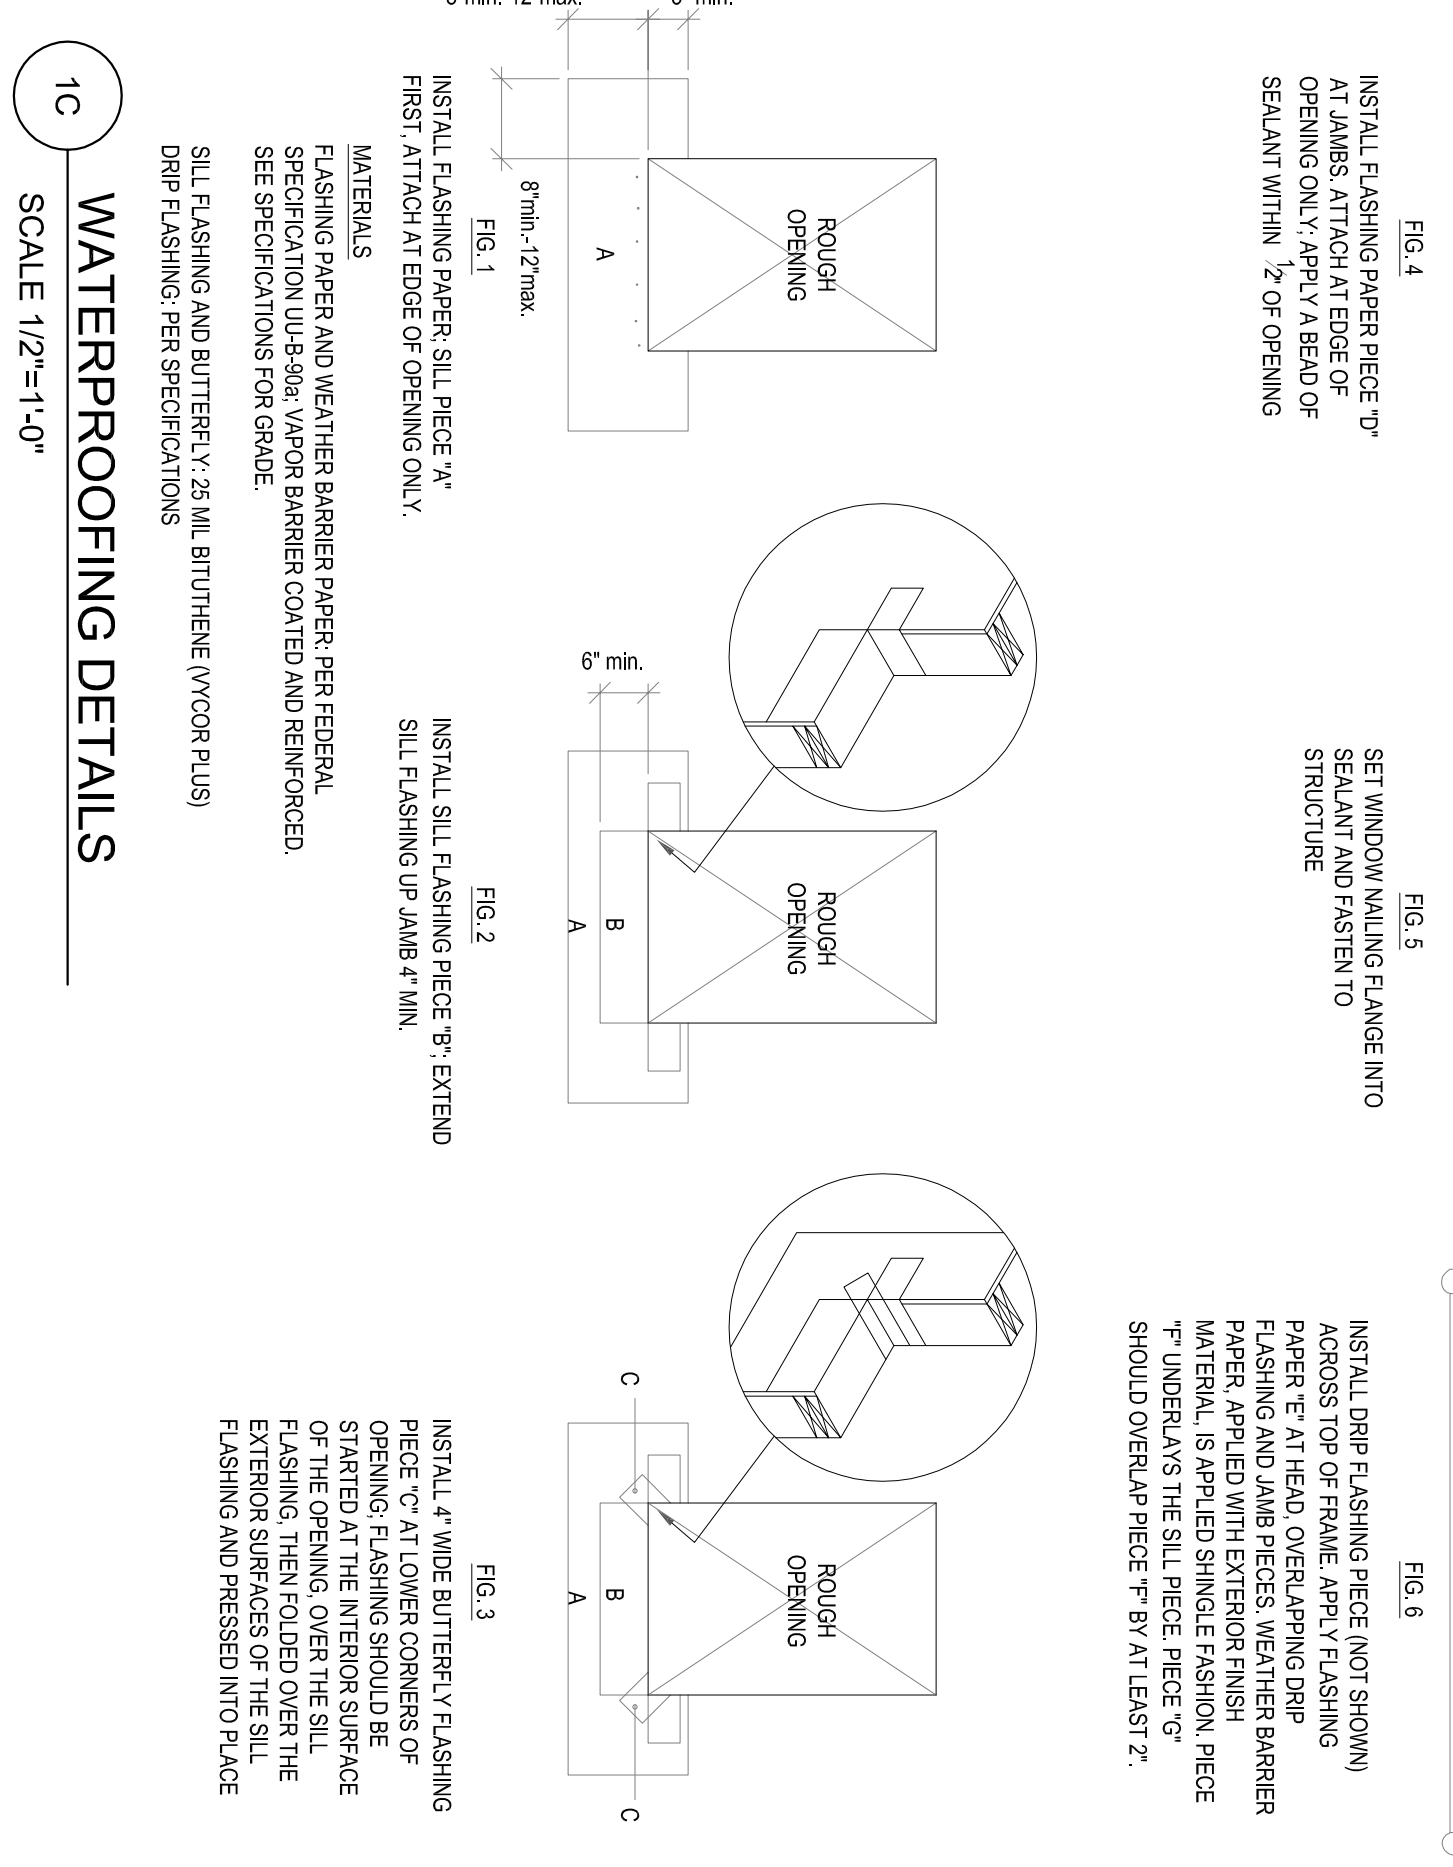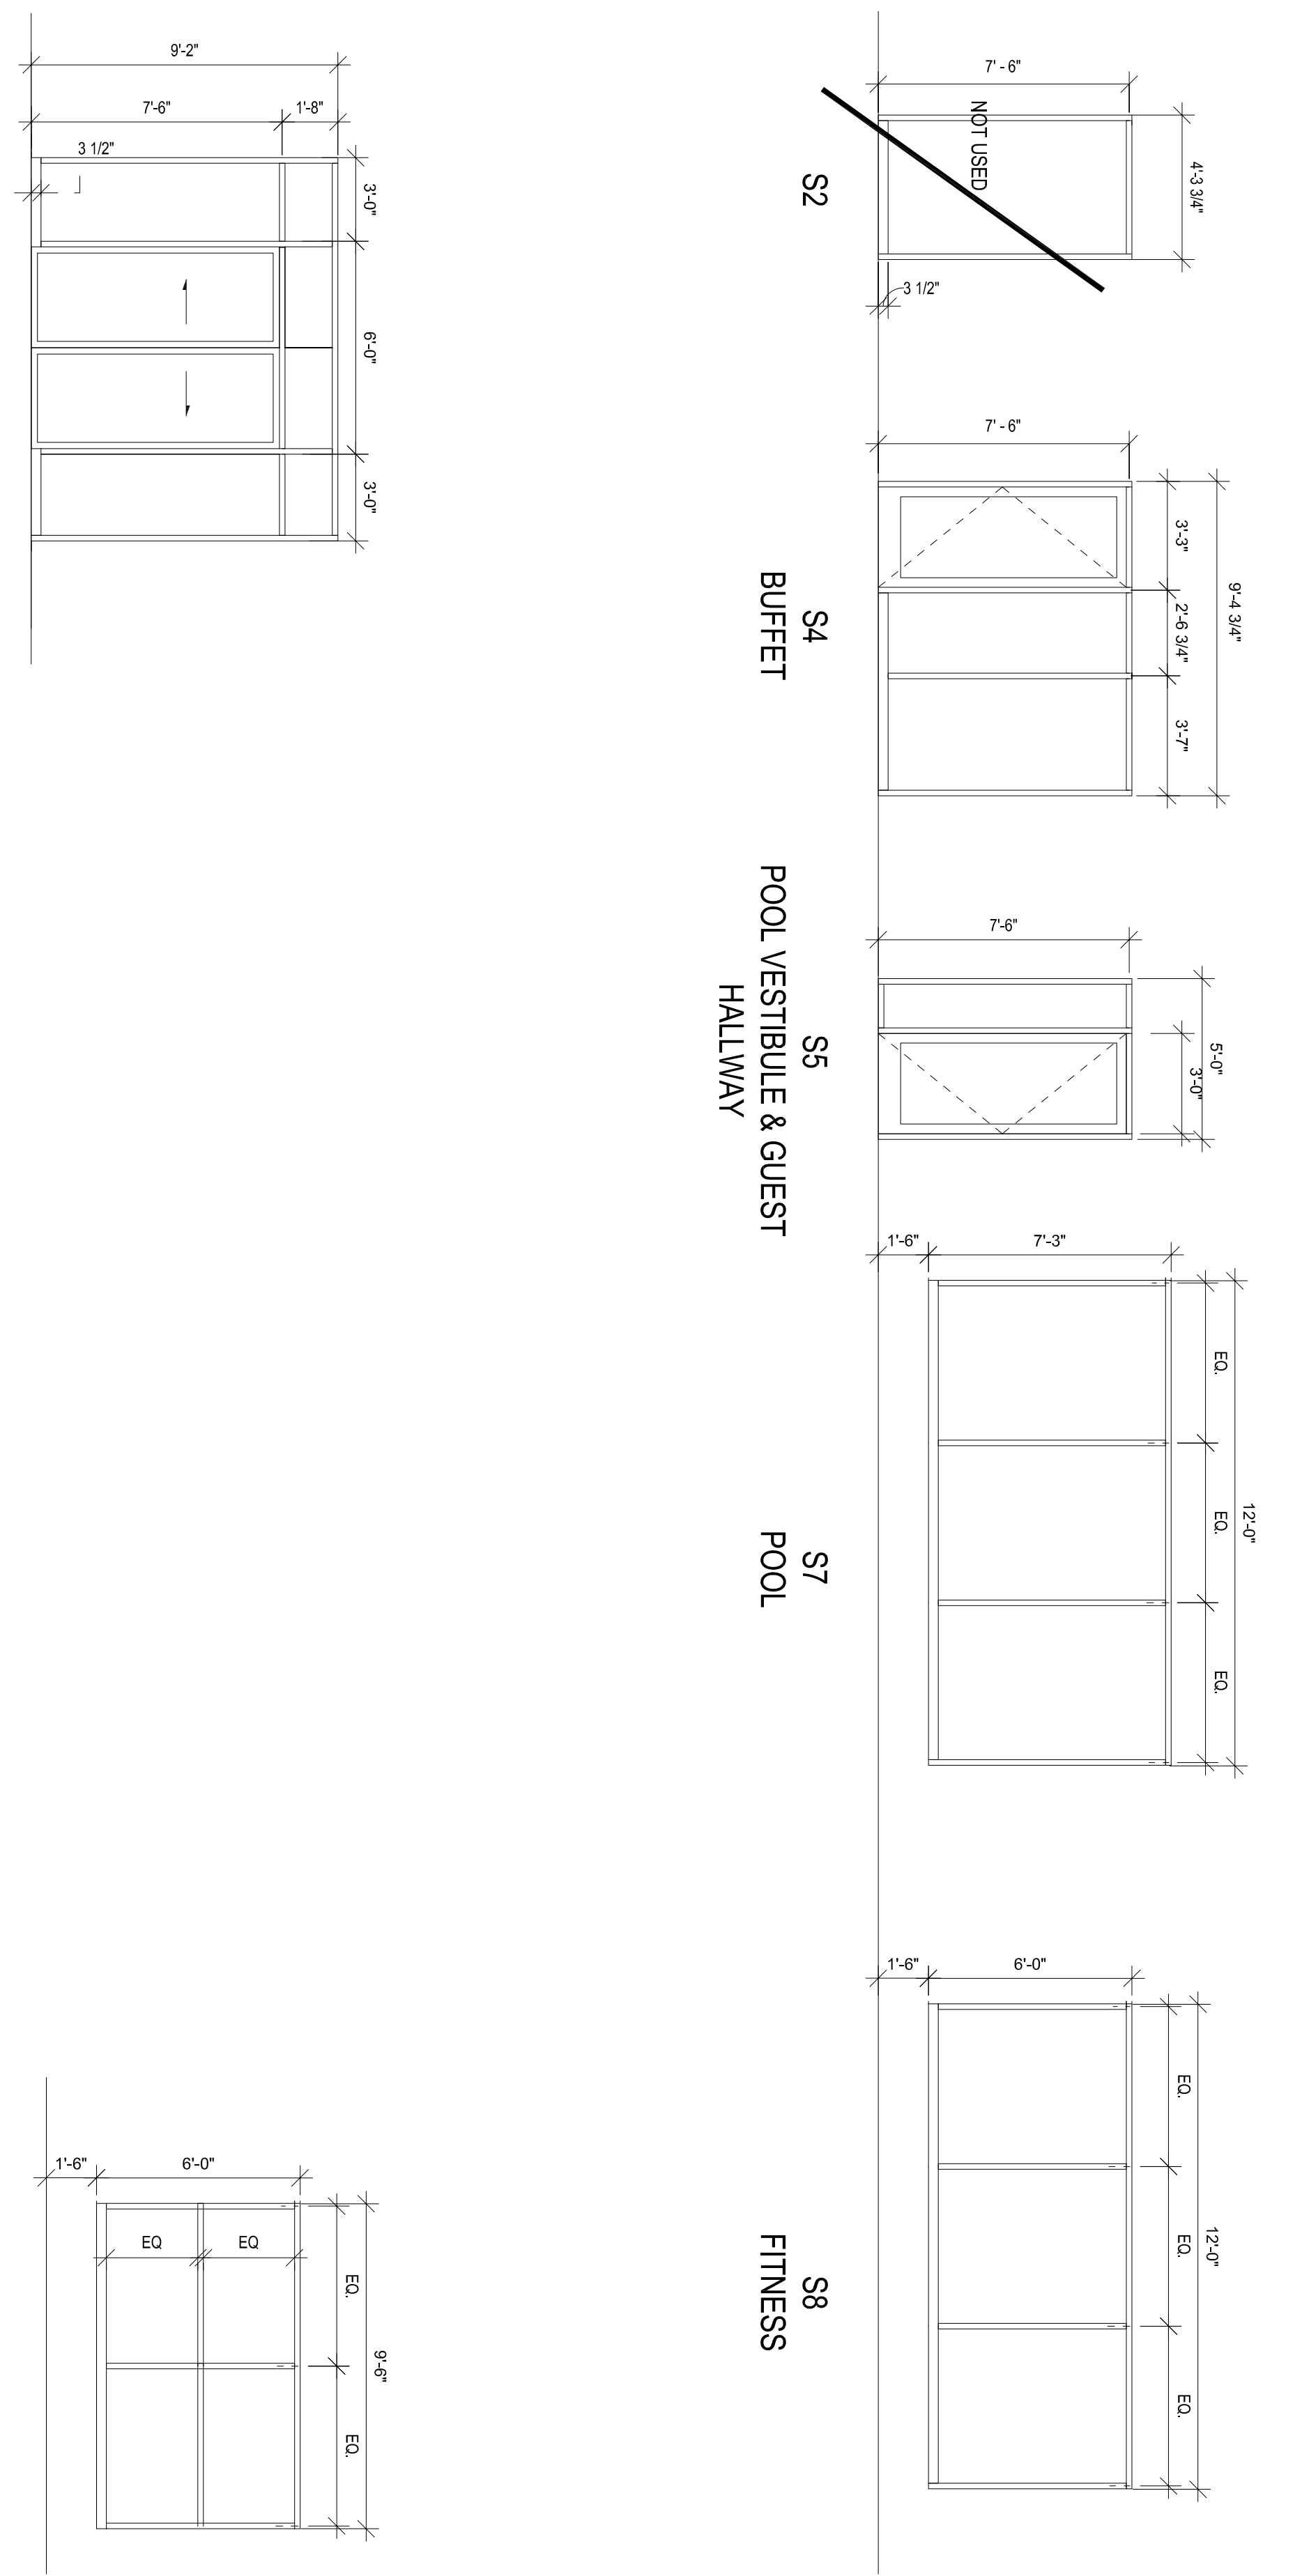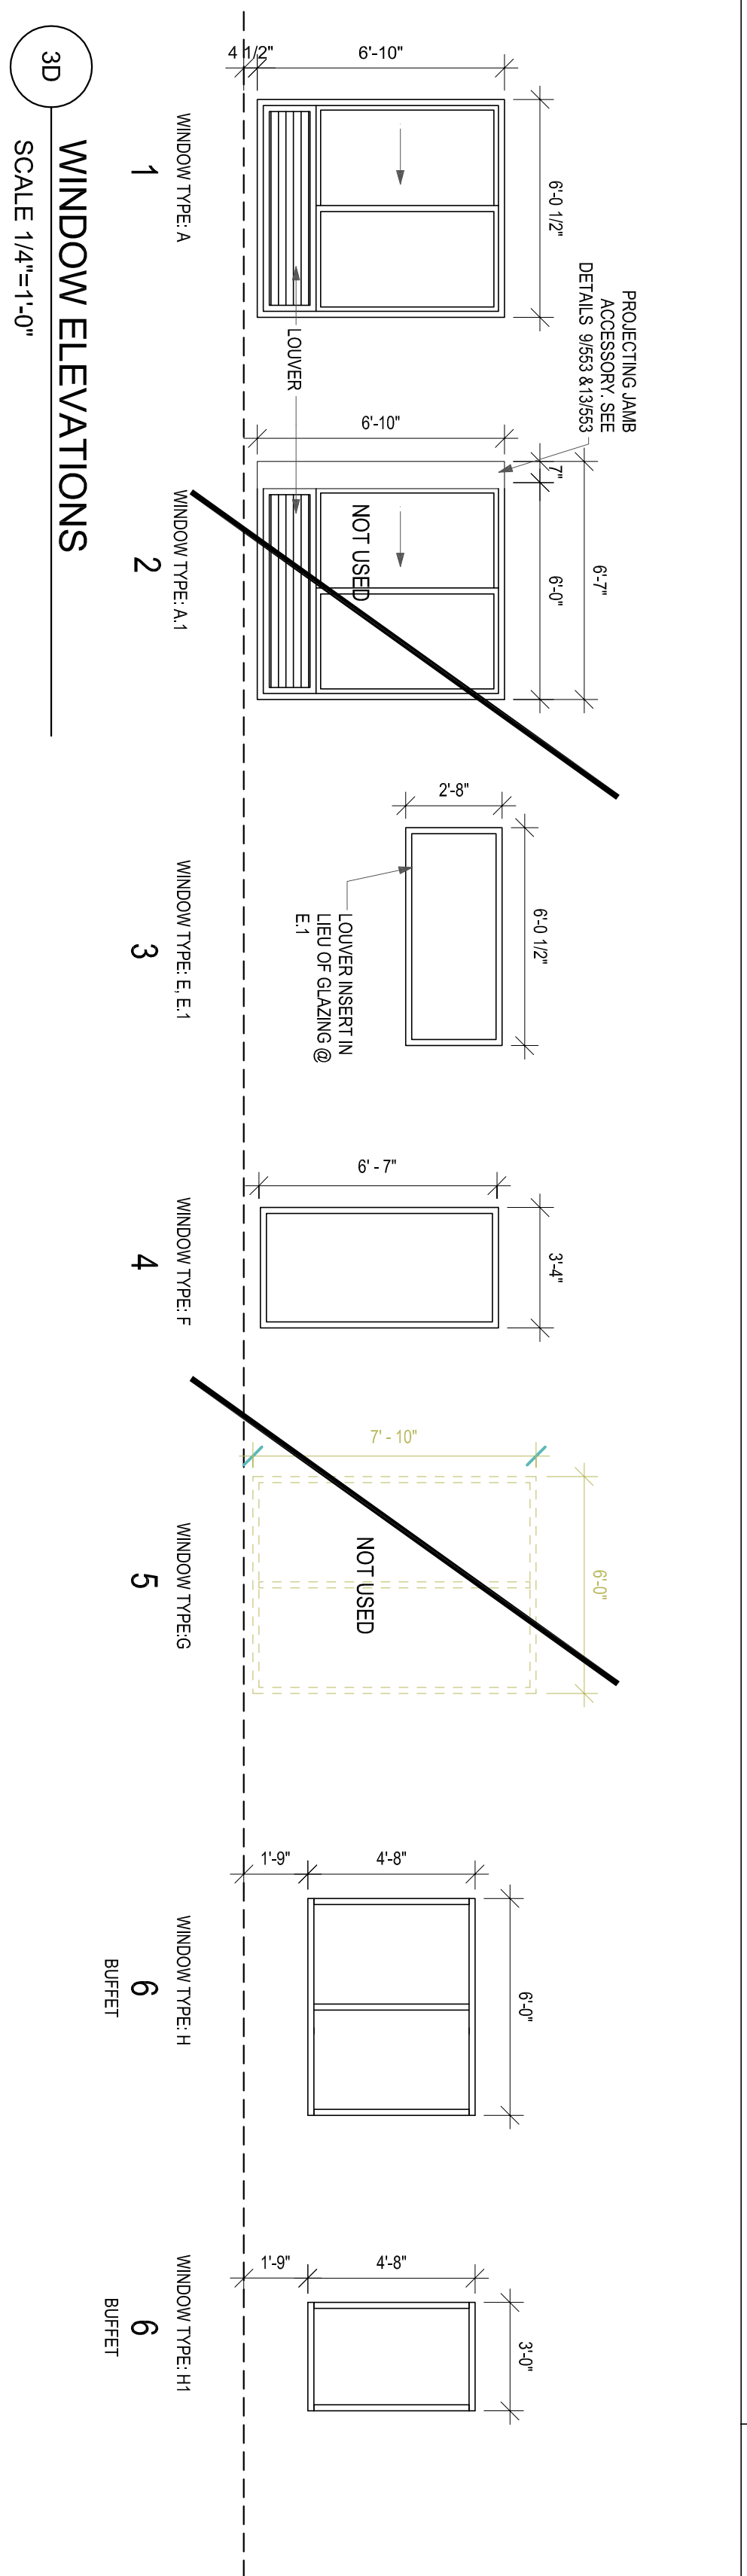

**3A STOREFRONT ELEVATIONS**

